



614.464.6400 | vorys.com

Founded 1909

Anna Sanyal Direct Dial (614) 464-5424 Email aasanyal@vorys.com

April 19, 2023

Ms. Tanowa M. Troupe, Secretary Public Utilities Commission of Ohio 180 E. Broad Street, 11th Floor Columbus, OH 43215-3793

Re: Clearview Solar Project

Case No. 20-1362-EL-BGN

Condition Compliance – Conditions 6, 8 - 11, 15, 22, 29, 32, and 33

Dear Ms. Troupe:

In compliance with Condition 5 of the August 25, 2021 Joint Stipulation and Recommendation filed in this proceeding (as approved by the Board's October 21, 2021 Opinion, Order, and Certificate), Clearview Solar, LLC confirms that construction of the Clearview Solar Project will occur on or around May 22, 2023. Clearview Solar also confirms that it has executed ISA and ICSA agreements with PJM Interconnection, LLC, in compliance with Condition 12.

Additionally, pursuant to various conditions, Clearview Solar confirms that it has submitted to Board Staff the following items:

- a construction phasing plan in compliance with Condition 6;
- detailed engineering drawings and mapping in compliance with Conditions 8 and 9 (copy attached);
- a final geotechnical engineering report in compliance with Conditions 8, 9, and 10;
- final stormwater and drainage plans pursuant to Condition 9;
- a final complaint resolution plan in compliance with Condition 11 (copy attached);
- a perimeter fence type in compliance with Condition 15;
- credentials for the environmental specialist who will be on site during construction activities that may affect sensitive areas in compliance with Condition 22;
- an emergency response plan in compliance with Condition 29;
- a final transportation management plan in compliance with Condition 32; and
- an updated decommissioning plan in compliance with Condition 33.



April 19, 2023 Page 2

Please call me if you have any questions.

Very truly yours,

Moanyal

Anna Sanyal Counsel for Clearview Solar I, LLC

AS/jaw Enclosure

Andrew Conway cc: Tom Healy



CLEARVIEW SOLAR PROJECT

CHAMPAIGN COUNTY, OH 90% CIVIL DESIGN



SHEET SET NUMBER	SHEET TITLE	REV NO.	DATE
C0002	CIVIL NOTES	С	04/11/2023
C0003	OVERALL SITE PLAN	С	04/11/2023
C0004	SITE GRADING & DRAINAGE PLAN	В	04/11/2023
C0005	OVERALL SITE PREPARATION PLAN	С	04/11/2023
C0007	FENCE & ACCESS PLAN DETAILS	В	04/11/2023
C0008	EROSION CONTROL PLAN	В	04/11/2023
C0011	EXISTING SITE CONDITIONS	С	04/11/2023

PRO	JECT SUMMARY
PROJECT PARCEL NUMBERS	A01-01-13-33-00-001-00, A01-01-13-33-00-002-00, A01-01-13-33-00-005-00, A01-01-13-33-00-006-00, A01-01-13-32-00-015-00, A01-01-13-33-00-013-00, A01-01-13-33-00-012-00, A01-01-13-33-00-011-01, A01-01-13-33-00-008 & A0101-13-33-00-009-00, A-01-01-13-27-00-005-000, A01-01-13-27-00-007-00, A01-01-13-27-00-010-00, A01-01-13-27-00-013-00, A01-01-13-27-00-014-00 & A01-01-13-26-00-001-00, A01-01-13-27-00-016-01, A01-01-13-27-00-019-00, A01-01-13-27-00-015-01, A01-01-13-26-00-007-00
PROPERTY ACREAGE	1,464.8 ACRES
PROJECT AREA	874.5 ACRES
LATITUDE/LONGITUDE	40.263148/ -83.994269
SYSTEM SIZE (DC)	195.8 MW
SYSTEM SIZE (AC)	144 MW
PERMANENT ROAD LENGTH	± 51,762 LINEAR FEET
TEMPORARY ROAD LENGTH	± 2,934 LINEAR FEET
FENCE LENGTH	± 61,575 LINEAR FEET
TEMPORARY SILT FENCE LENGTH	± 34,062 LINEAR FEET
LAYDOWN AREA ACREAGE	22.6 ACRES
CUT VOLUME	± 39,583 CUBIC YARDS
FILL VOLUME	± 34,455 CUBIC YARDS
NET CUT/FILL	± 5,128 CUBIC YARDS (CUT)

FEATURE SETBACK FROM PUBLIC ROADS SETBACK FROM NON-PARTICIPATING PROPERTY LINES SETBACK FROM NON-PARTICIPATING RESIDENCES SETBACK FROM STREAMS & WETLANDS SETBACK FROM PIPELINES SETBACK FROM PIPELINES SETBACK FROM TRANSMISSION LINES SETBACK FROM SUBSTATION PARCEL SETBACK FROM SUBSTATION PARCEL SETBACK PROM SUBSTATION PARCEL
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SETBACK FROM PIPELINES 25 FEET SETBACK FROM TRANSMISSION LINES 100 FEET
SETBACK FROM TRANSMISSION LINES 100 FEET
SETBACK FROM SUBSTATION PARCEL AVOID
SETBACK FROM NO SOLAR PANEL AREAS AVOID
SETBACK FROM EXCLUSION ZONES AVOID
SETBACK FROM WATER WELLS 150 FEET
SETBACK FROM FORESTRY AREAS 25 FEET

LOCATION MAP
SCALE: 1"=1000'

ROJECT DEVELOPER	PROPERTY LEASED TO				
	_				

PROJECT SCOPE

THIS DESIGN PACKAGE PROVIDES CIVIL DRAWINGS AND DETAILS FOR THE INSTALLATION OF A UTILITY SCALE SOLAR PHOTOVOLTAIC SYSTEM IN THE STATE OF OHIO, INCLUDING TEMPORARY AND PERMANENT STORMWATER & EROSION & SEDIMENT CONTROL FEATURES. THIS DRAWING SET IS FOR CONCEPTUAL AND NOT FOR CONSTRUCTION.

APPLICABLE CODES & STANDARDS

- NATIONAL FIRE PROTECTION ASSOCIATION (NFPA)
- NFPA 855 (REFERENCE ONLY)

CLEARVIEW SOLAR I, LLC

- 2020 INTERNATIONAL BUILDING CODE (IBC) 2020 INTERNATIONAL FIRE CODE (IFC)
- OHIO POWER SITING BOARD CASE NUMBER 20-1362-EL-BGN
- OHIO ENVIRONMENTAL PROTECTION AGENCY: GUIDANCE ON POST CONSTRUCTION STORM WATER CONTROLS FOR SOLAR PANEL ARRAYS, OCTOBER 2019
- 2006 OHIO DEPARTMENT OF NATURAL RESOURCES RAINWATER AND LAND DEVELOPMENT MANUAL

CLEARVIEW SOLAR I, LLC

2023 NATIONAL ELECTRICAL SAFETY CODE

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4	clearview_1ft_dwg NSRS11-South_TT Surface.DWG									DRAWN:	R.DEMILIO	02/20/202	.3
3	0028621V-SURV_TT.DWG		С	ISSUED FOR 90% DESIGN	RCD	RCD .	IRW	MFR	04/11/2023	CUEOKED.		1	
2	0028621V-PLANIMET.DWG		В	ISSUED FOR 90% DESIGN	RCD	RCD .	IRW	MFR	04/11/2023	CHECKED:	J. WAKE	02/20/2023	3
1	CLEARVIEW SOLAR - SITE LAYOUT (144MWAC) - REV.7.DWG		Α	ISSUED FOR 30% DESIGN	RCD	RCD .	IRW	MFR	02/20/2023	APPROVED:	M.ROBINSC	0102/20/202	.3 23
DWG. NO.	REFERENCE DRAWINGS	REFERENCE DRAWINGS		REVISION DESCRIPTION	BY C	ESIGN C			DATE	CLIENT APP.:			

DRAWING

NOT TO BE **USED FOR** CONSTRUCTION

TETRA TECH 705-2317230200-DWG-C0002-C THE CONTENT OF THIS DOCUMENT IS NOT INTENDED FOR THE USE OF, NOR IS IT INTENDED TO BE RELIED UPON BY ANY PERSON, FIRM OR CORPORATION OTHER THAN THE CLIENT AND TETRA TECH CANADA INC

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CLEARVIEW SOLAR CIVIL NOTES

DRAWING NUMBER REV 705-2317230200-DWG-C0002 SHEET 1 OF 2

REVISION DESCRIPTION

REFERENCE DRAWINGS

DWG. NO.

REFERENCE DRAWINGS

DOCUMENT CONTROL NUMBER

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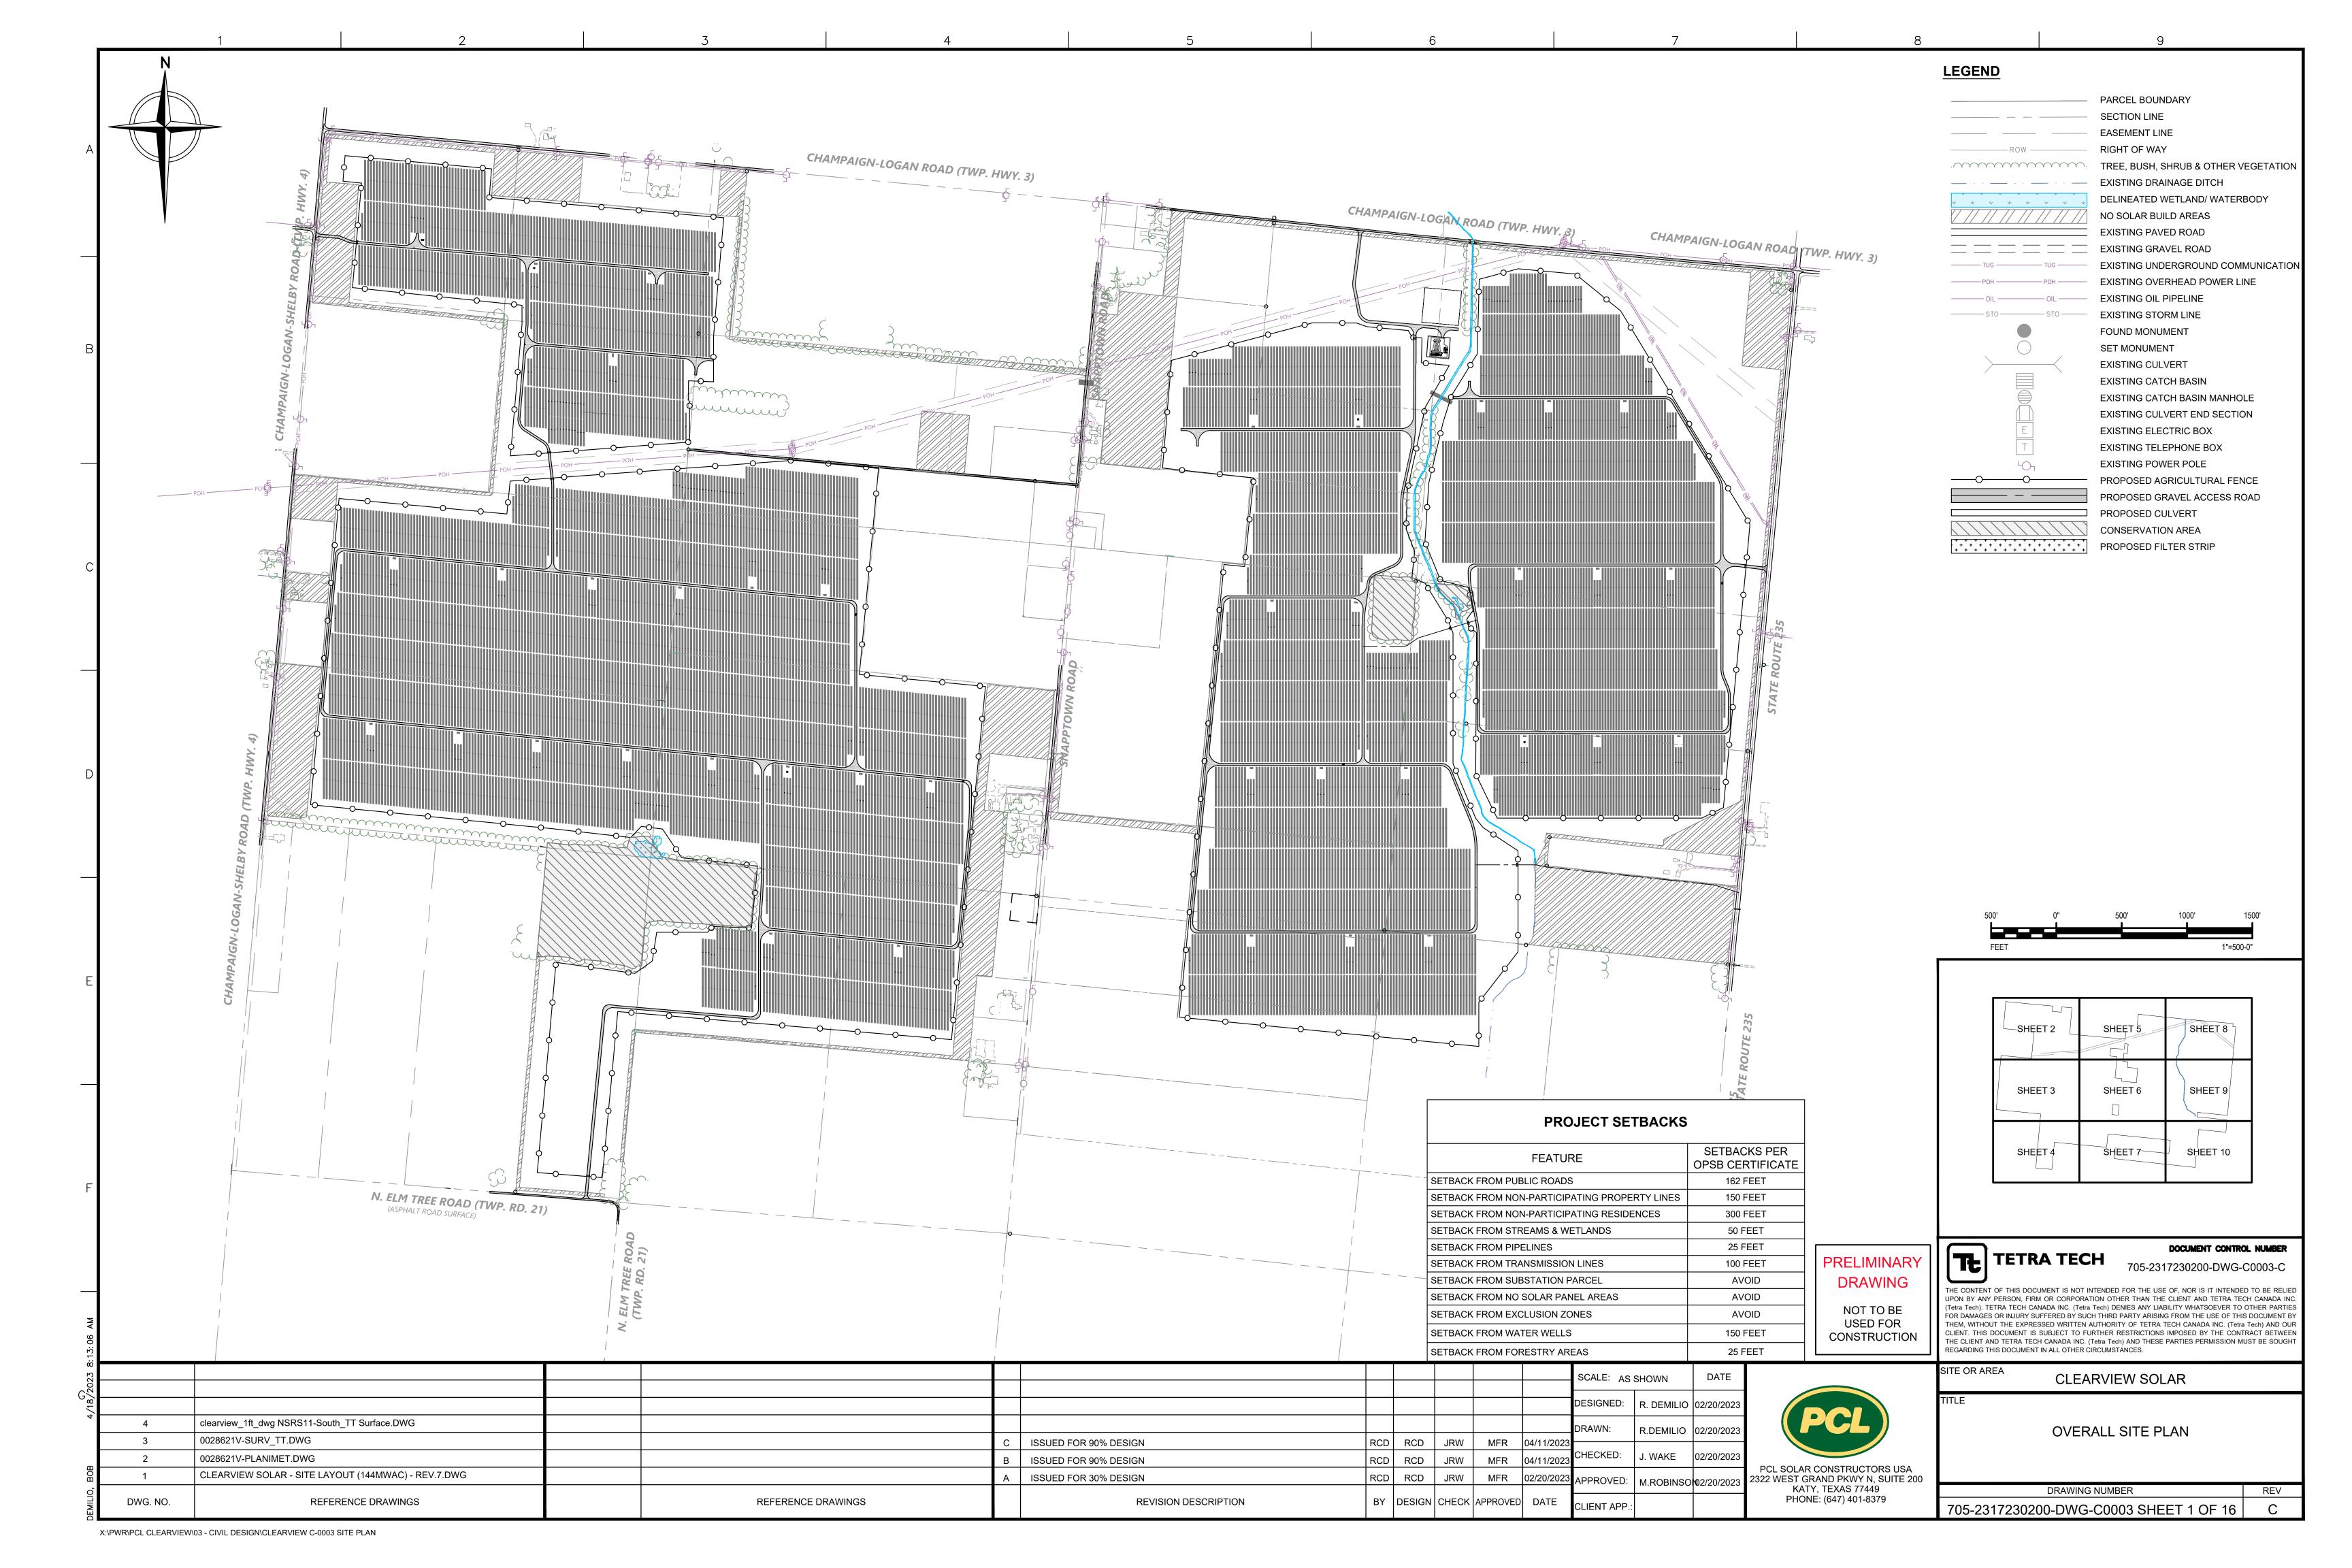
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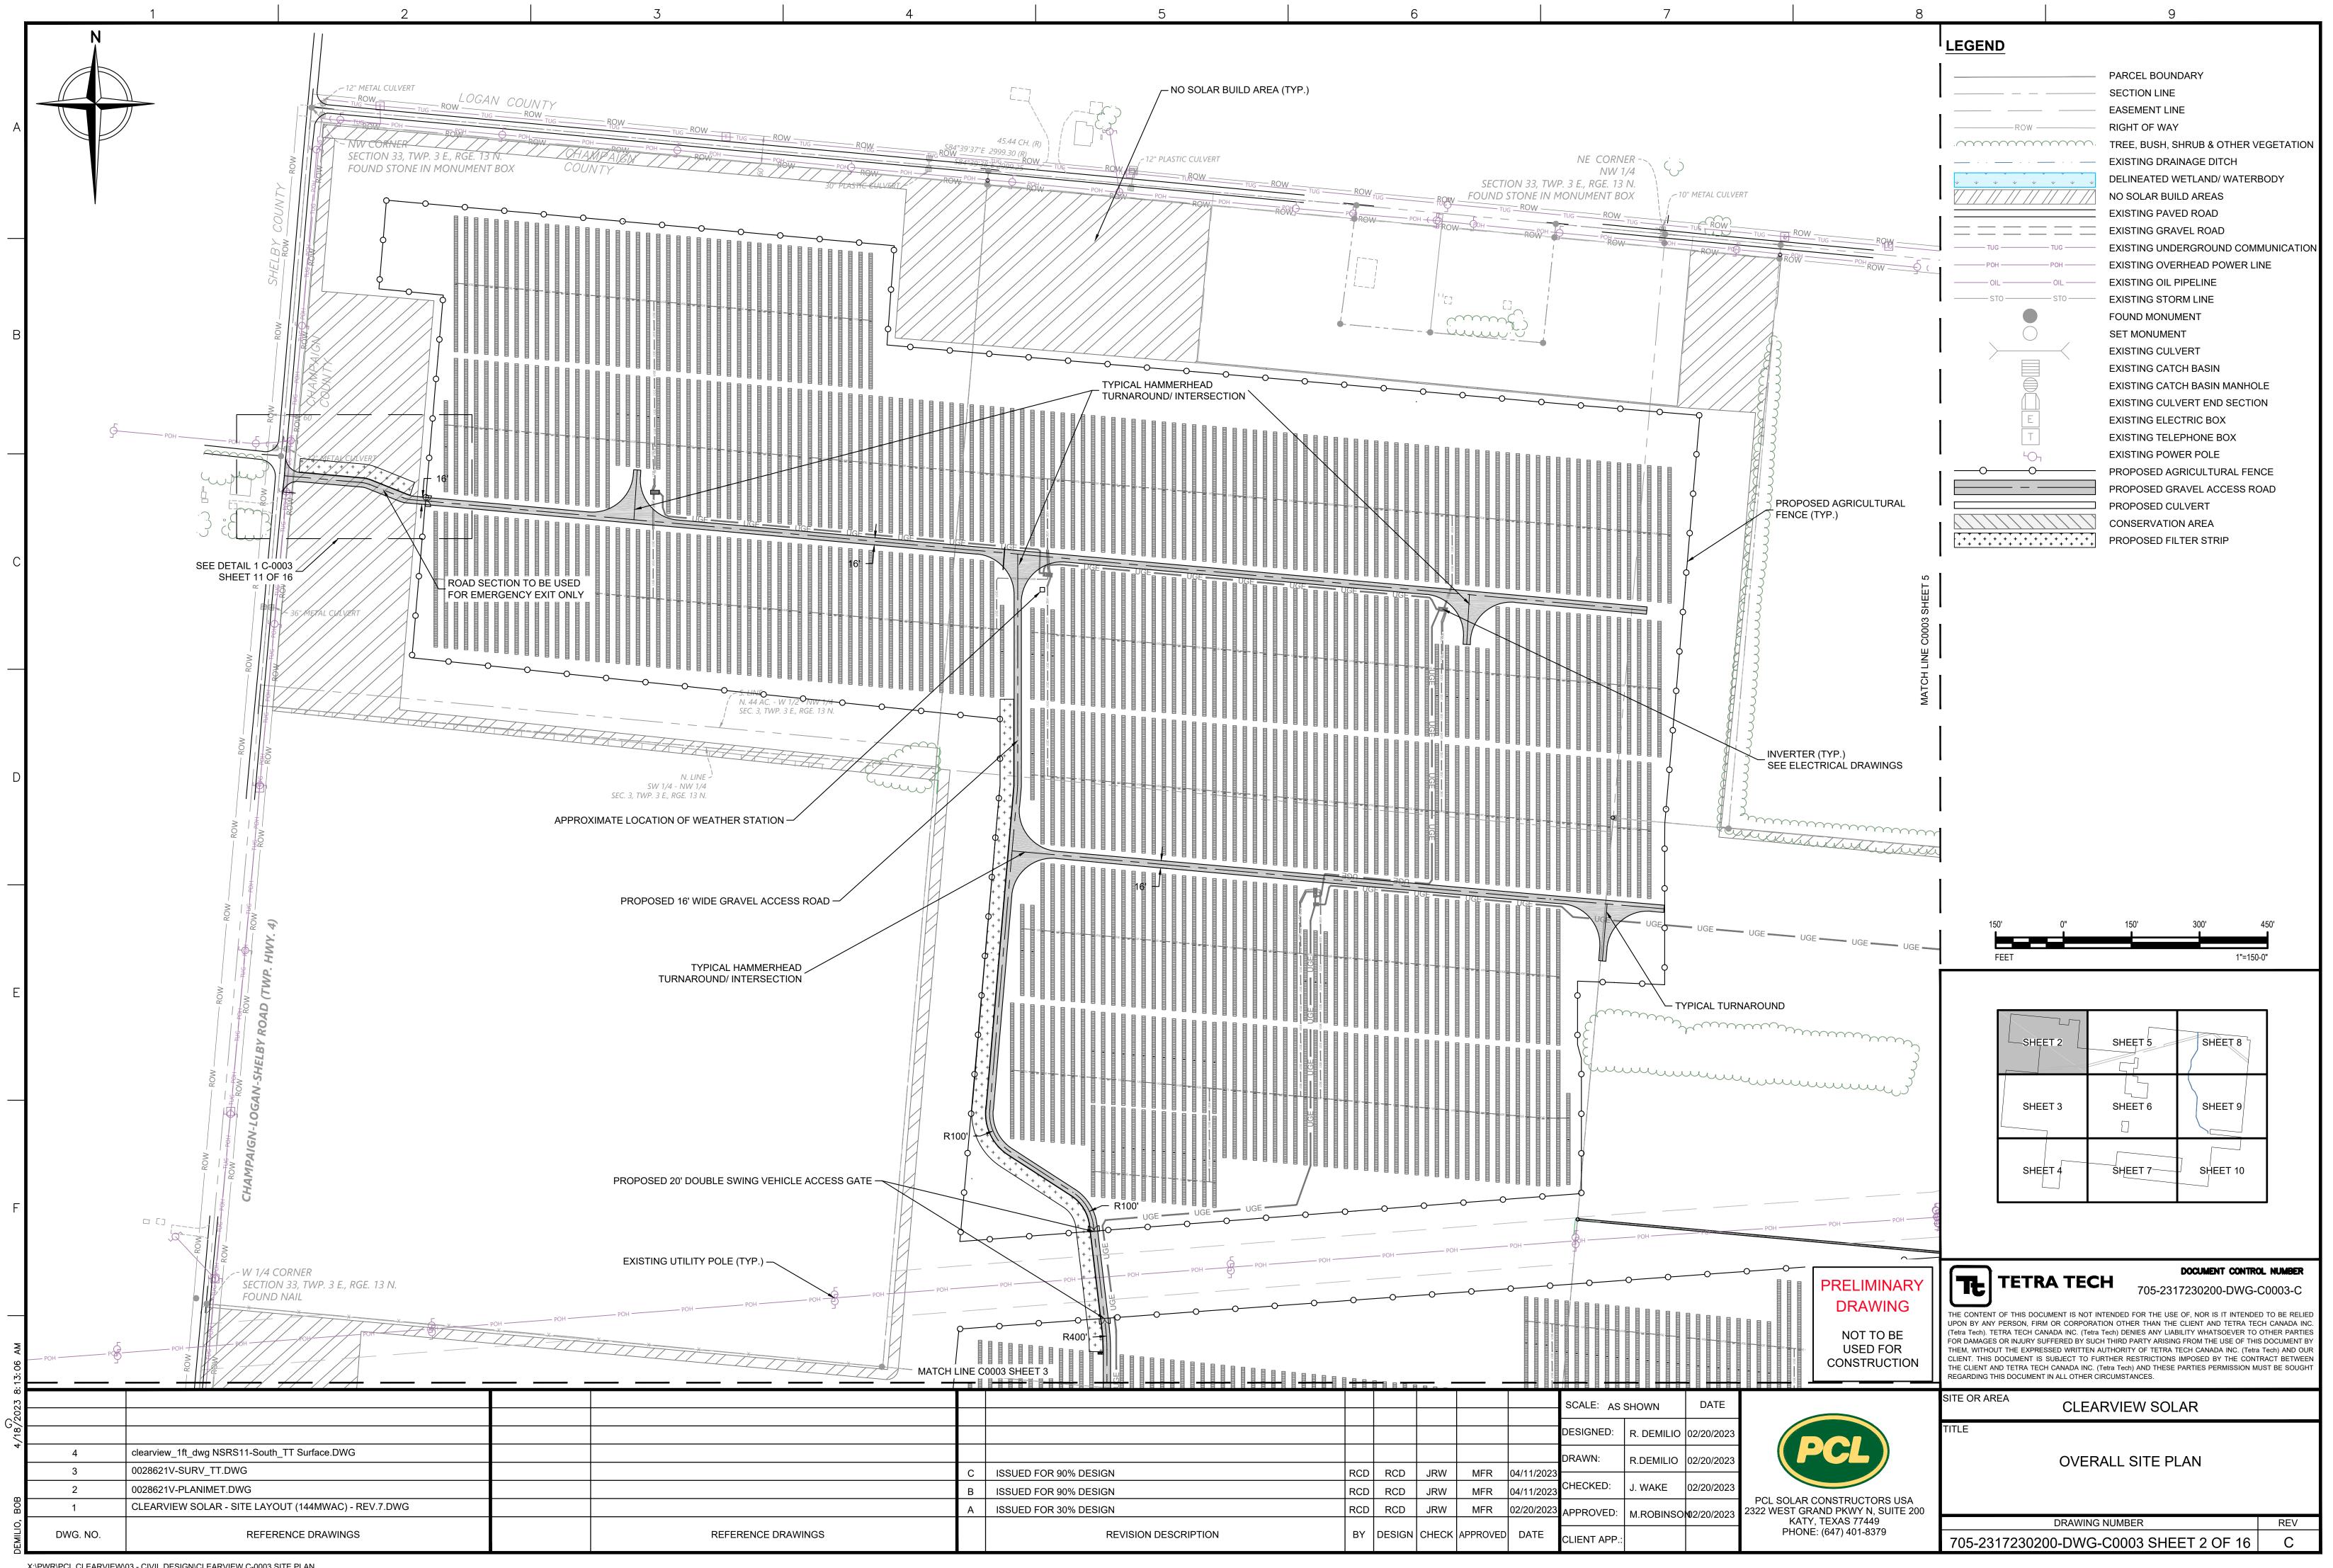
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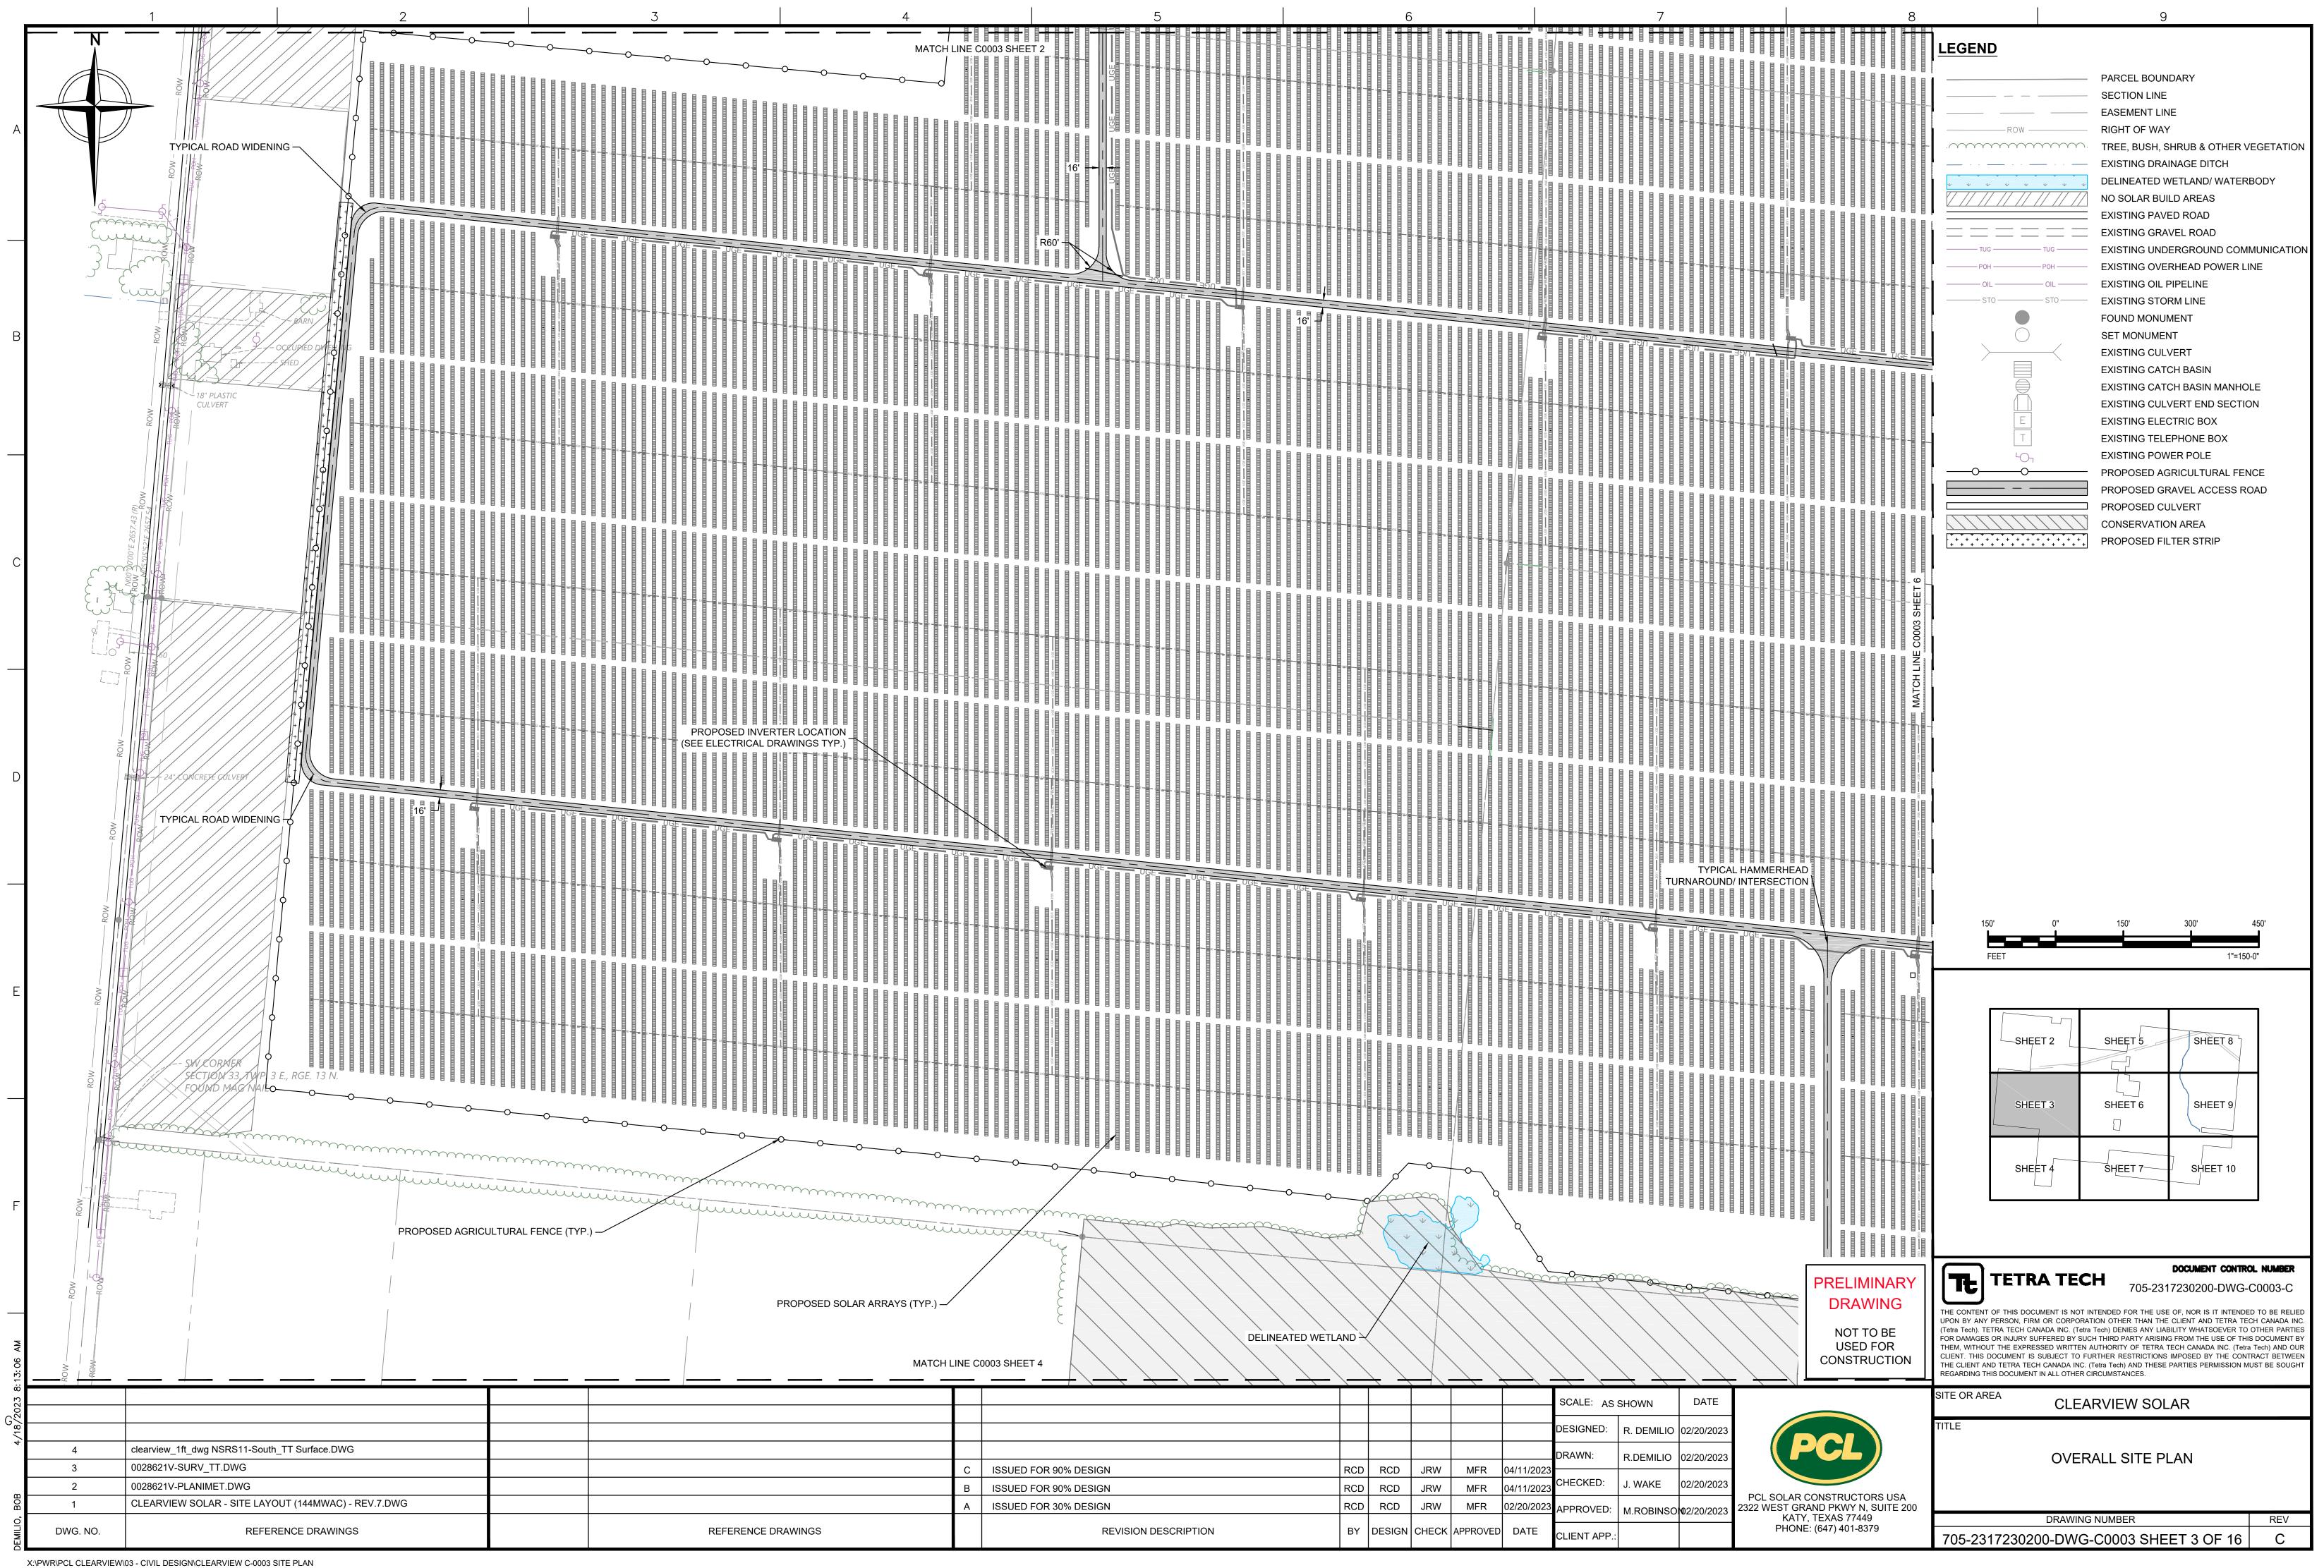
PHONE: (647) 401-8379


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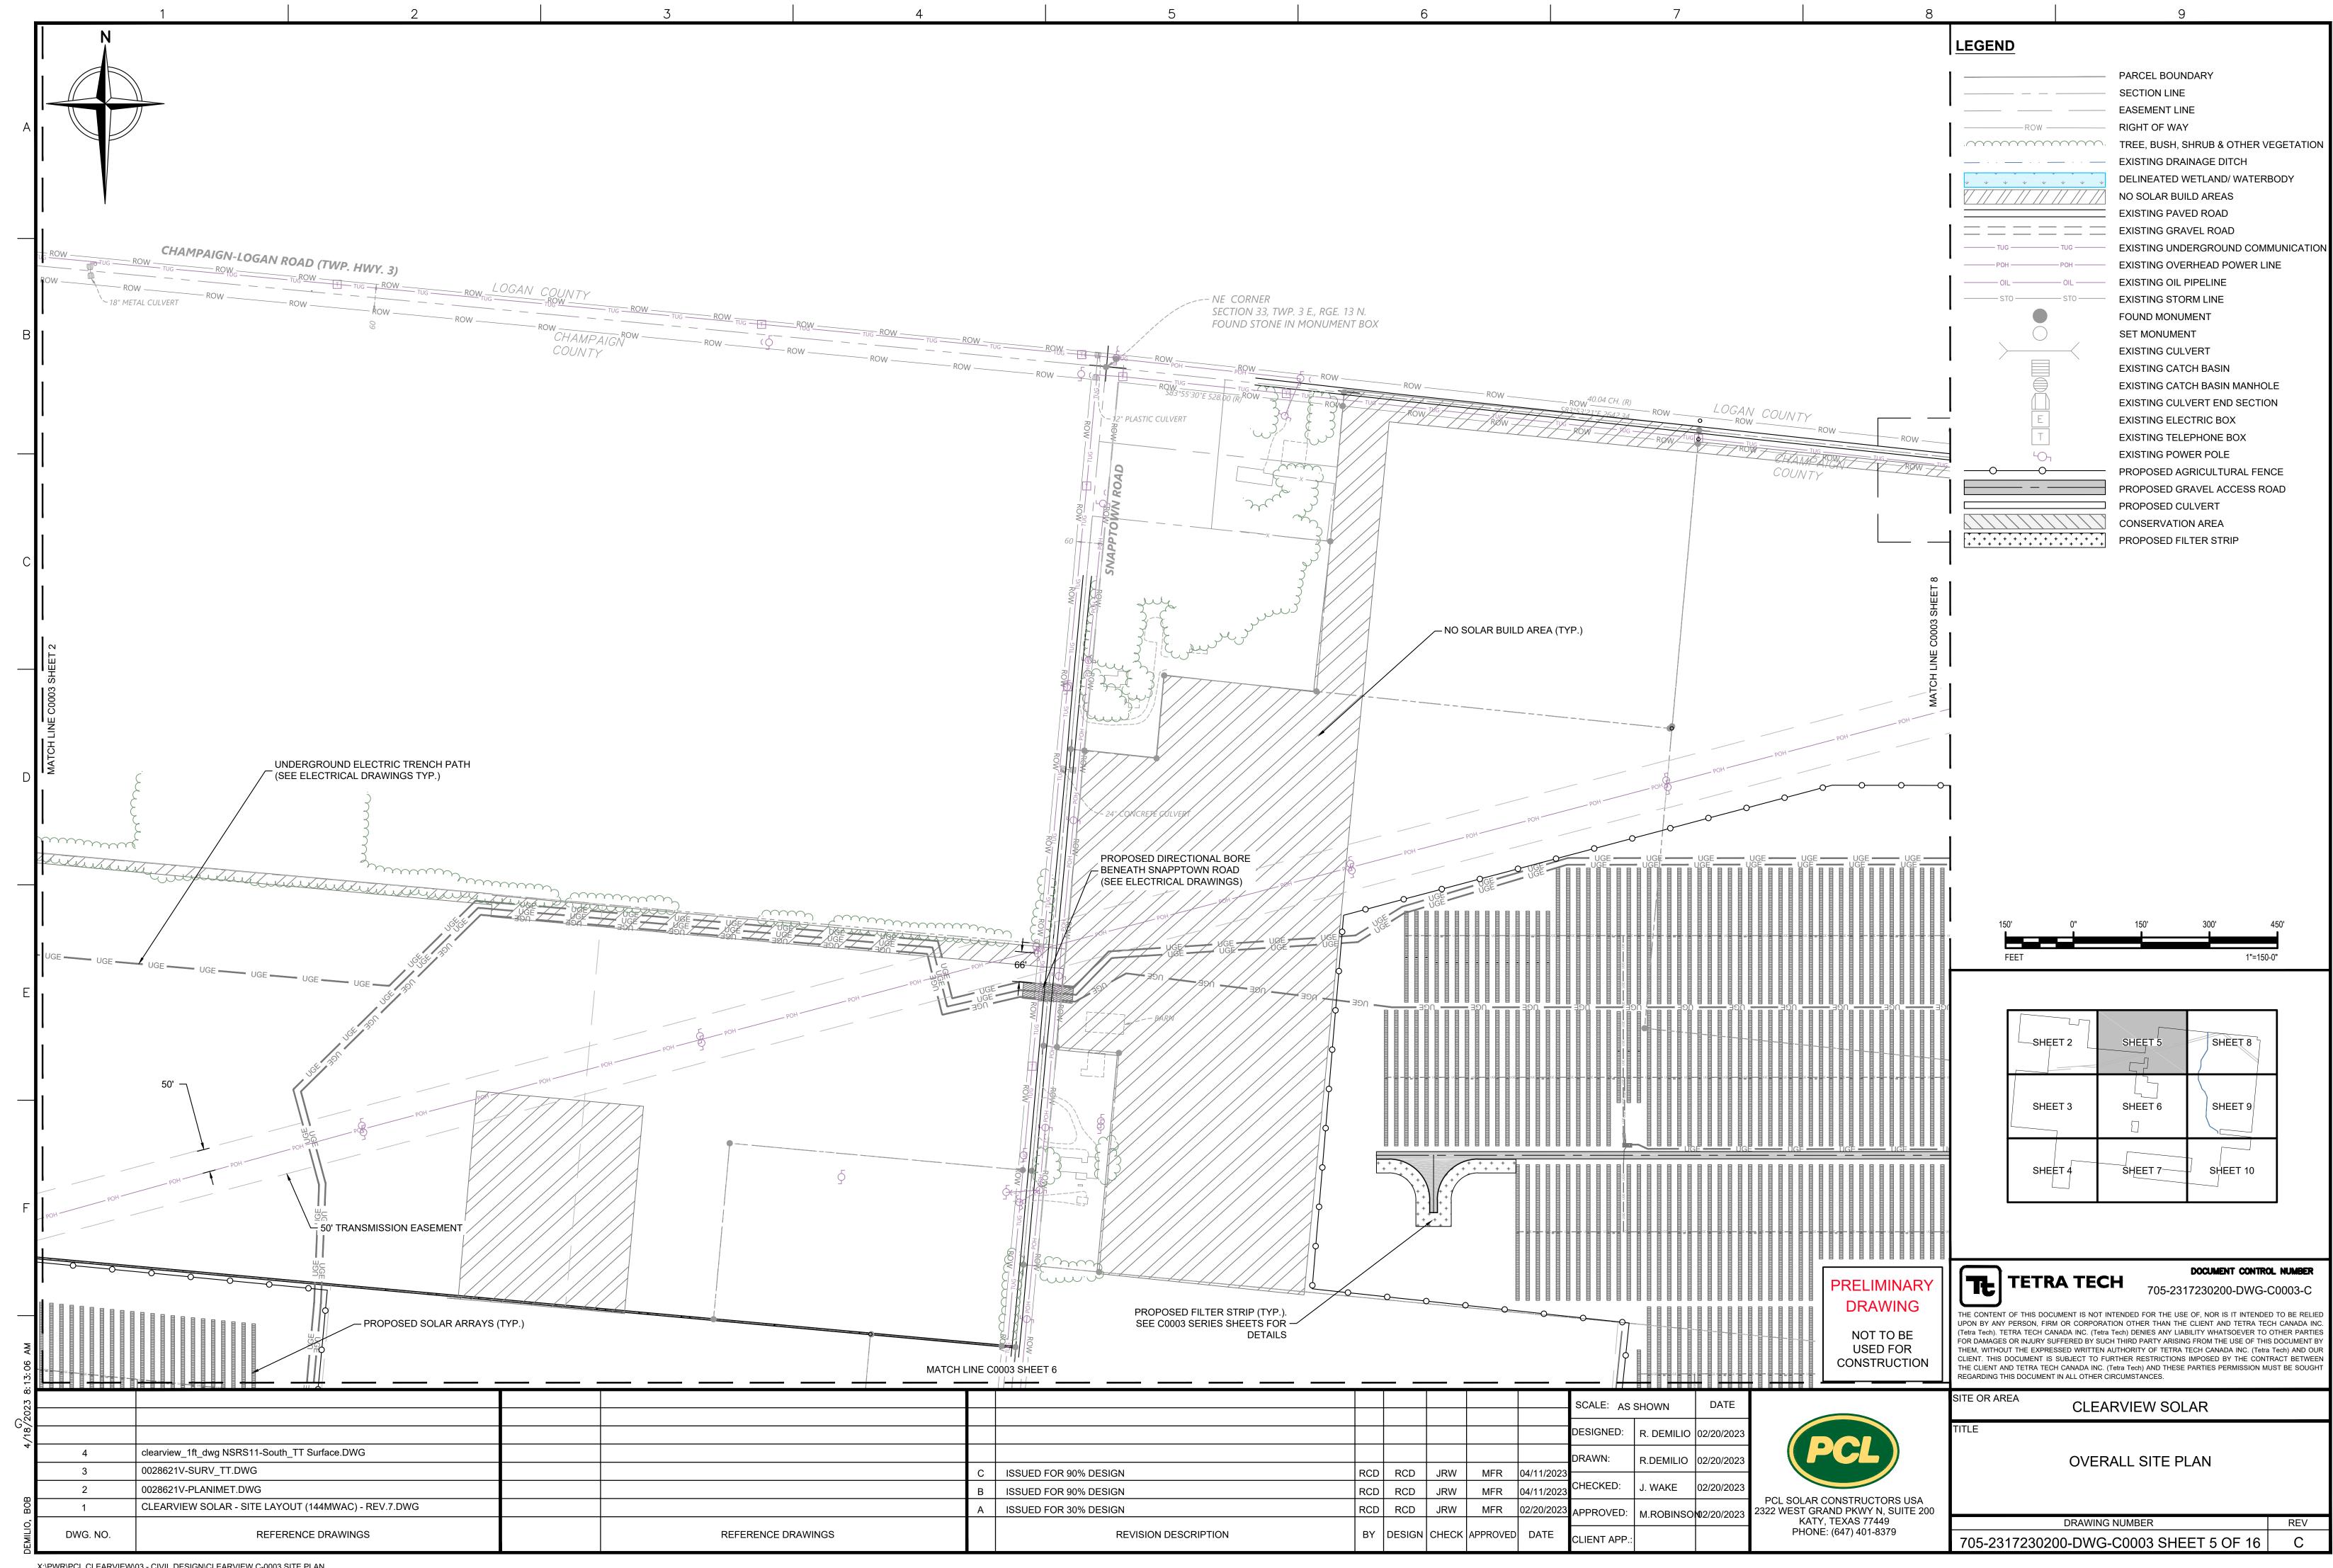
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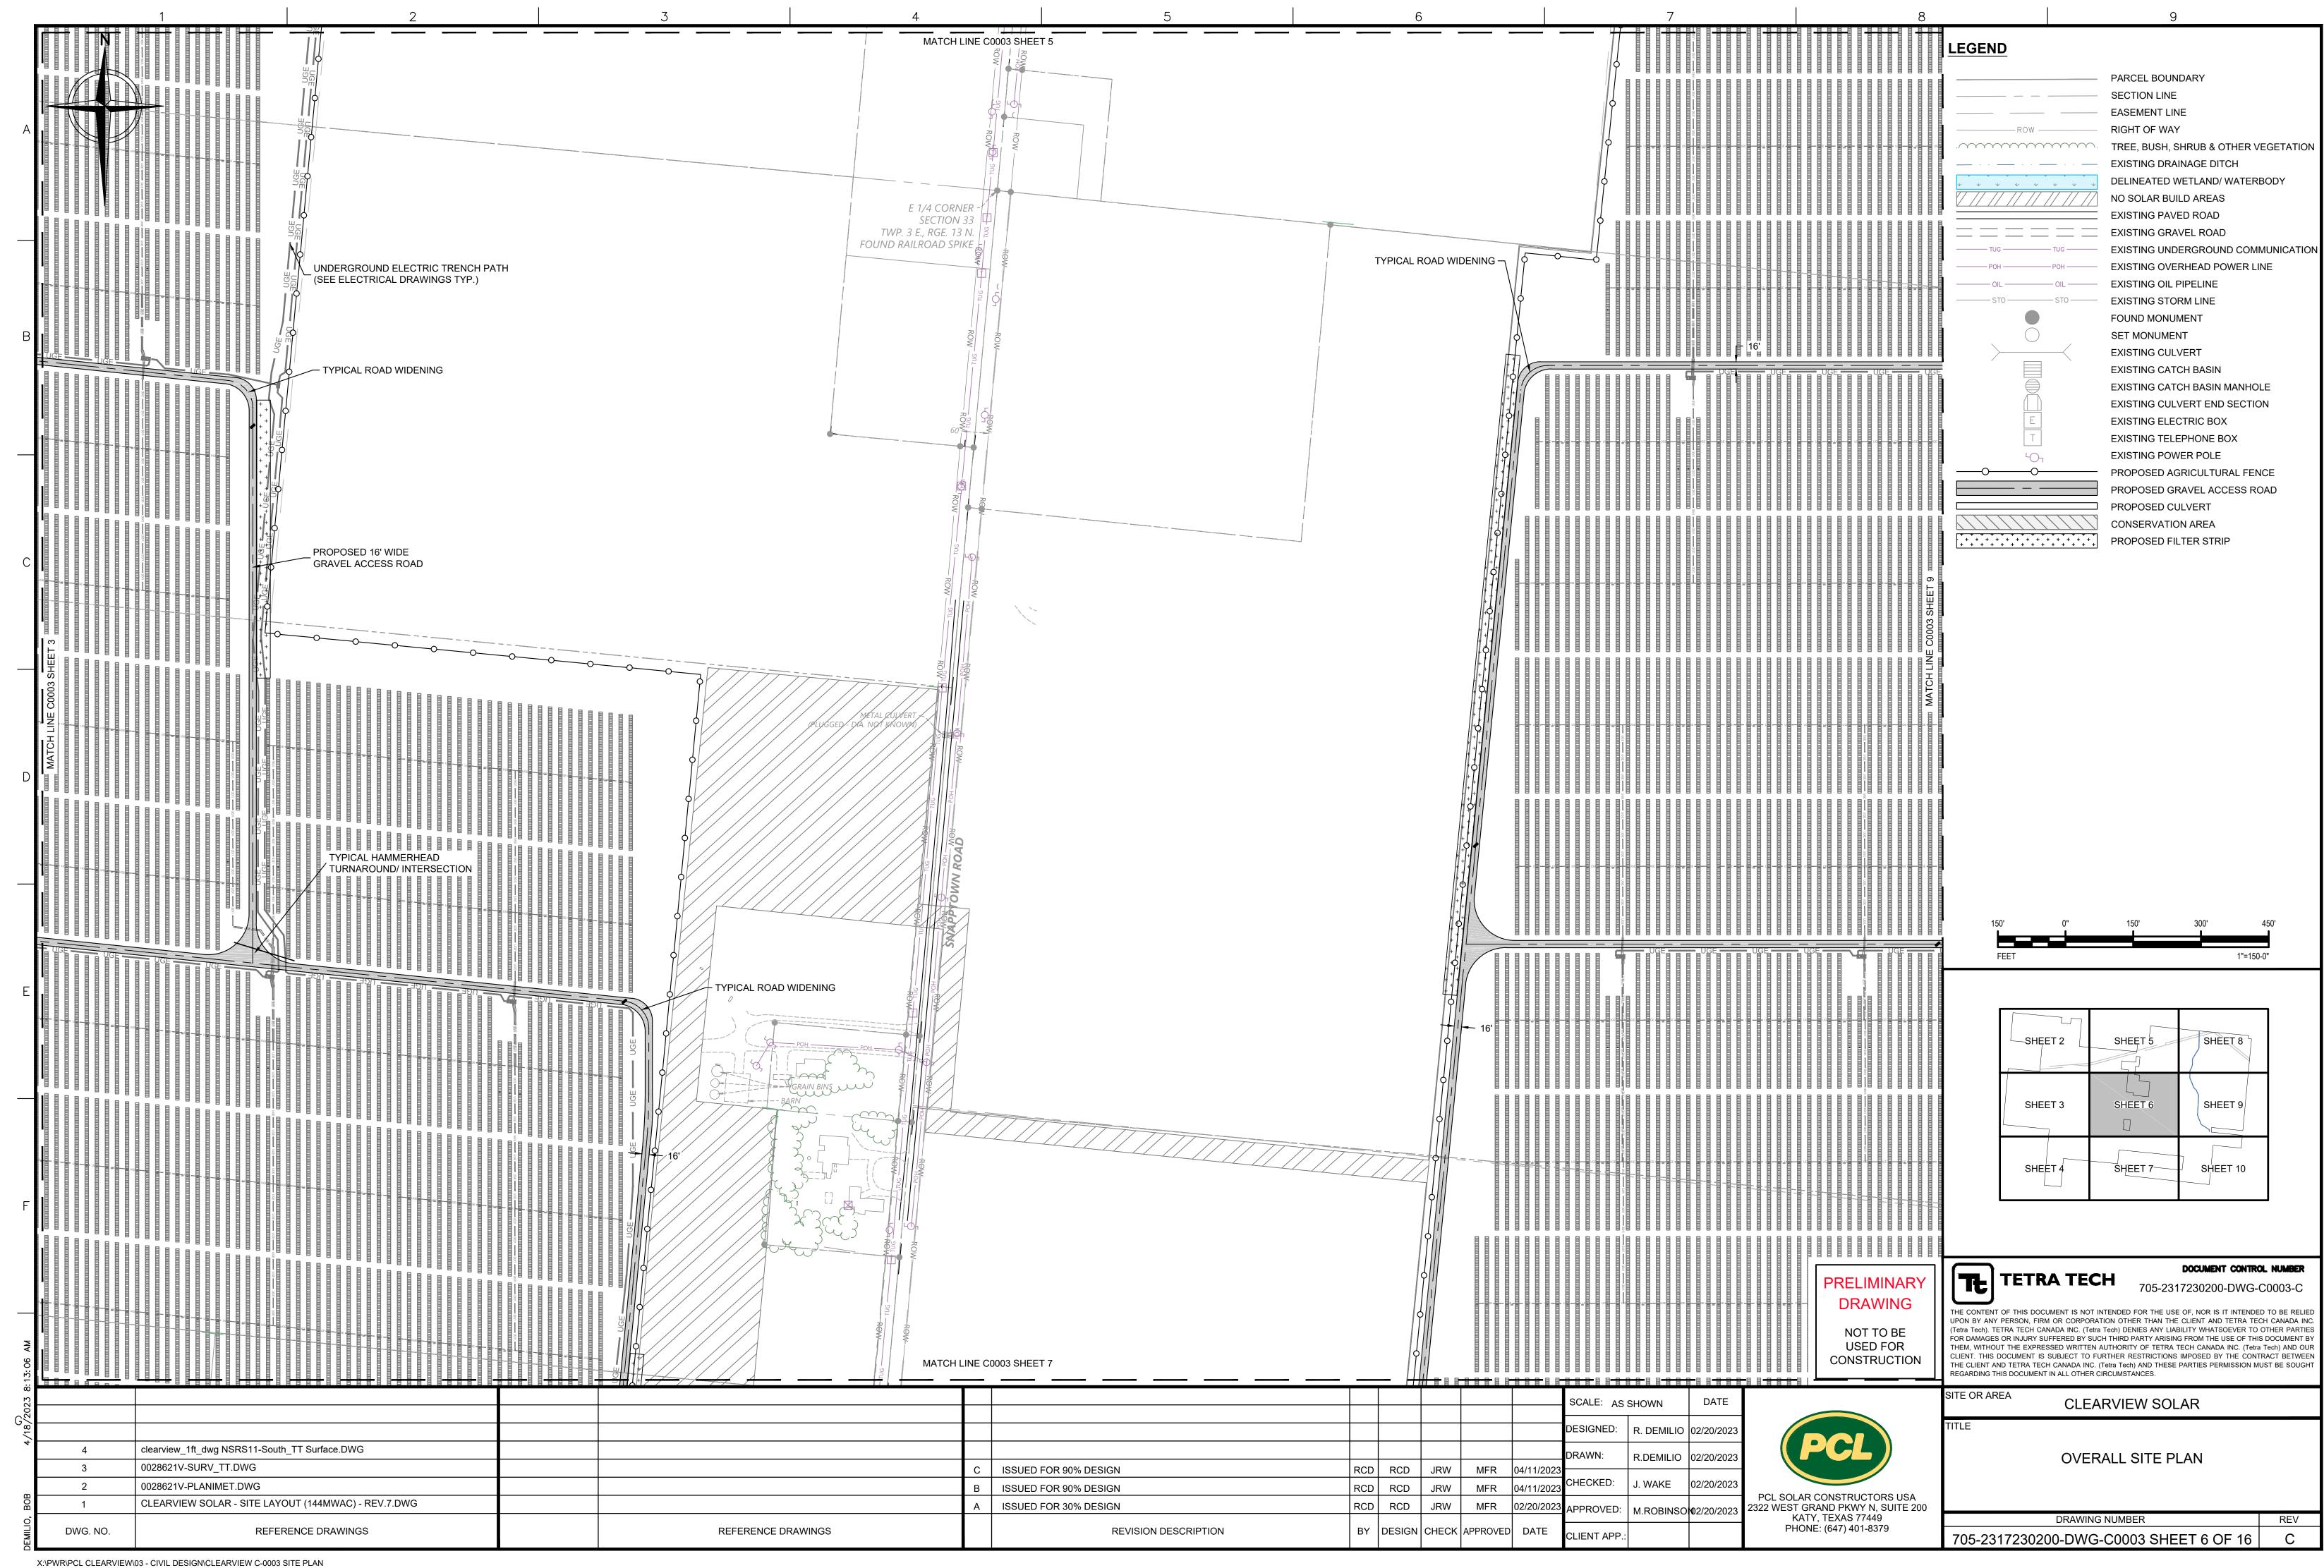














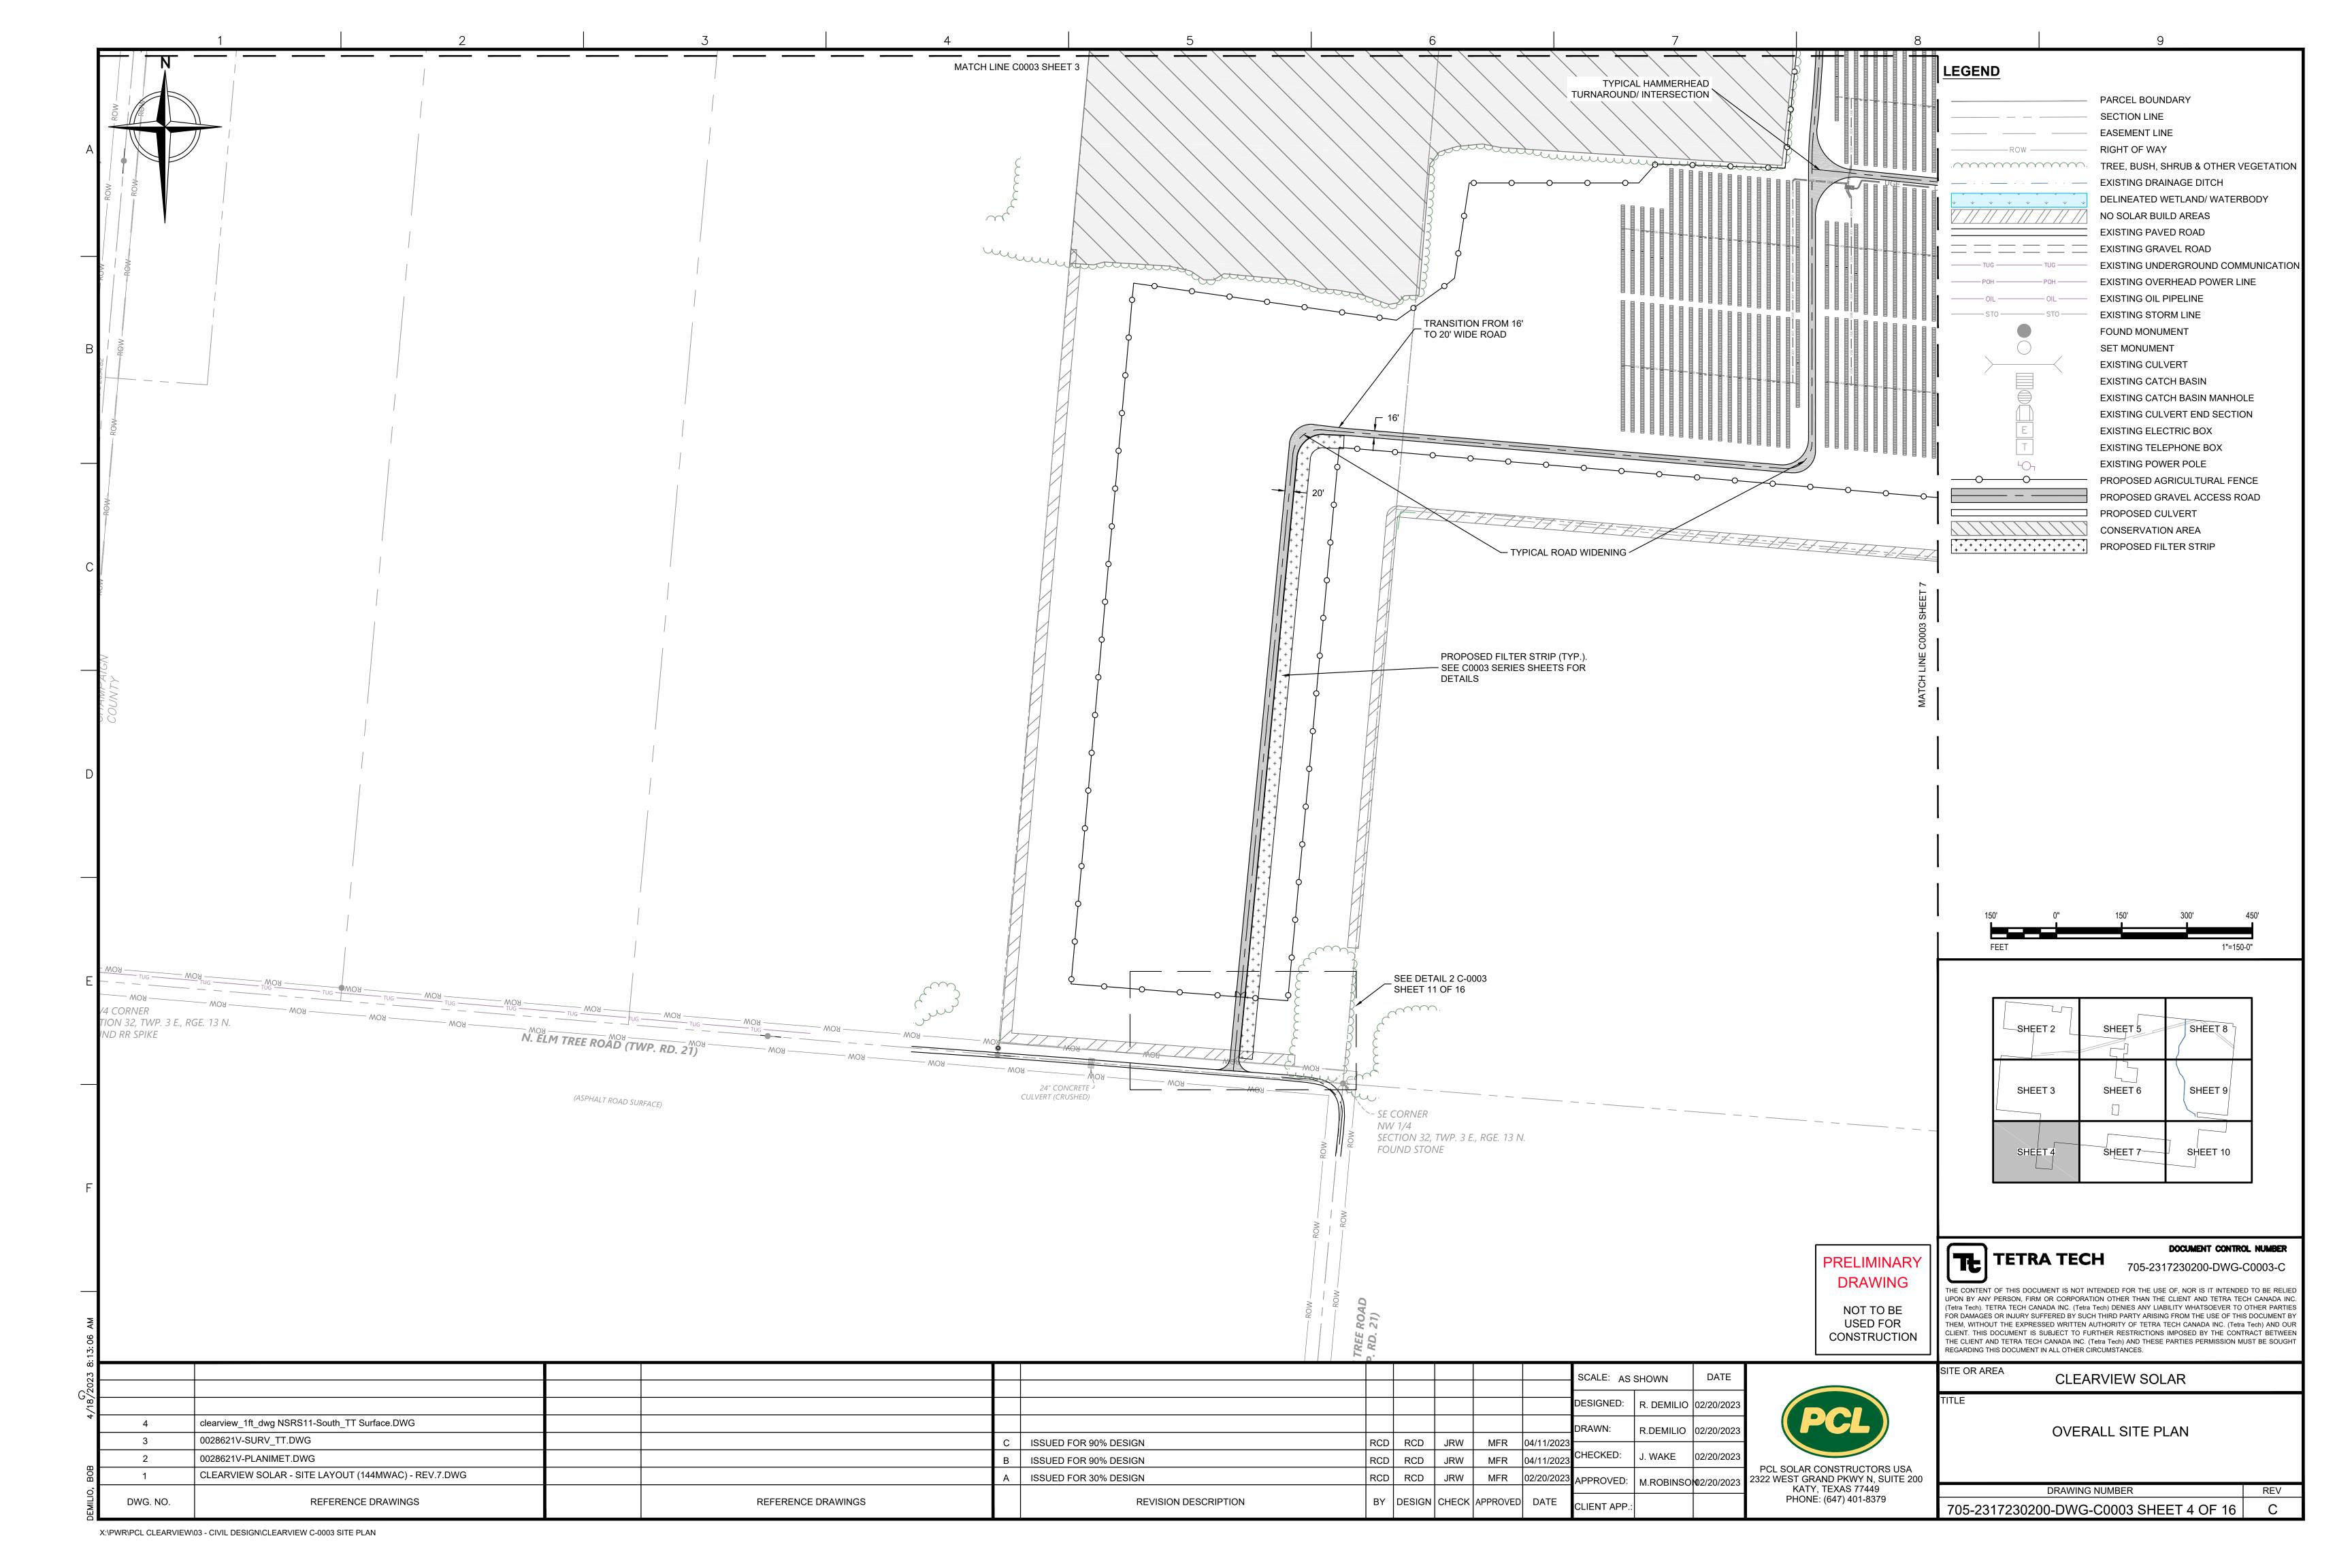


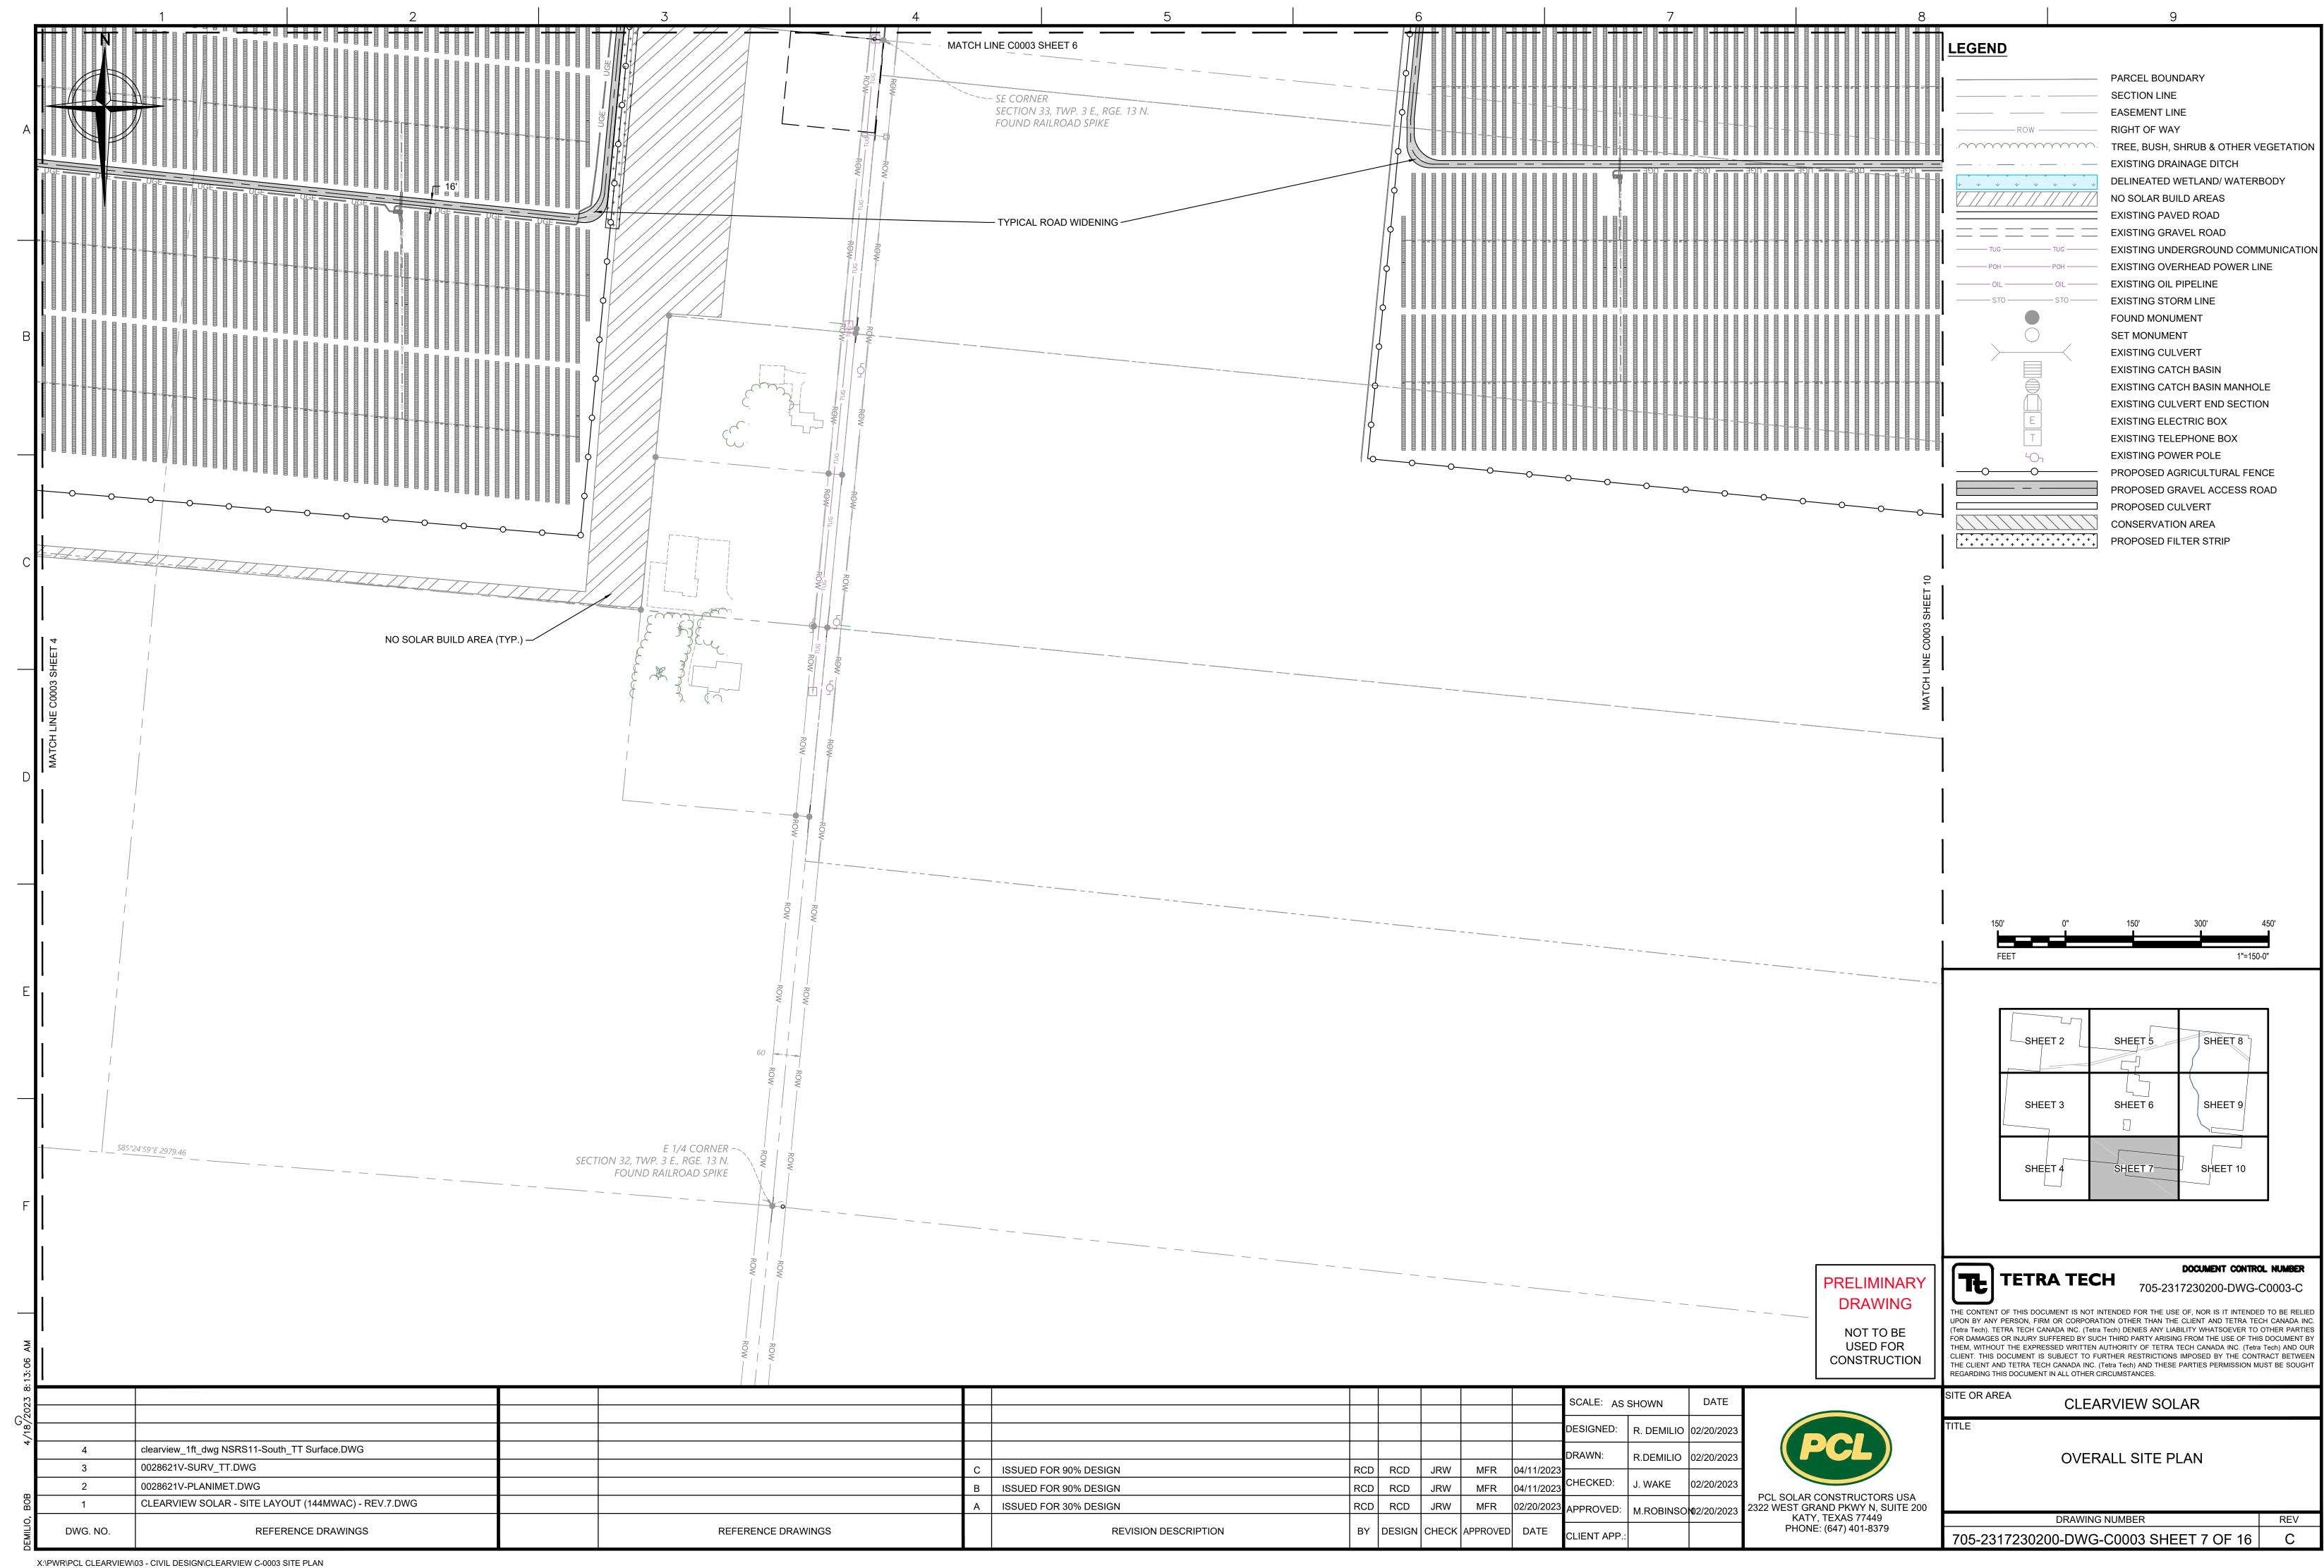


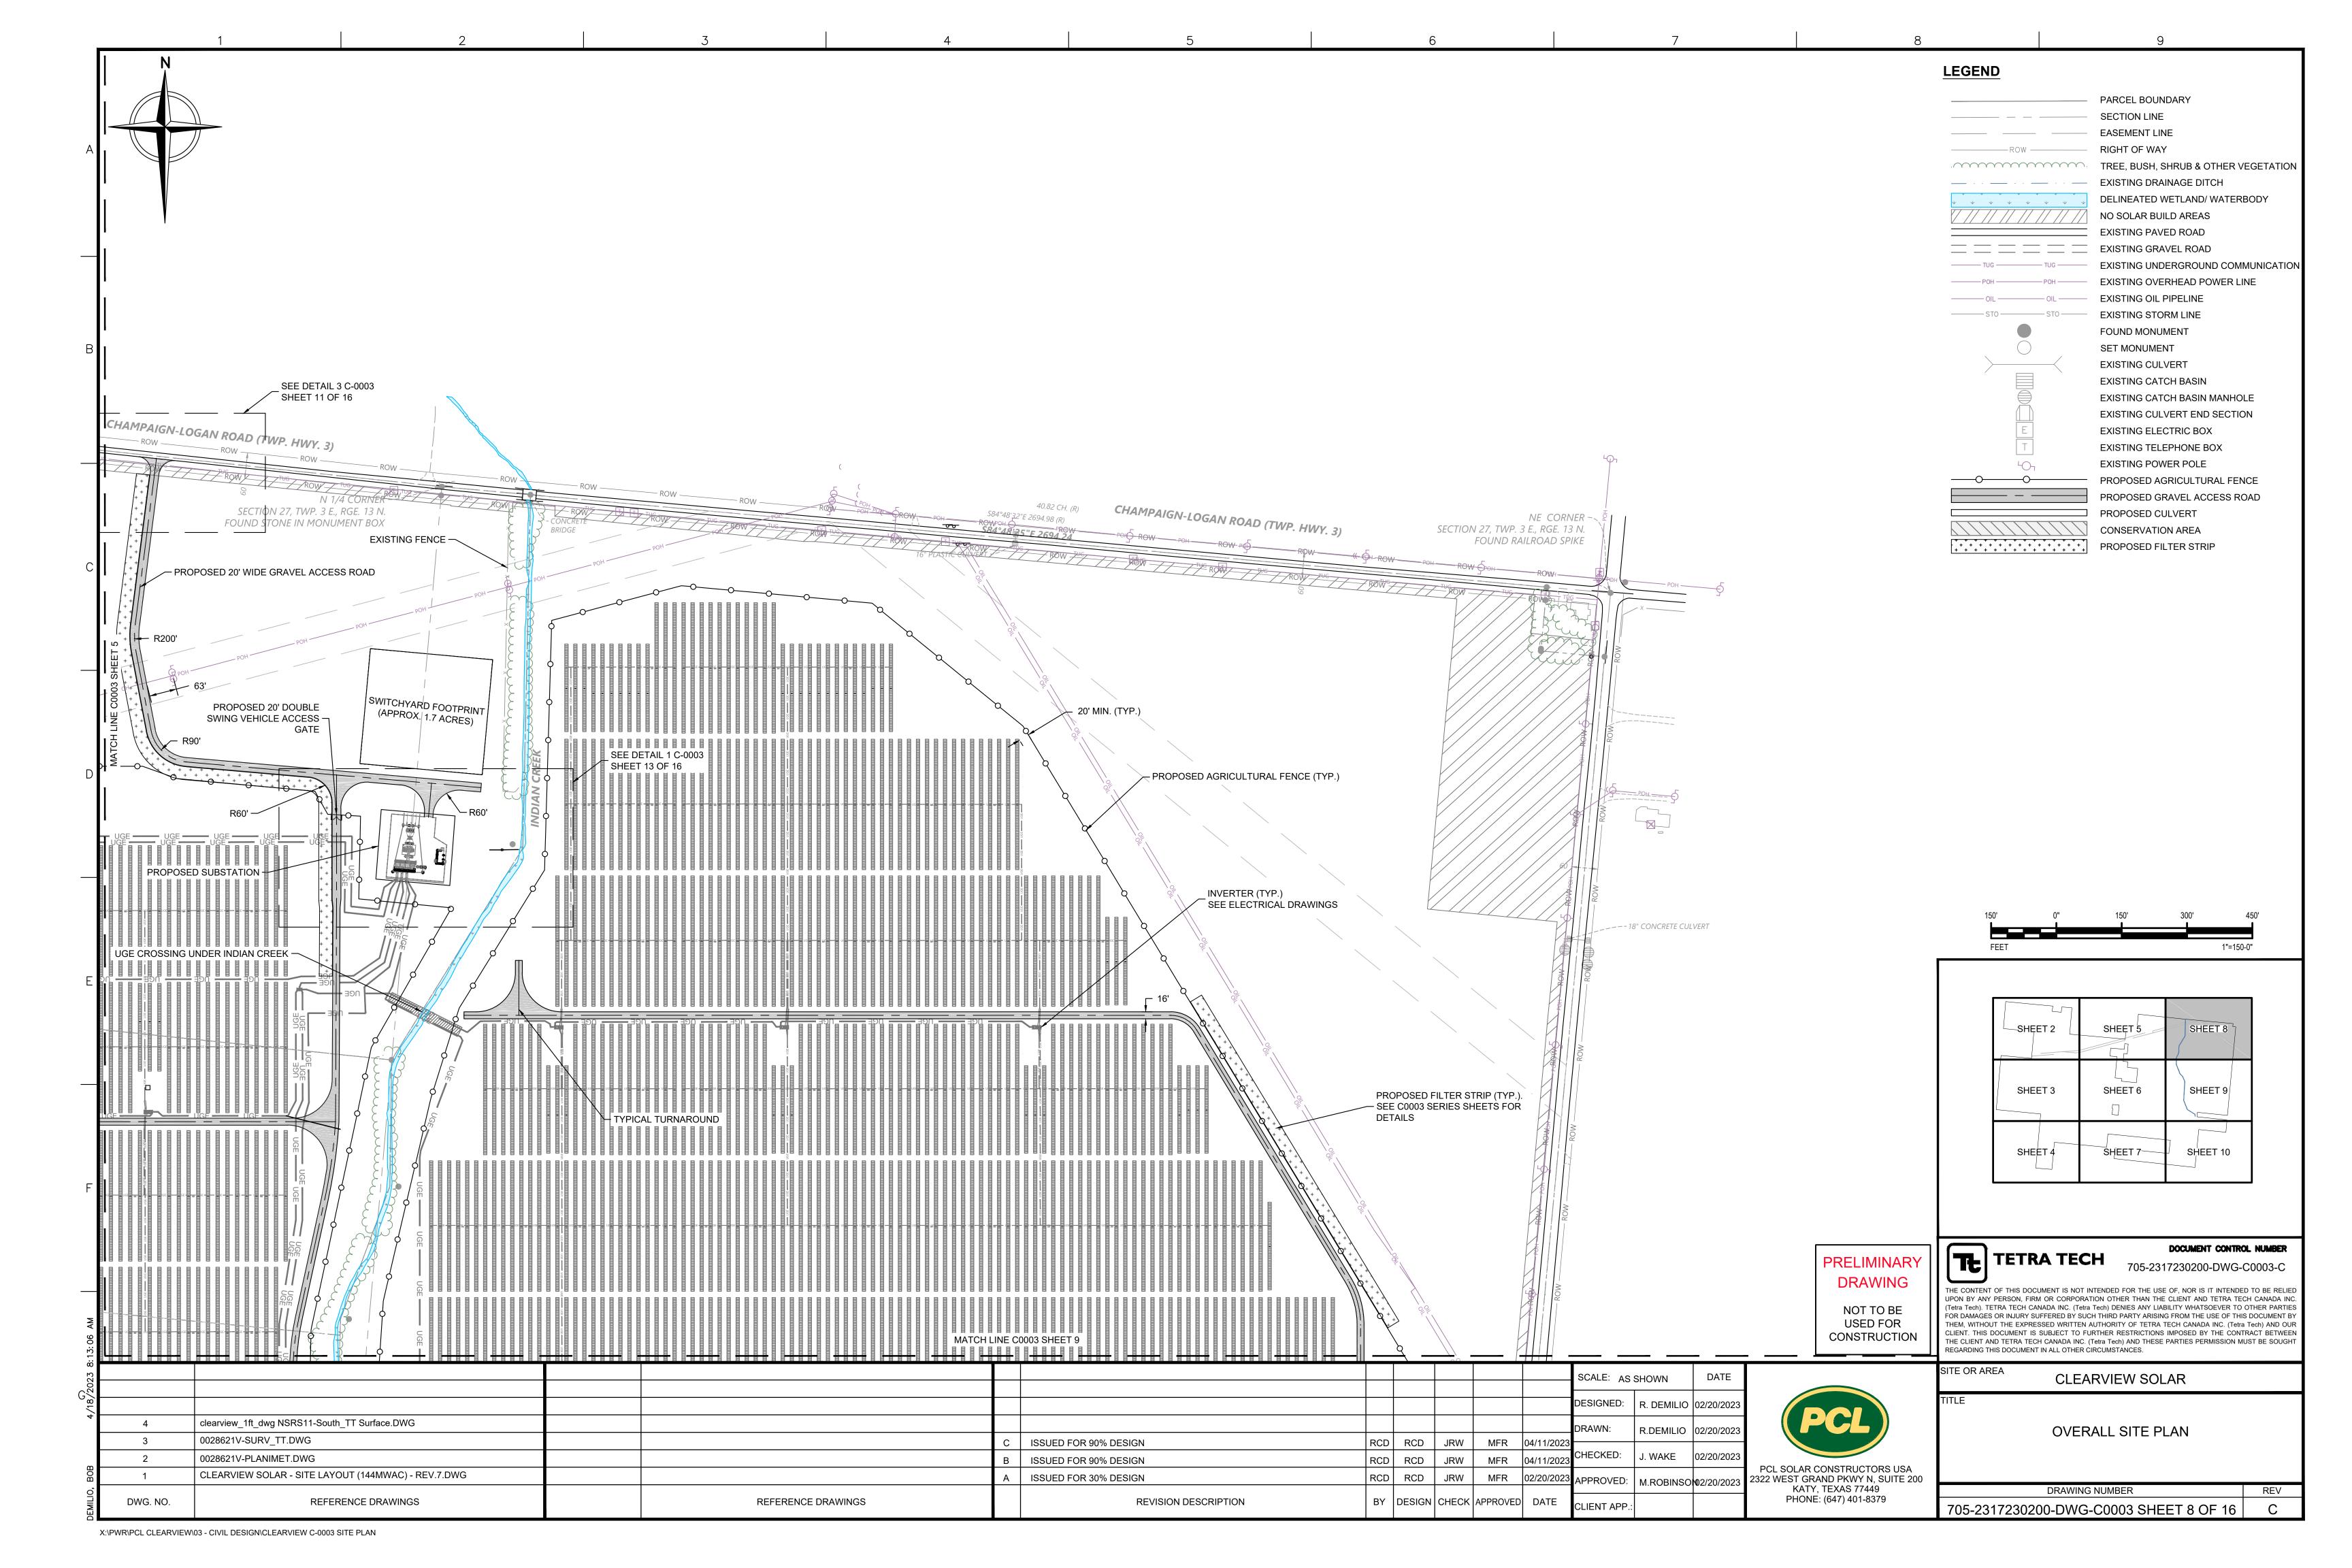


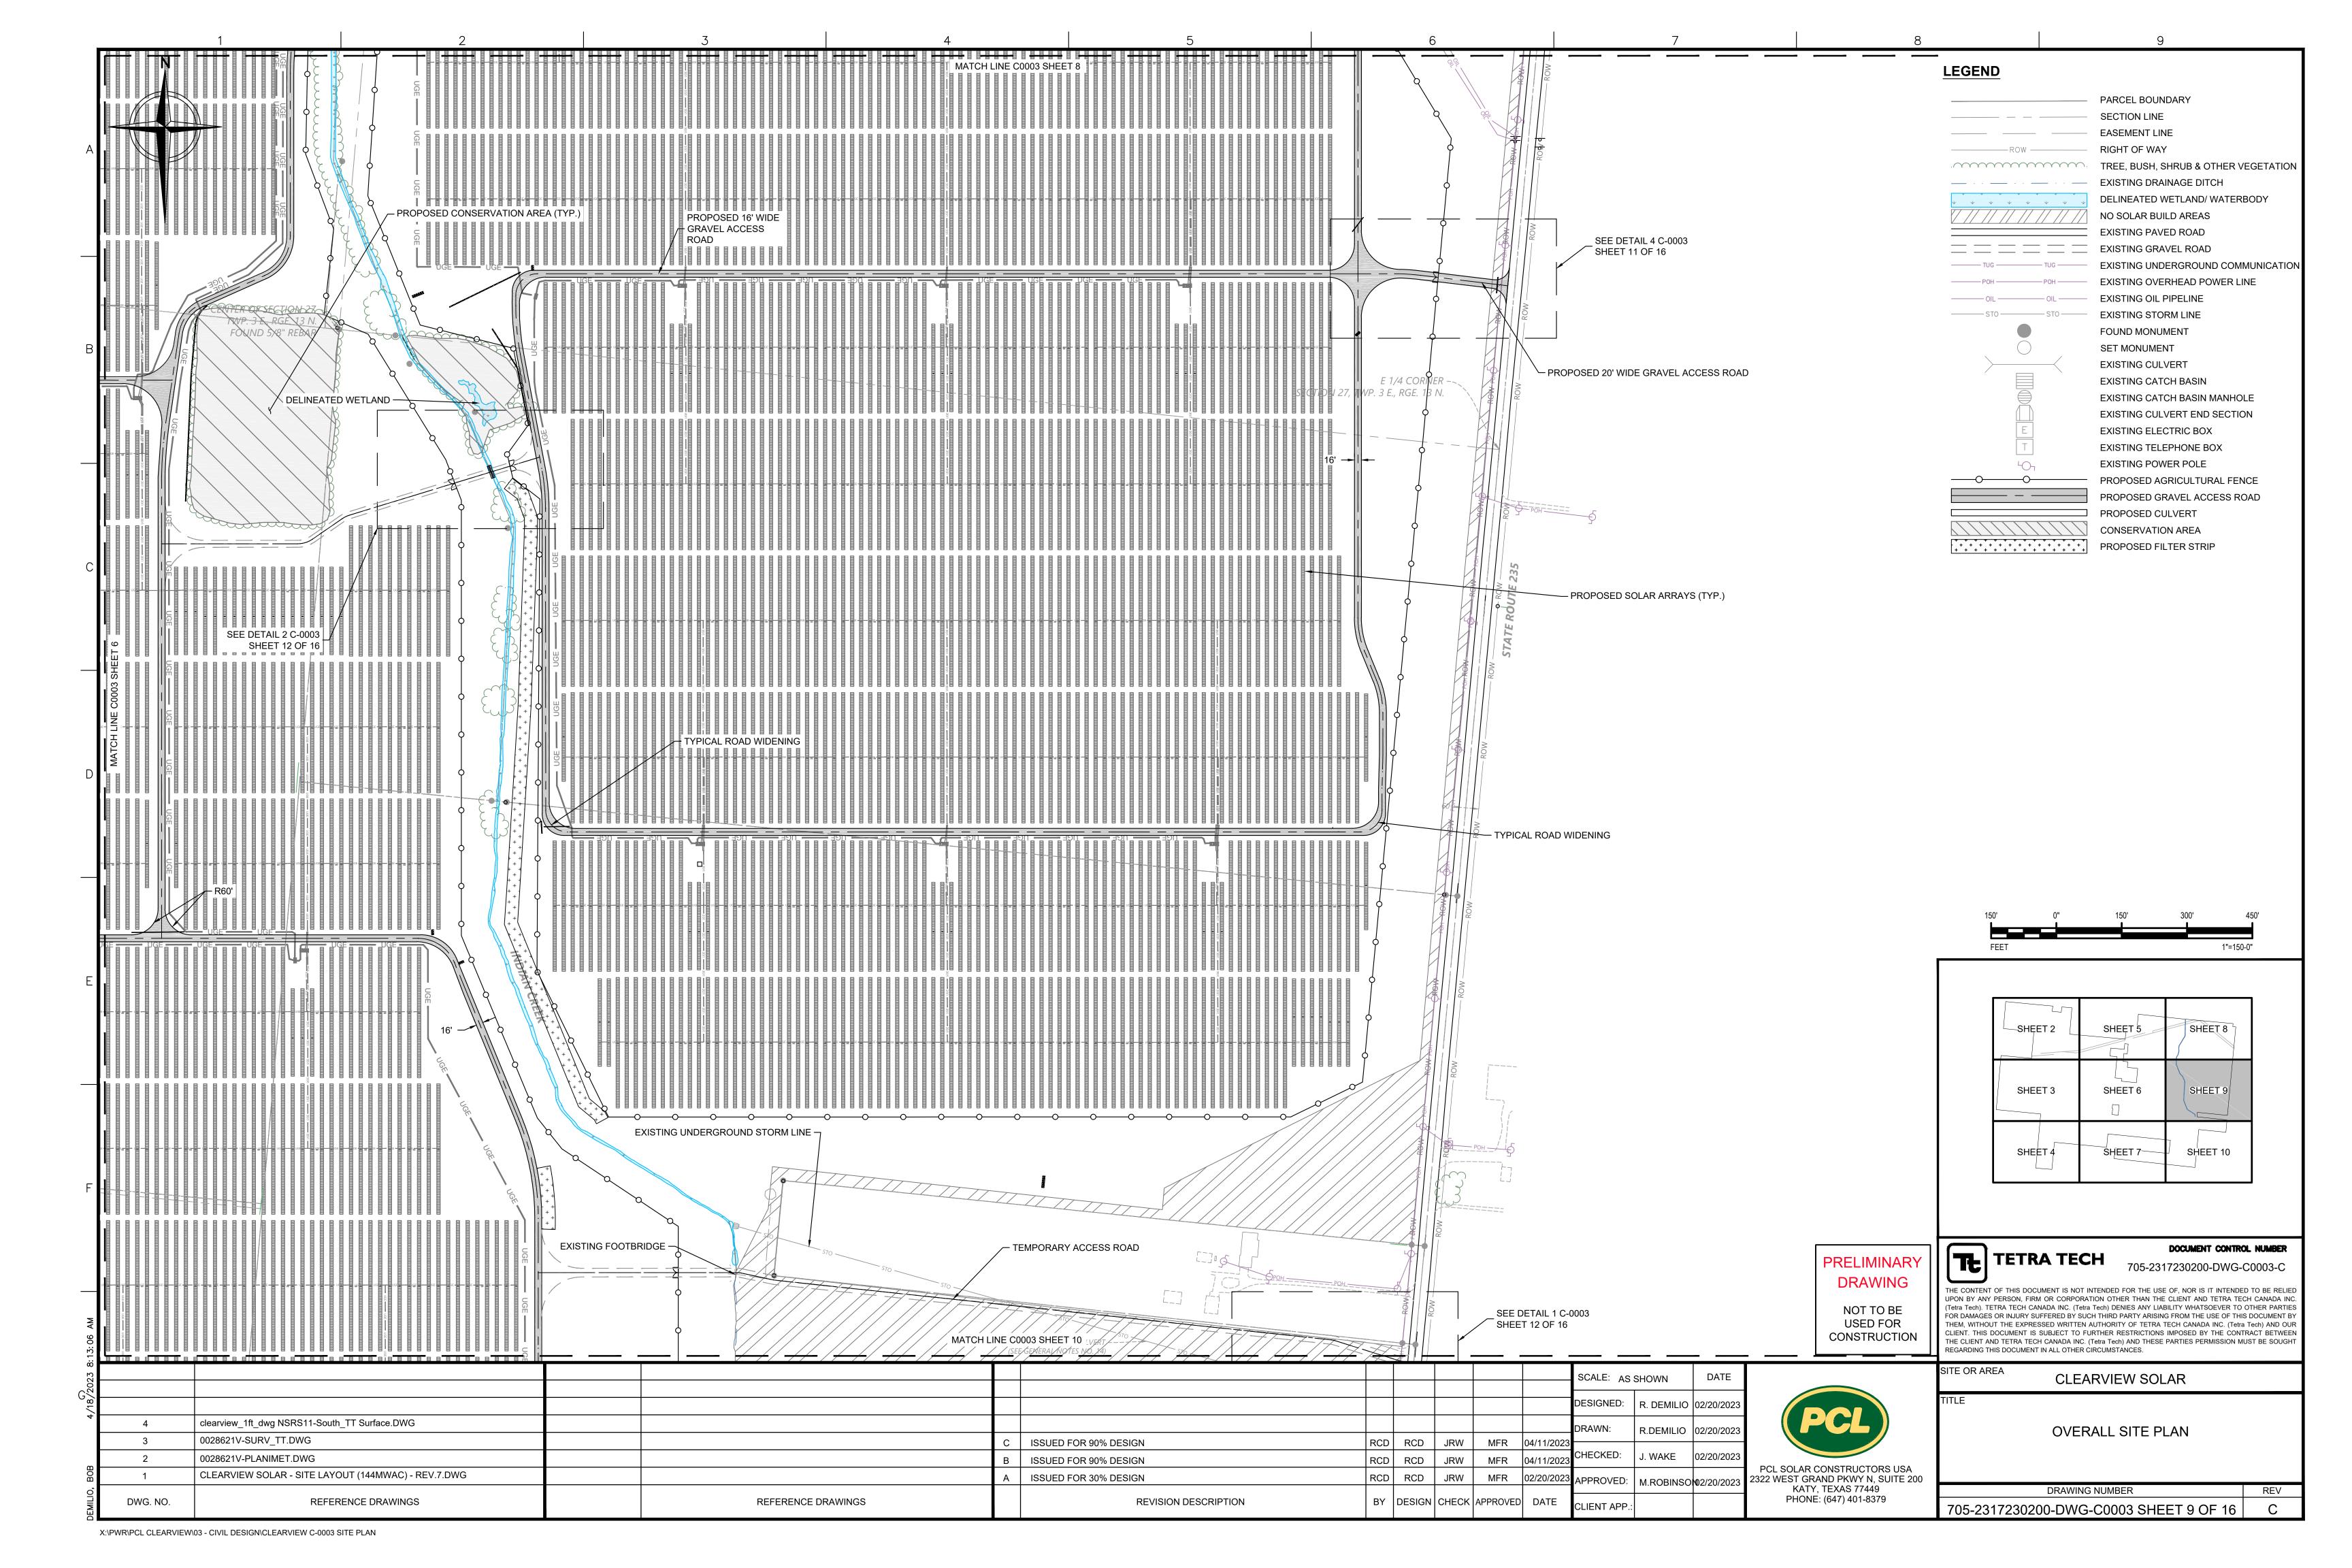


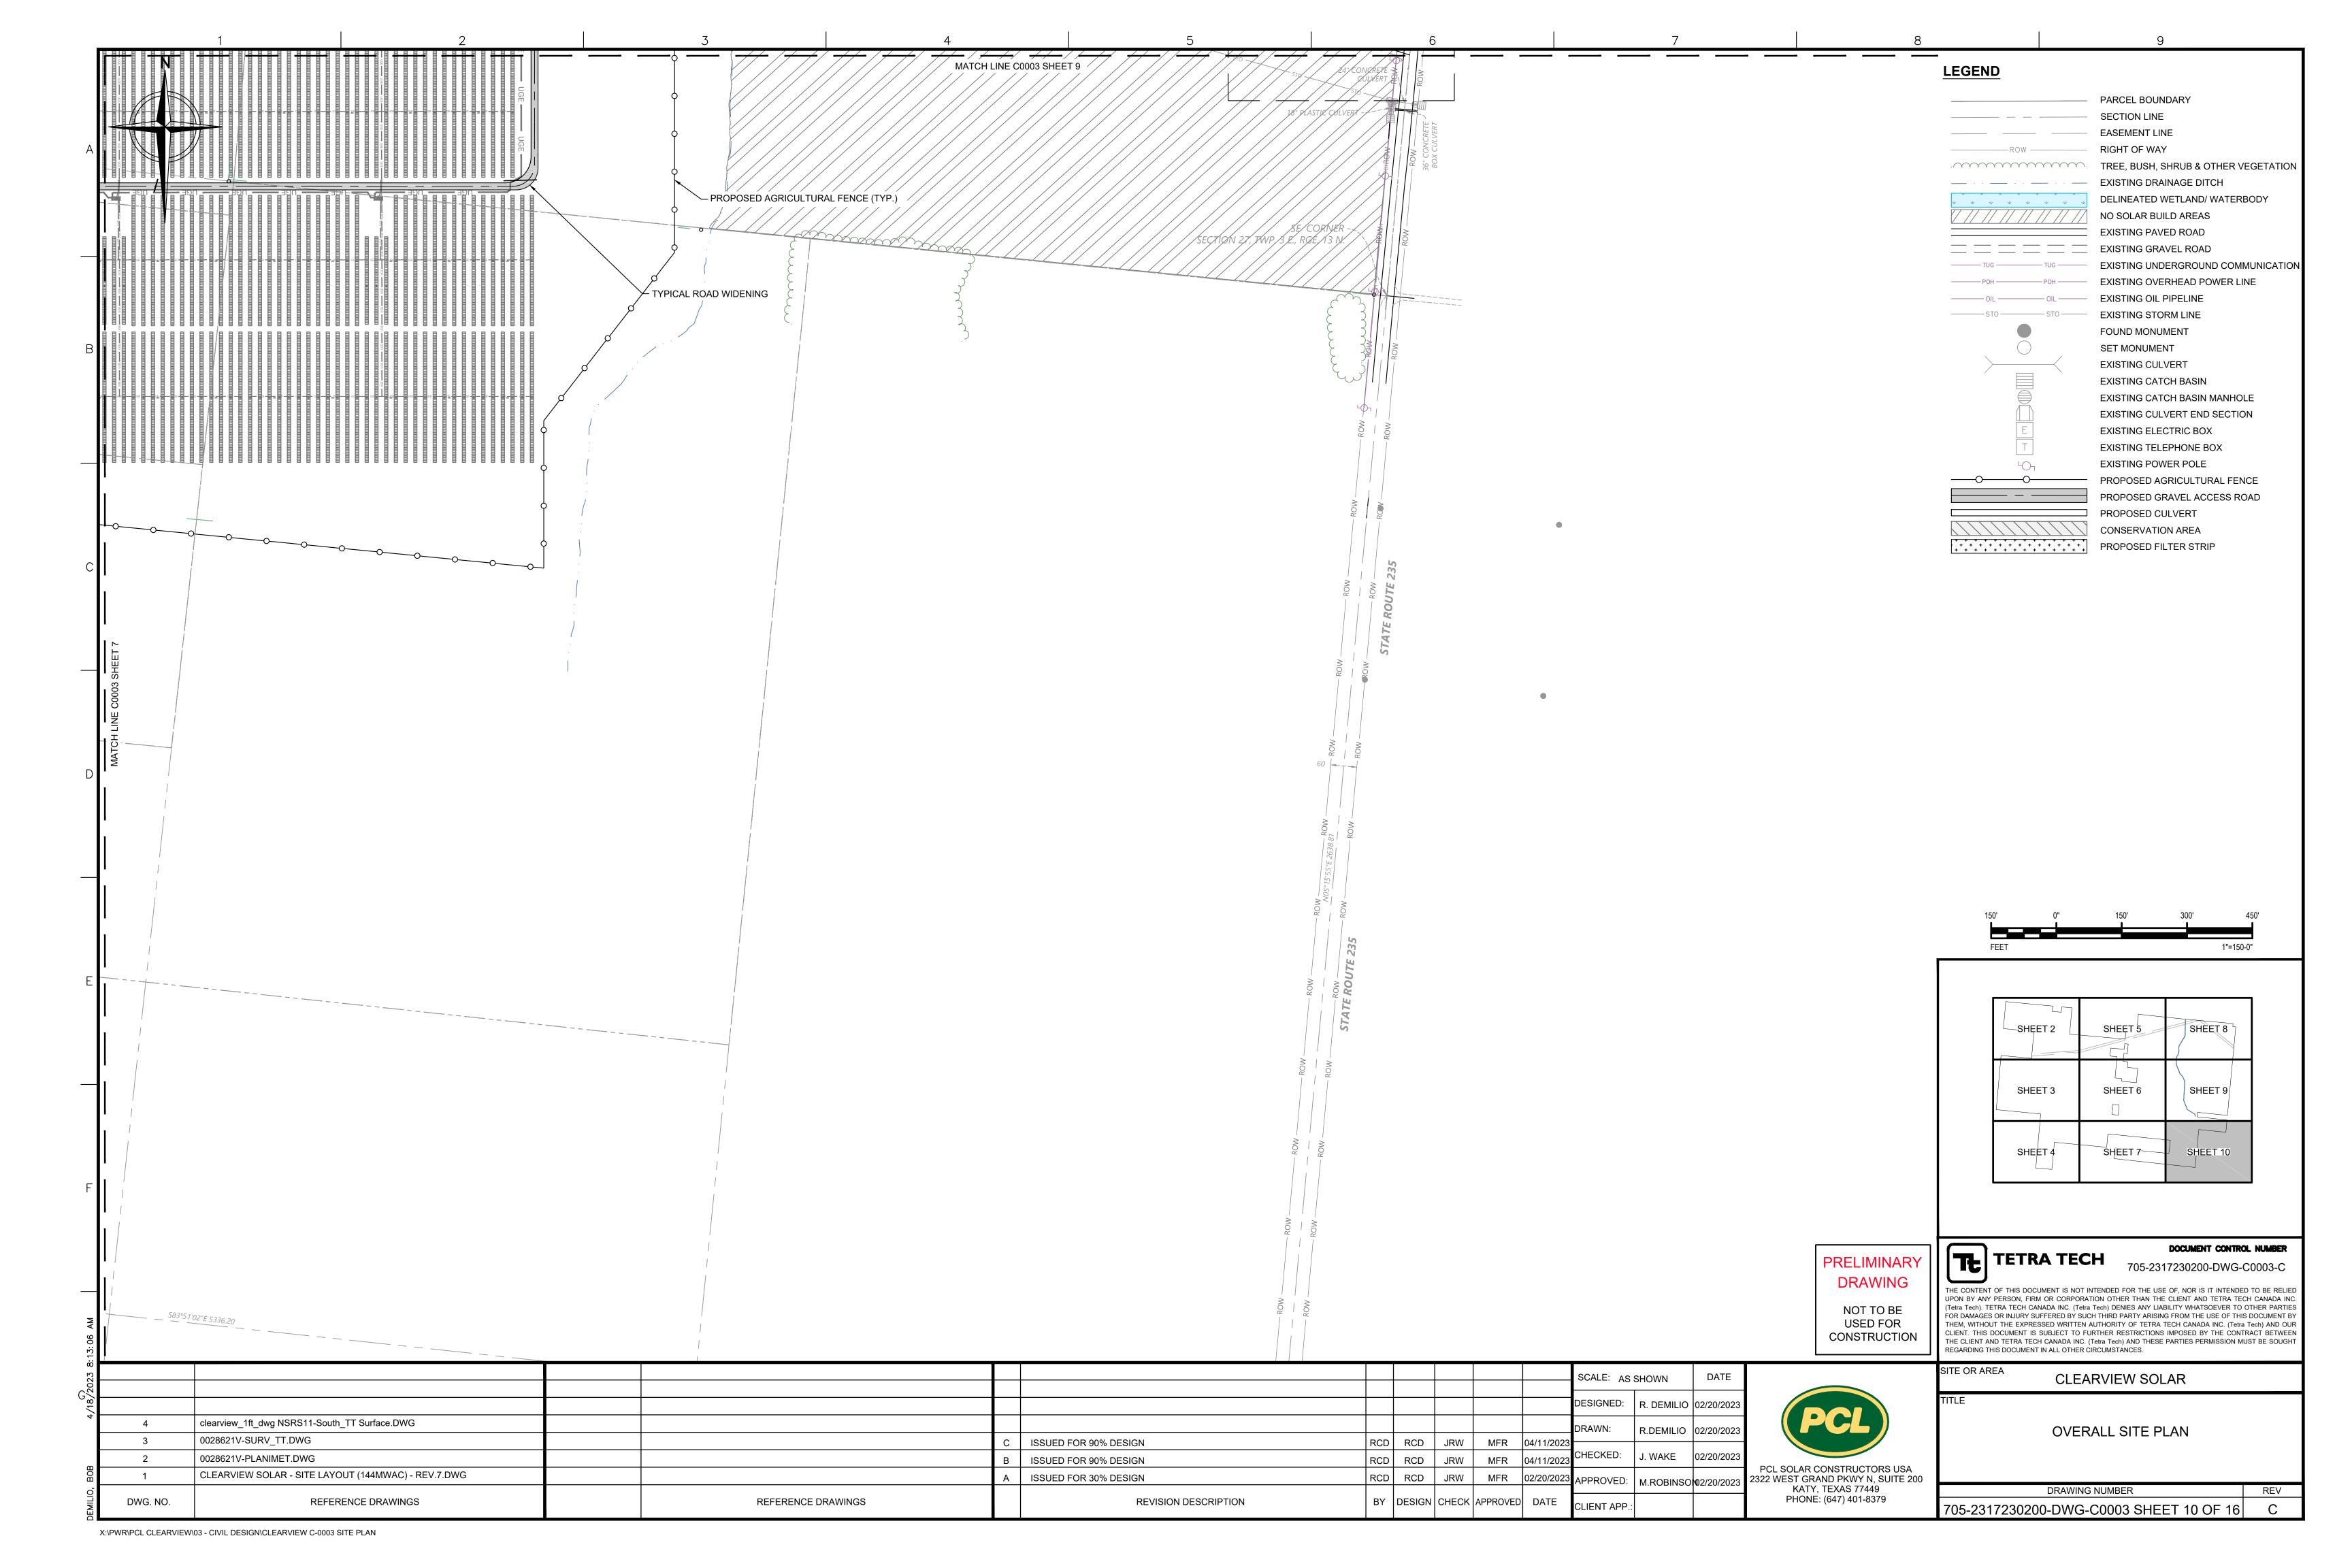


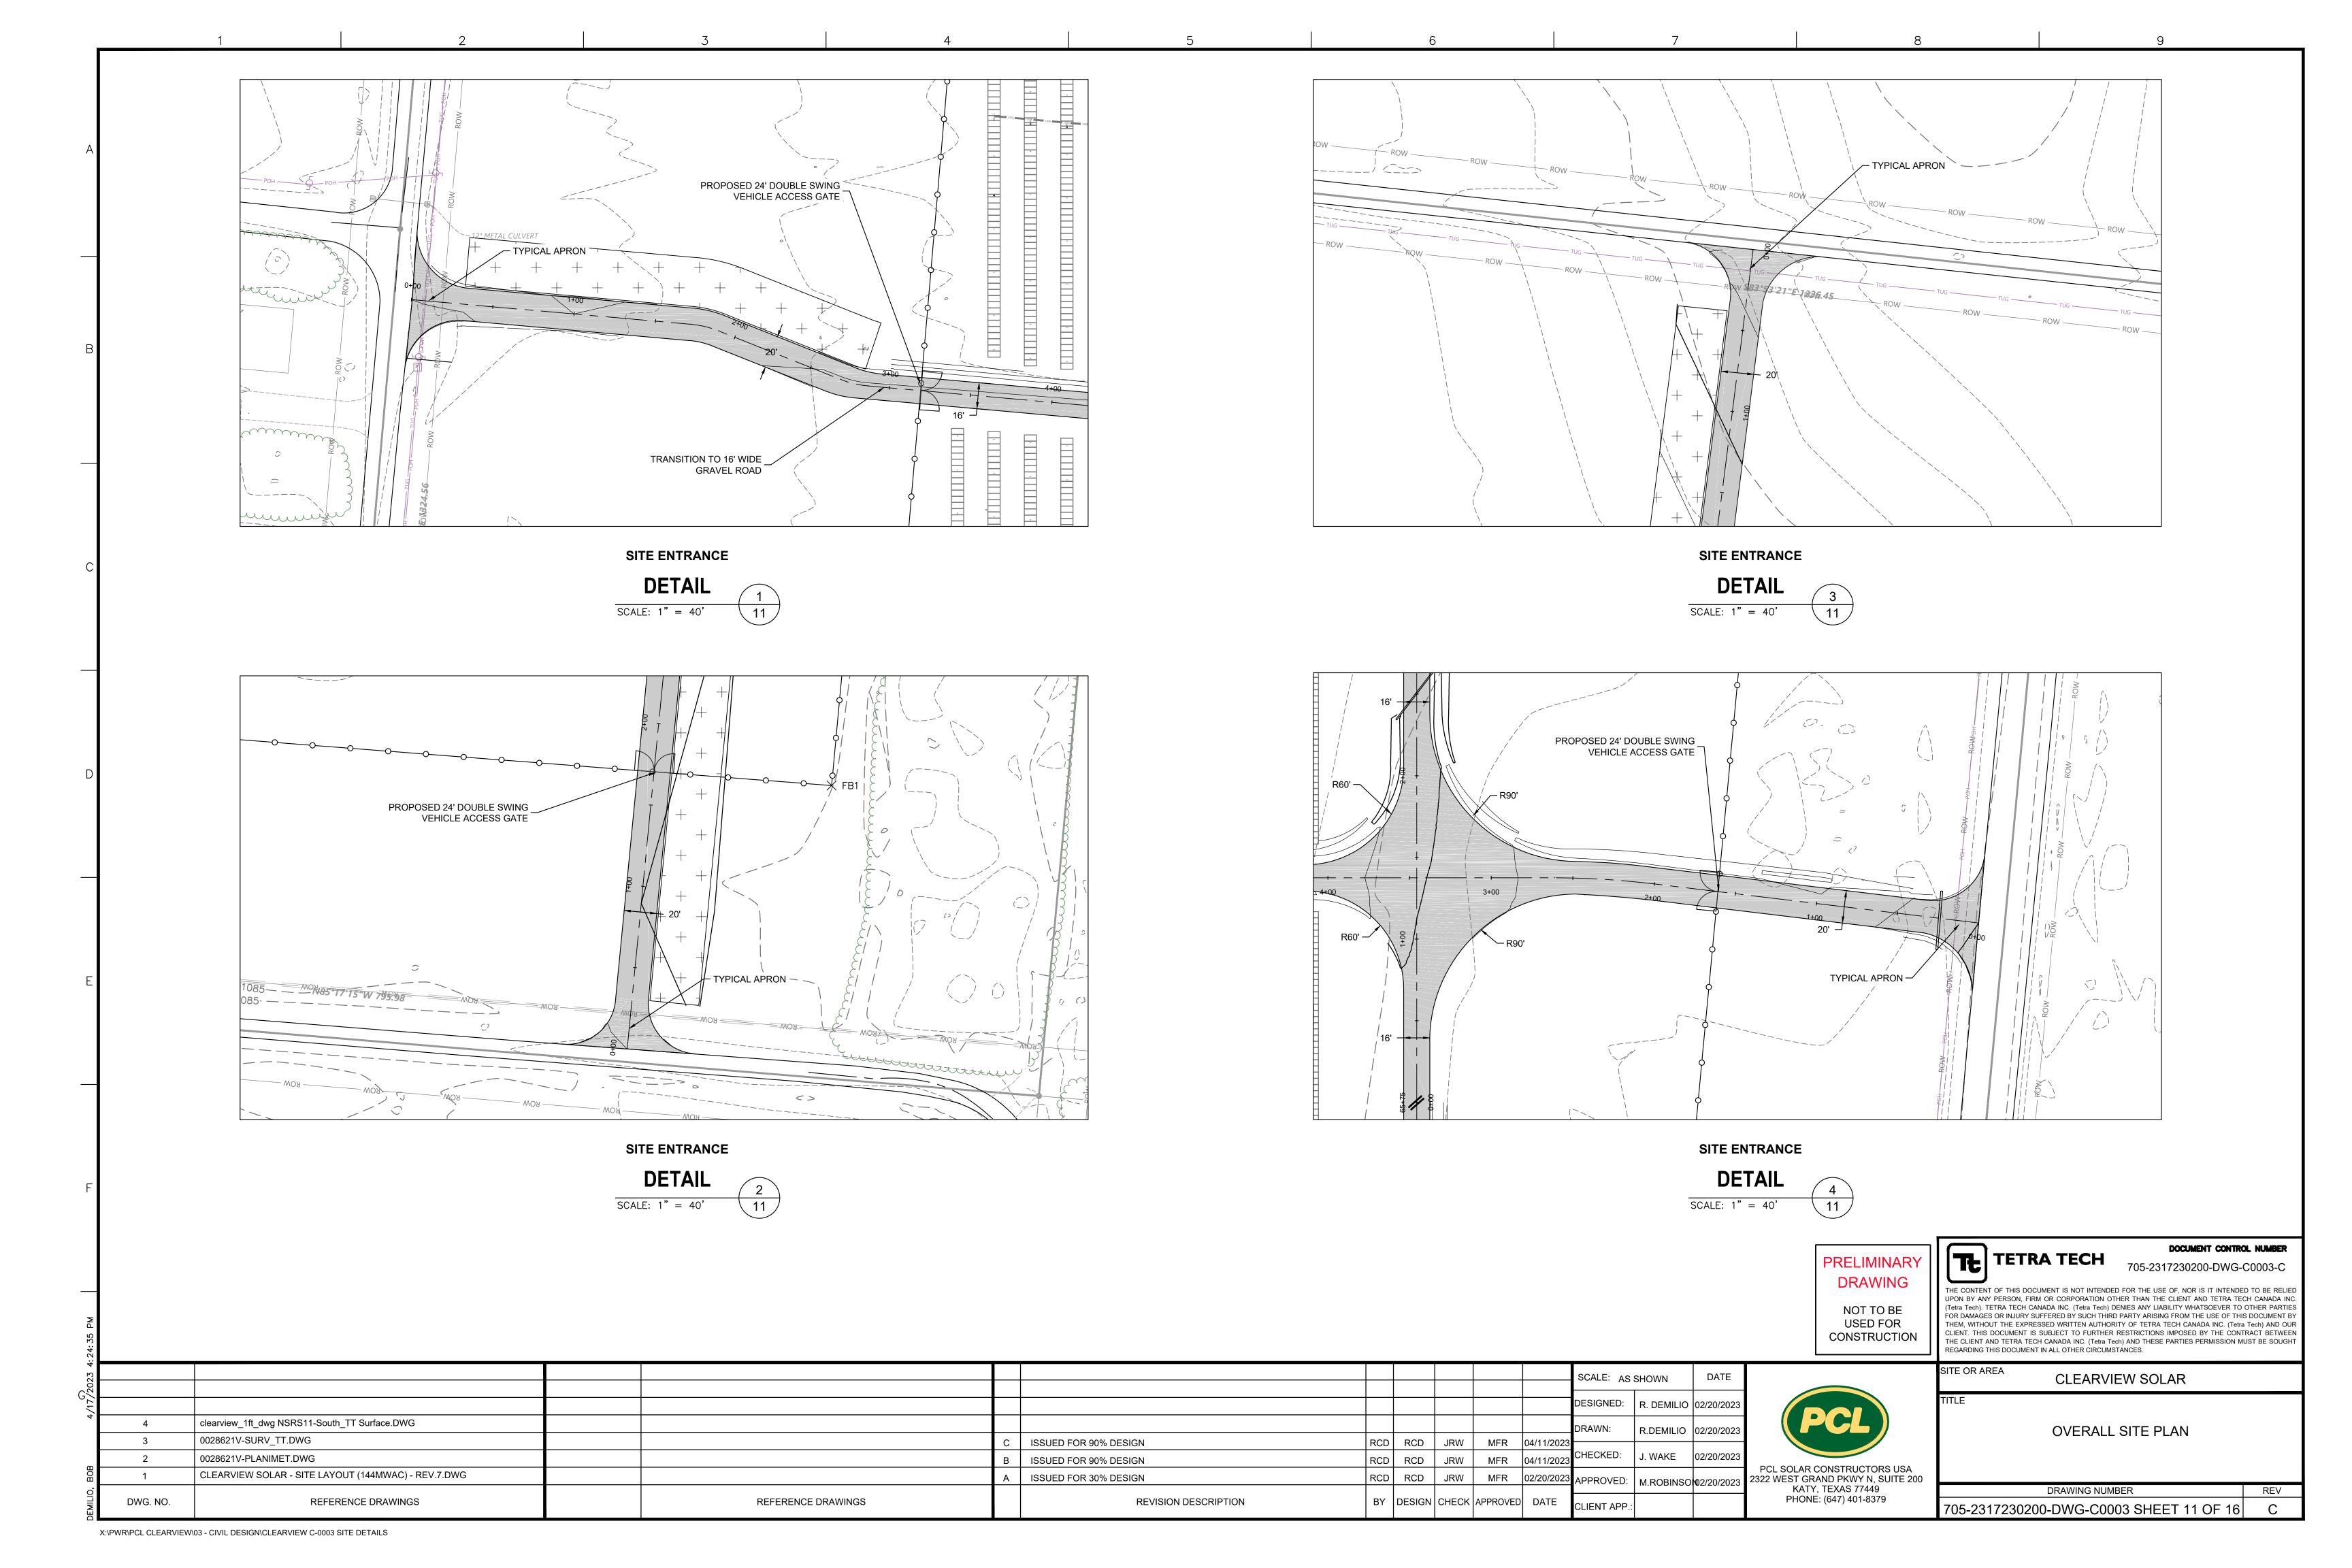

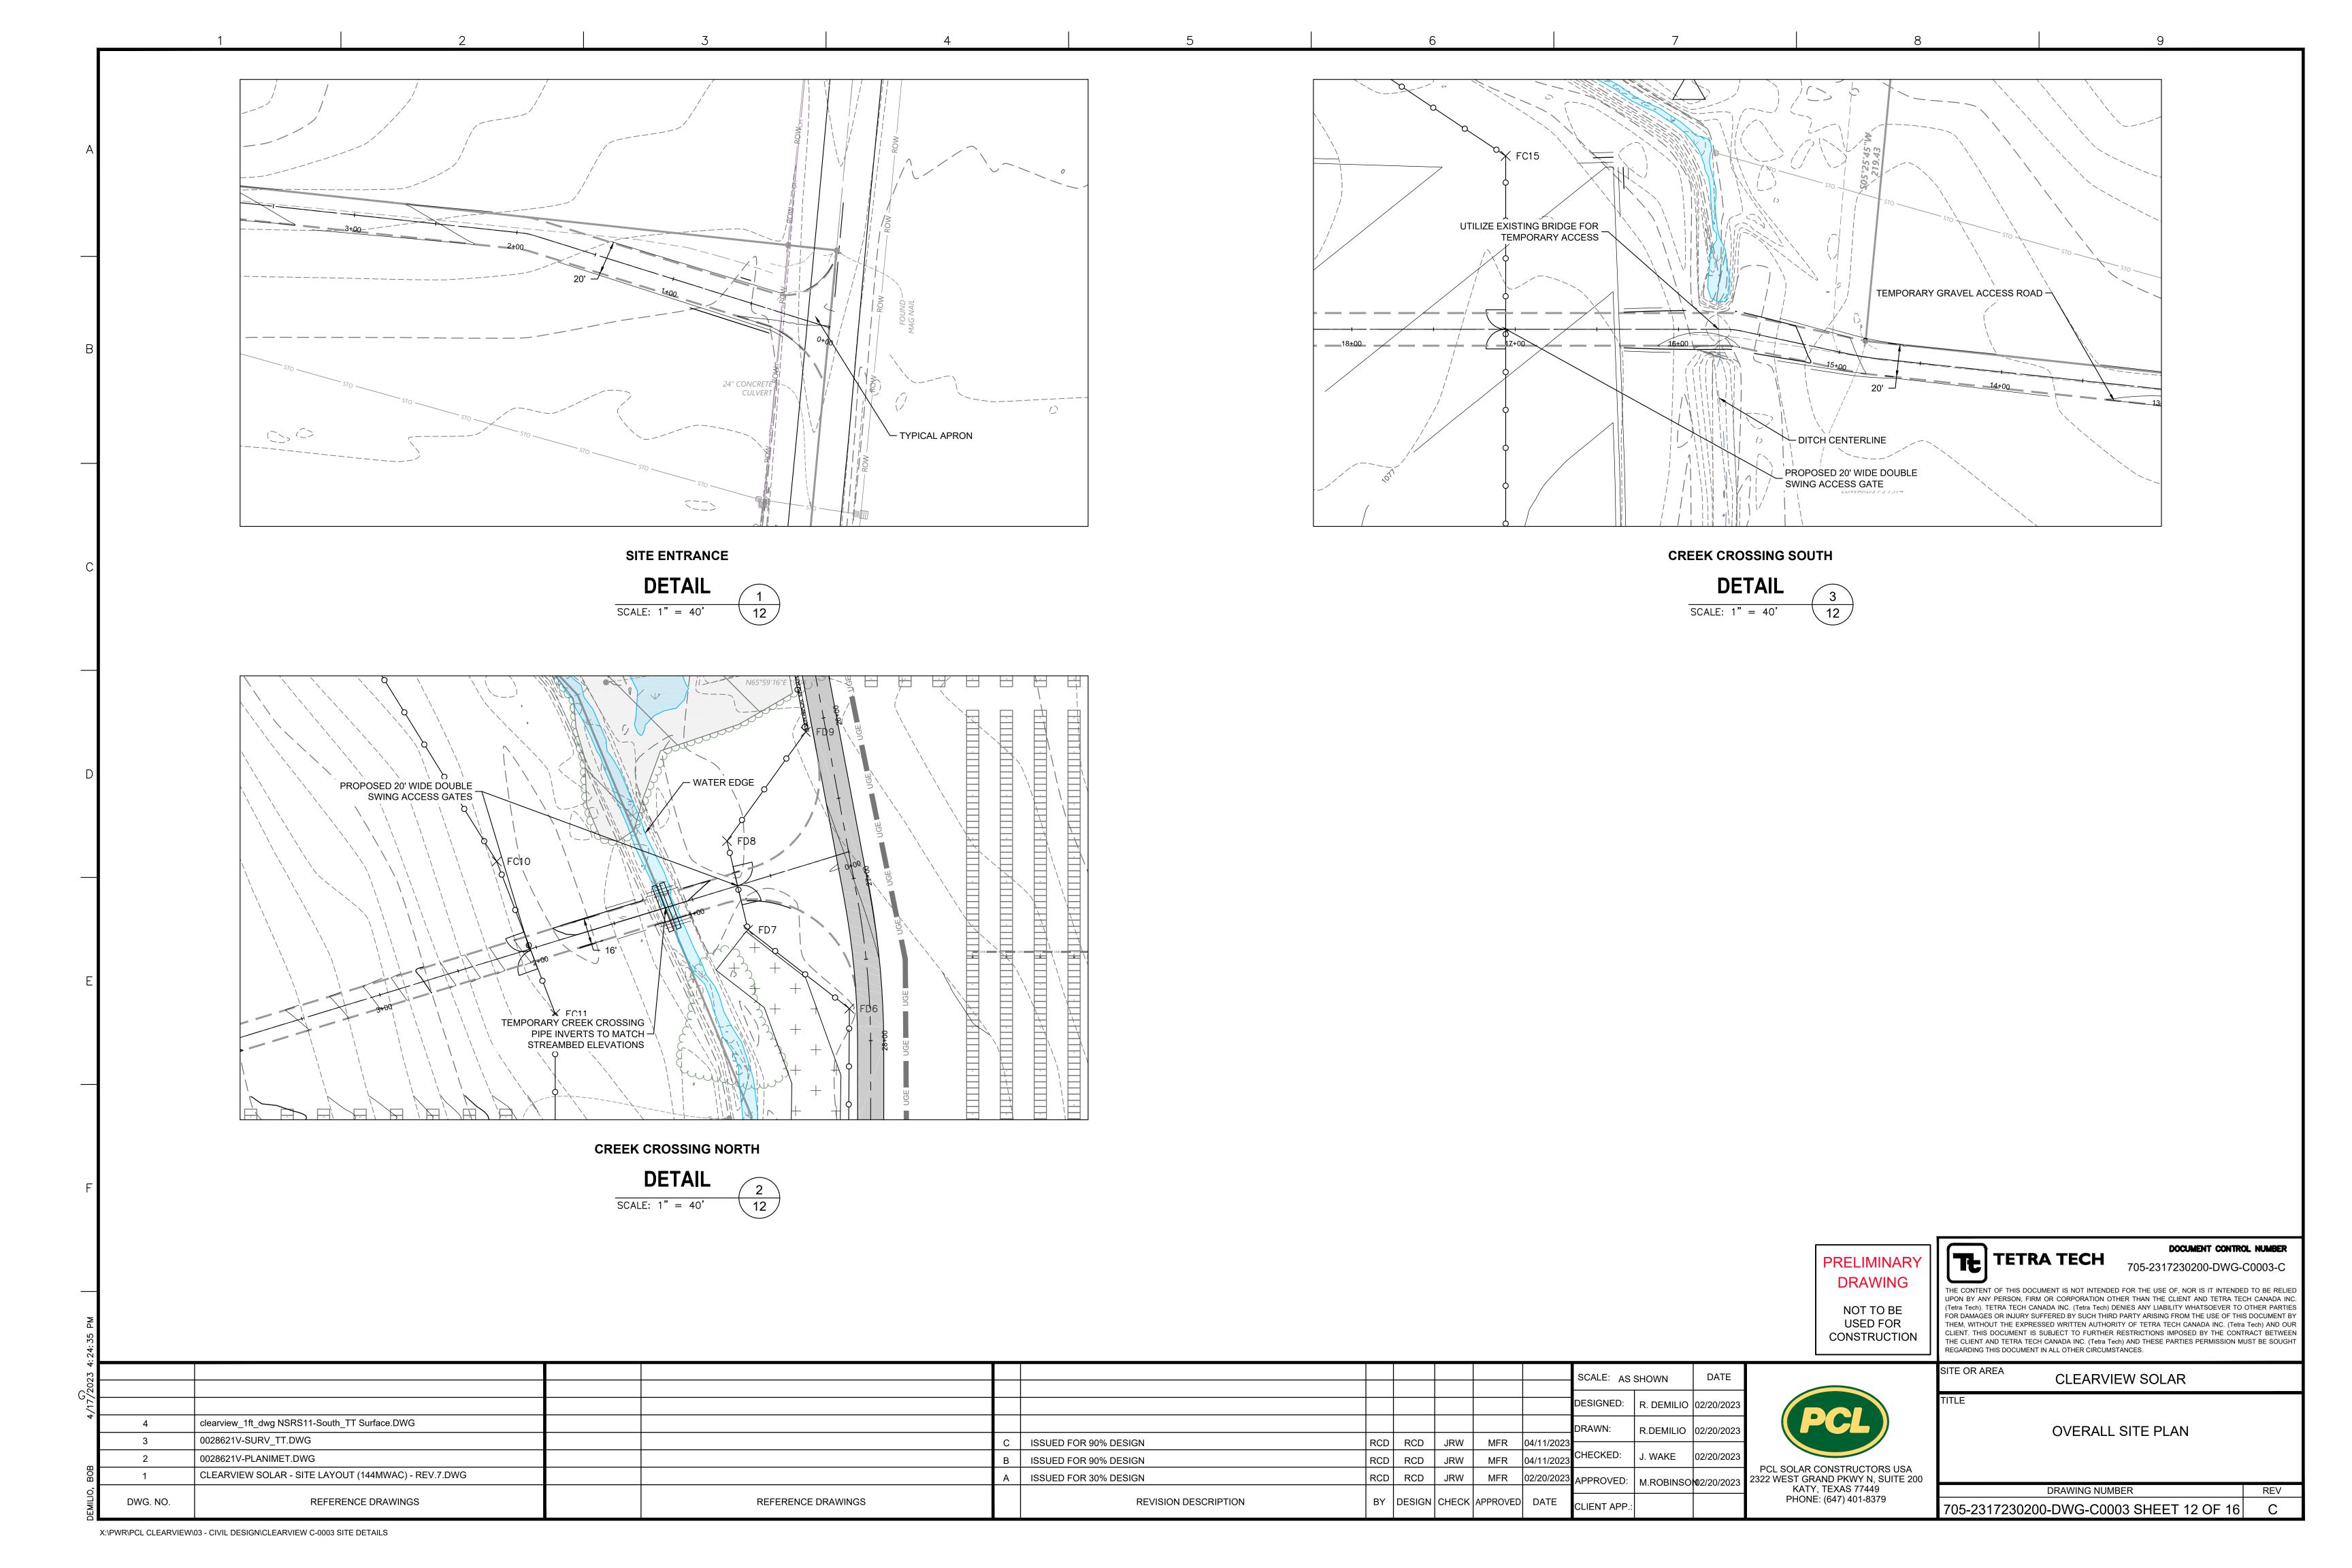

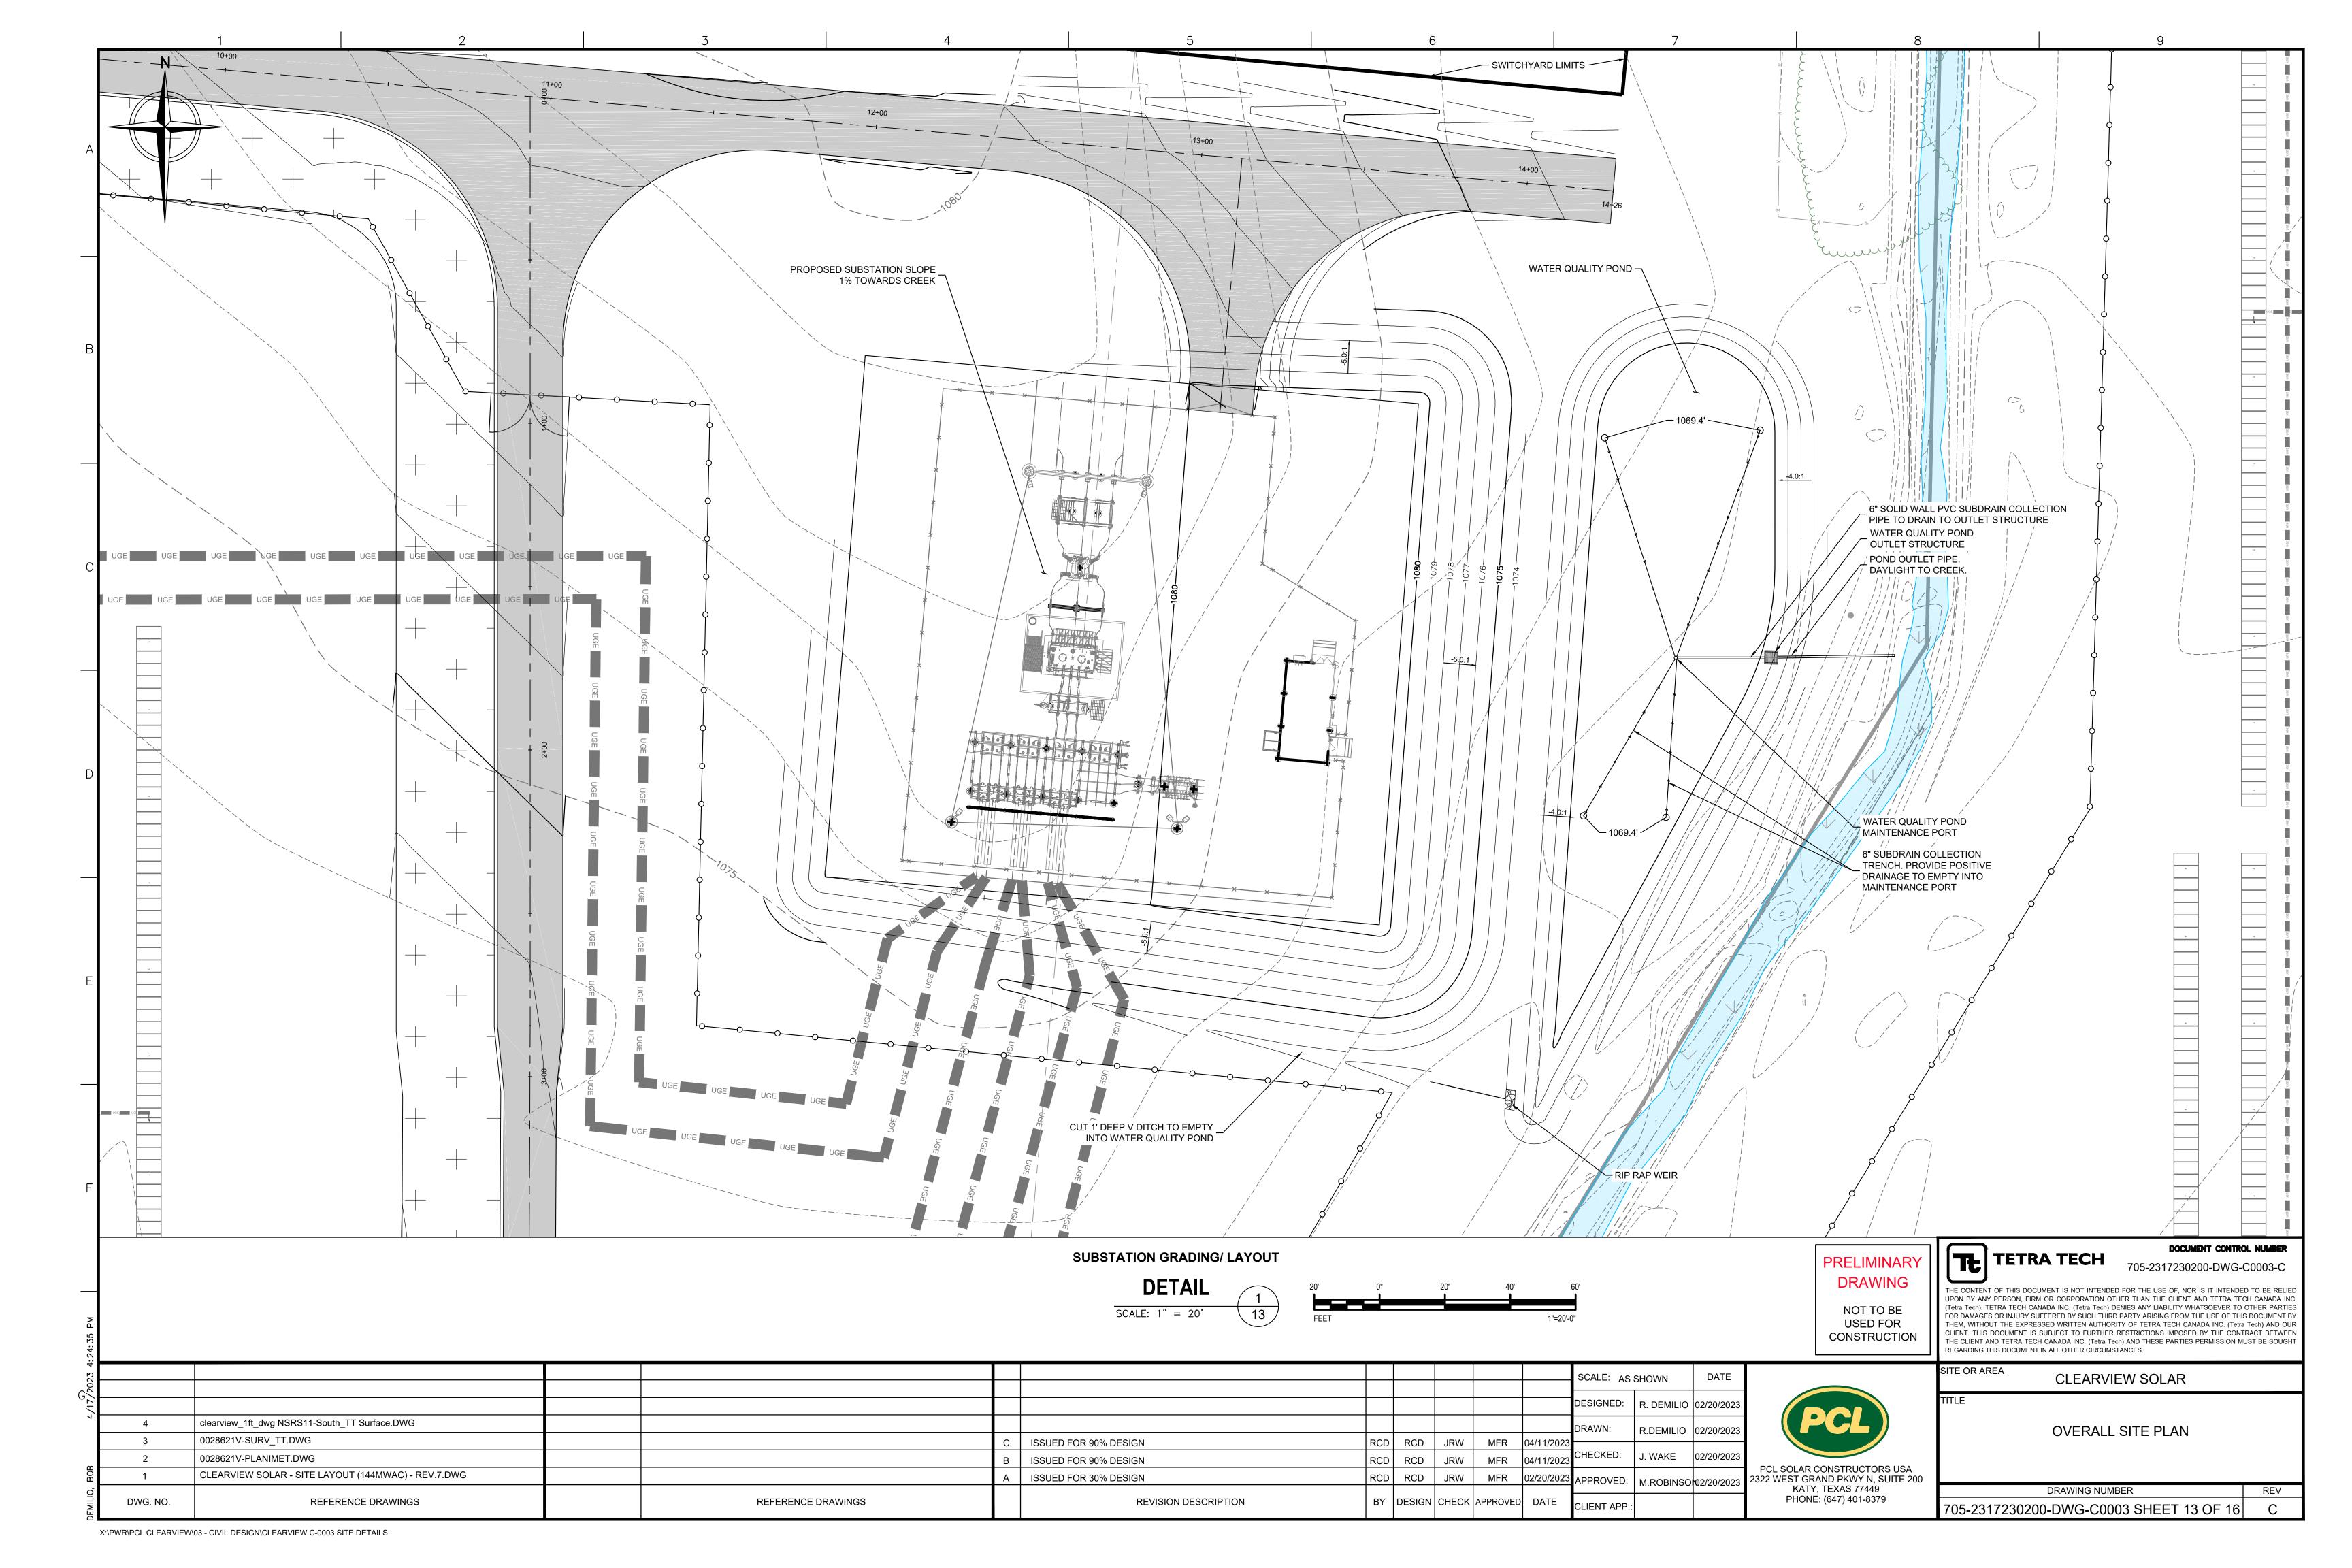

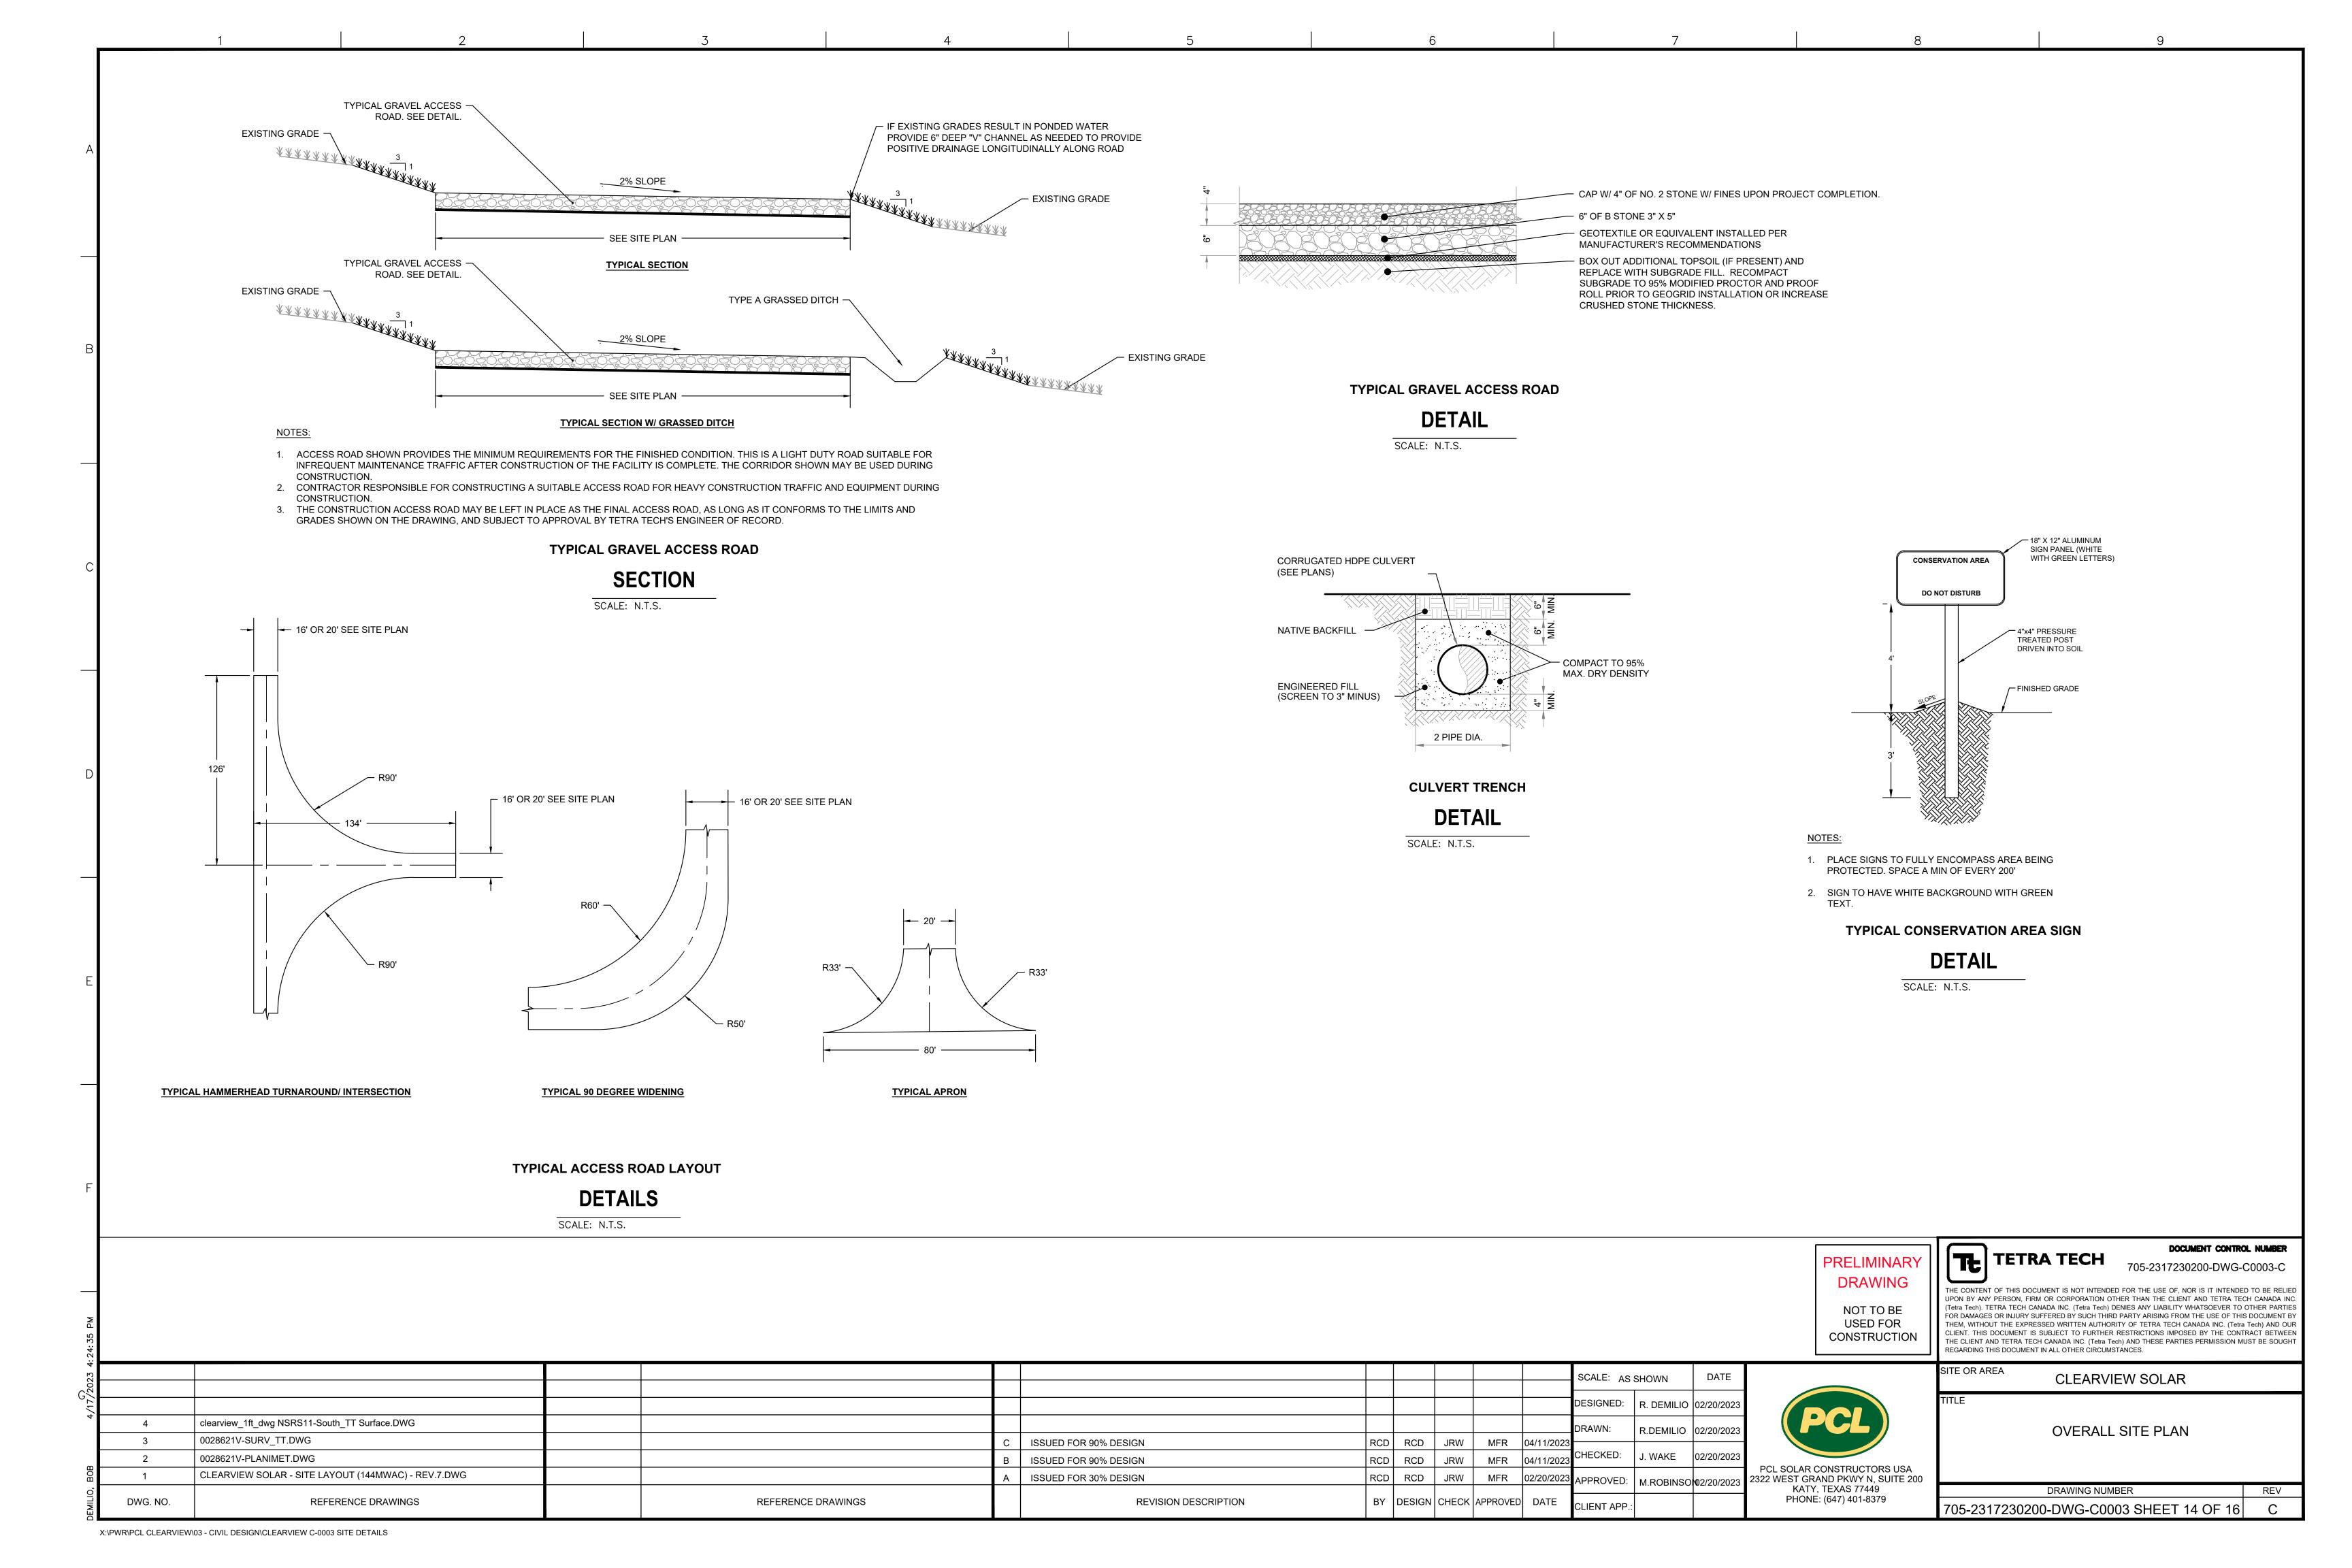

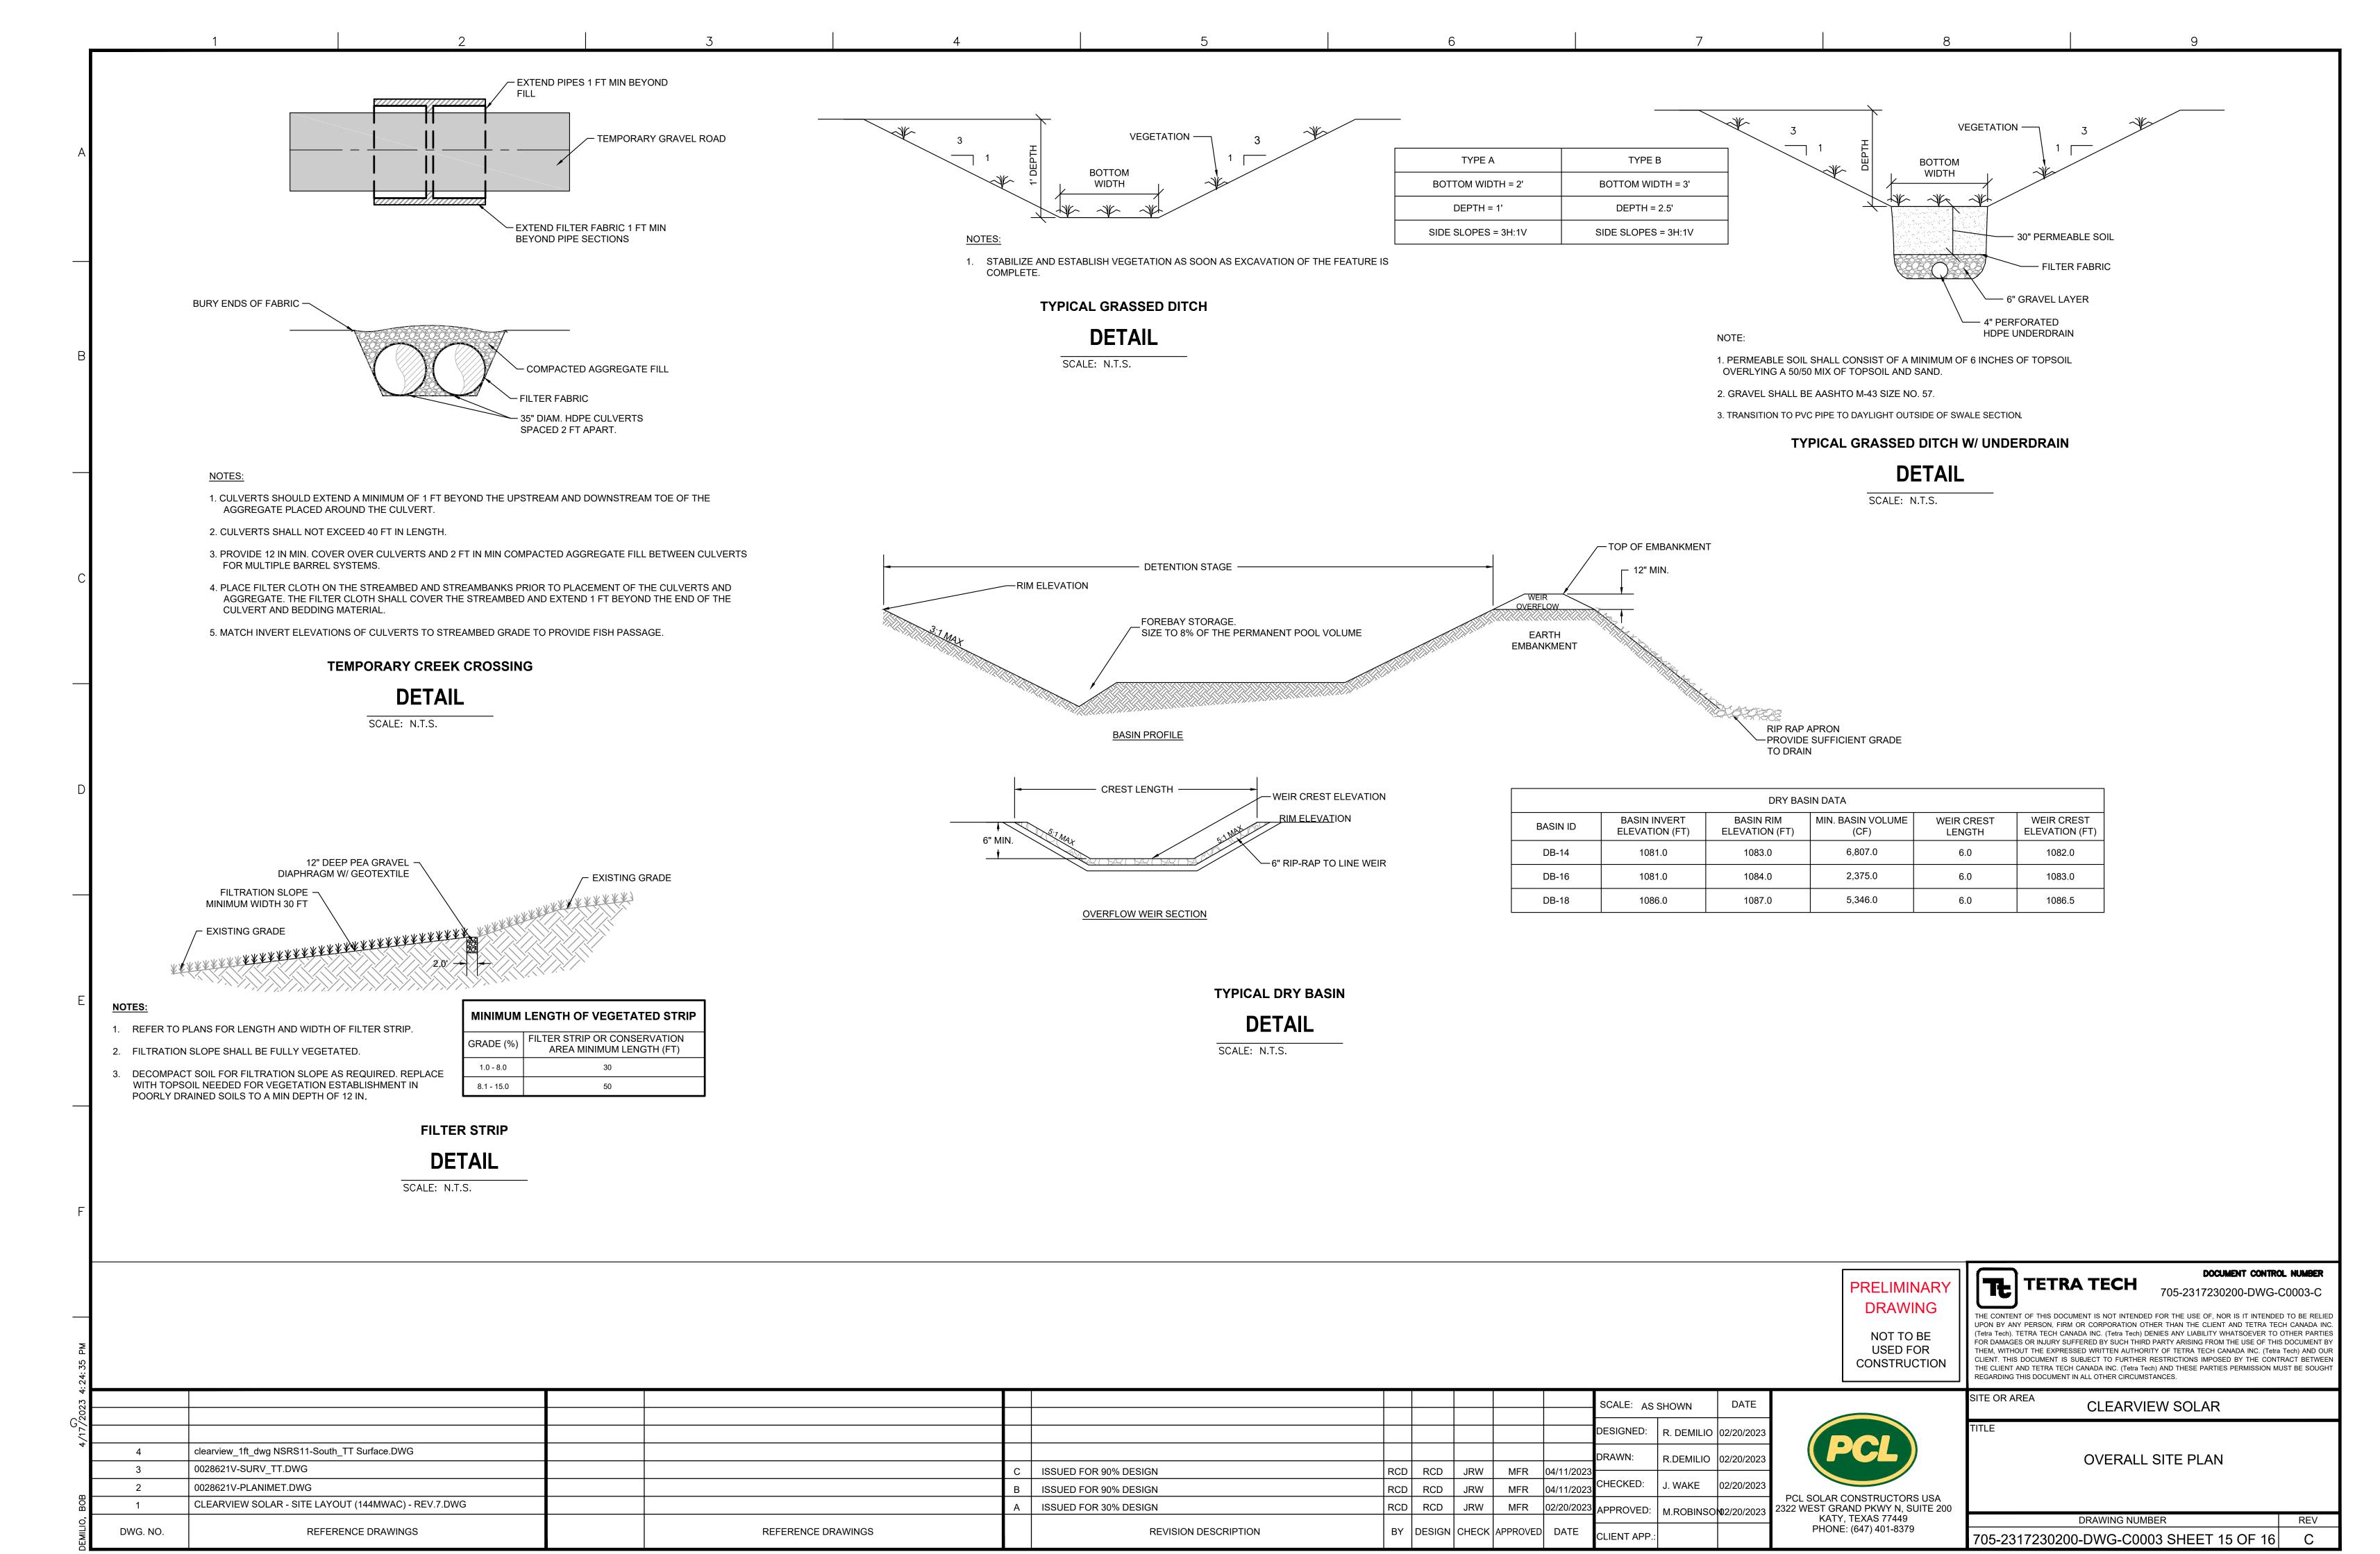

NOTES:

- 1. WATER QUALITY PONDS DEPICTED HERON SHALL ADHERE TO REQUIREMENTS OF THE OHIO EPA RAINWATER AND LAND DEVELOPMENT MANUAL, THIRD ADDITION, FOR A DRY EXTENDED DETENTION BASIN.
- 2. POND CONSTRUCTION SHALL COMPLY WITH PROVISIONS OF NRCS CONSERVATION PRACTICE 378.
- 3. PRIOR TO POND CONSTRUCTION, TOPSOIL SHALL BE SELECTIVELY STRIPPED, STOCKPILED, AND PRESERVED FOR POST GRADING ACTIVITY RESPREADING. A FIRM 6" STAND OF GRASS SHALL BE ESTABLISHED OVER ALL POND INVERT AND SIDE SLOPES. 4. PRIOR TO REPLACEMENT OF TOPSOIL, POND INVERT SHALL BE SCARIFIED TO A DEPTH OF 6" AND RUBBER TIRED EQUIPMENT PRECLUDED FROM REENTRY INTO THE INVERT
- THERE FOLLOWING. 5. ADHERE TO THE MOST RECENT VERSION OF THE OHIO EPA CONSTRUCTION GENERAL PERMIT FOR STORMWATER ASSOCIATED WITH CONSTRUCTION ACTIVITIES FOR POST CONSTRUCTION WATER QUALITY REQUIREMENTS.

WATER QUALITY POND MAINTENANCE

- MAINTENANCE OF THE WATER QUALITY POND SHALL INCLUDE (REFERENCE OEPA) 1. REMOVAL OF TEMPORARY RISERS USED FOR SEDIMENTS CONTROL (IF USED) AND RESEEDING BARE SOIL OR ESTABLISHING WETLAND VEGETATION IN DESIGNATED AREAS WITHIN THE POND.
- 2. SEDIMENT STORAGE REDUCE THE FREQUENCY PF SEDIMENT CLEANOUT BY INCREASING THE VOLUME OF SEDIMENT STORAGE INCREASING THE PERMANENT POOL VOLUME BY 20% OR ACCORDING TO THE PREDICTED SEDIMENT LOAD IS RECOMMENDED. PONDS USED FOR SEDIMENT CONTROL DURING CONSTRUCTION SHOULD BE CLEANED OUT WHEN SITE IS STABILIZED.


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3. SEDIMENT SHOULD BE SPOILED IN AREAS, WHICH WILL KEEP POLLUTANTS BOUND IN THE SEDIMENT. TO AVOID THESE POLLUTANTS FROM BECOMING SOLUBLE, ACID AND ANAEROBIC CONDITIONS, SUCH AS WETALNDS, SHOULD BE AVOIDED.

SCHEDULE	ACTIVITY			
MONTHLY	MOW EMBANKMENT AND CLEAN TRASH AND DEBRIS FROM OUTLET STRUCTURE. ADDRESS ANY ACCUMULATION OF HYDROCARBONS.			
ANNUALLY	INSPECT EMBANKMENT AND OUTLET STRUCTURE FOR DAMAGE AND PROPER FLOW. REMOVE WOODY VEGETATION AND FIX ANY ERODING AREAS. MONITOR SEDIMENT ACCUMULATIONS IN FOREBAY AND MAIN POOL.			
SEMI-ANNUAL LY	INSPECT WETLAND AREAS FOR INVASIVE PLANTS.			
3-7 YEARS	REMOVE SEDIMENT FROM FOREBAYS.			
5-20 YEARS	MONITOR SEDIMENT ACCUMULATIONS IN THE MAIN POOL AND CLEAN AS POND BECOMES EUTROPHIC OR POOL VOLUME IS REDUCED SIGNIFICANTLY.			


WATER QUALITY POND

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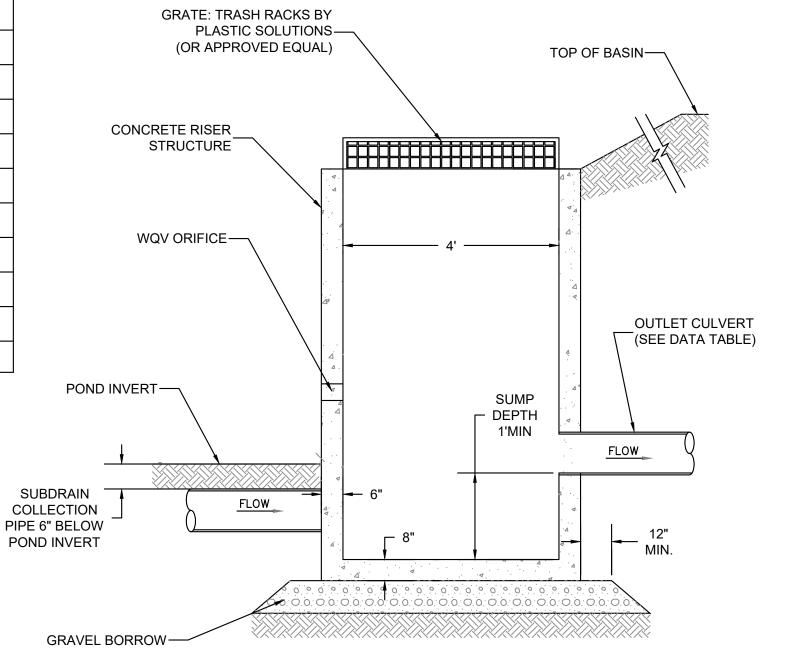


OUTLET STRUCTURE NOTES:

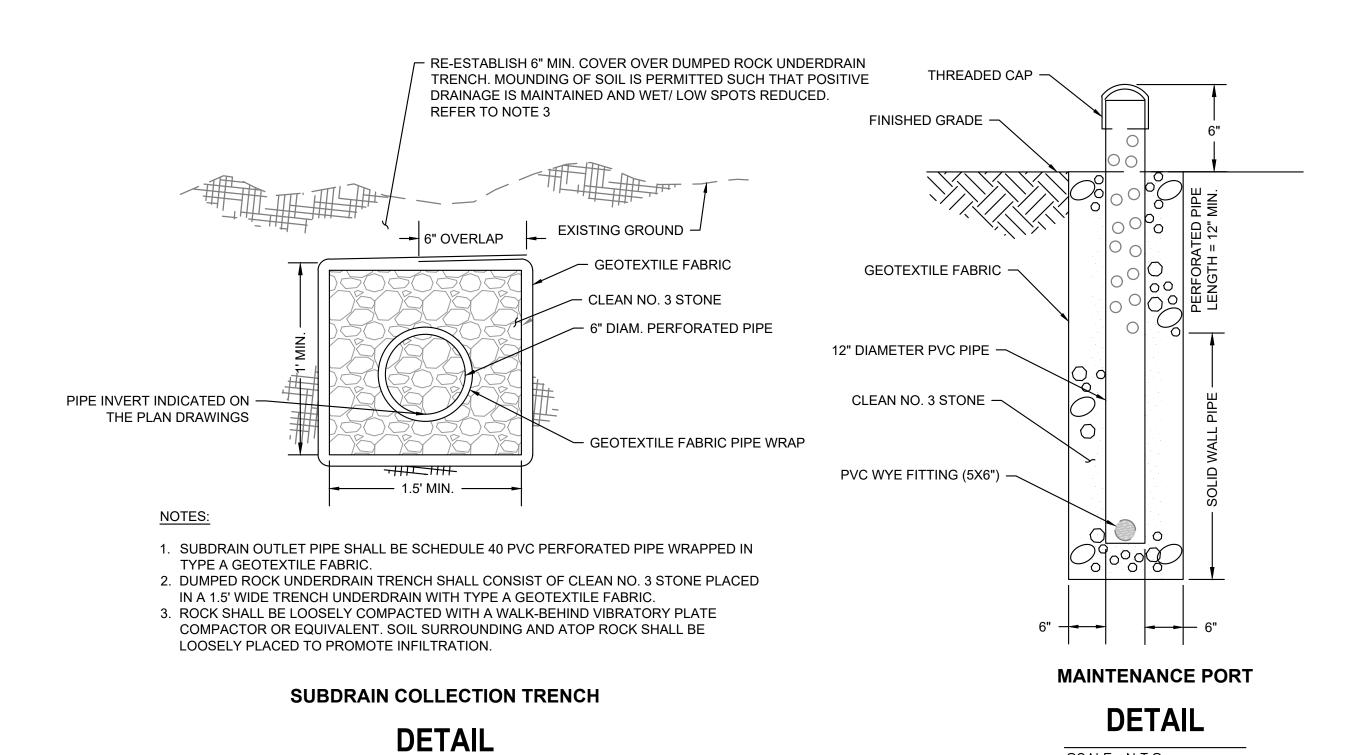- 1. CONCRETE SHALL BE COMPRESSIVE STRENGTH 4000 PSI.
- 2. STRUCTURE DESIGN SHALL CONFORM TO ASTM C-478 FOR "PRECAST REINFORCED CONCRETE MANHOLE SECTIONS."
- 3. IF DEPTH INSIDE STRUCTURE EXCEEDS 4'-6", INSTALL STEEL REINFORCED STEPS 12" O.C. WITH A PLASTIC COATING CONFORMING TO ASTM D4101, COPOLYMER POLYPROPYLENE.
- 4. WATERTIGHT SEAL AT PIPE CONNECTIONS SHALL BE MADE WITH RUBBER MANHOLE BOOT.
- 5. SIMILAR OUTLET STRUCTURES PROPOSED FOR BASINS 1 & 2. SEE BASIN OUTLET DATA CHART.

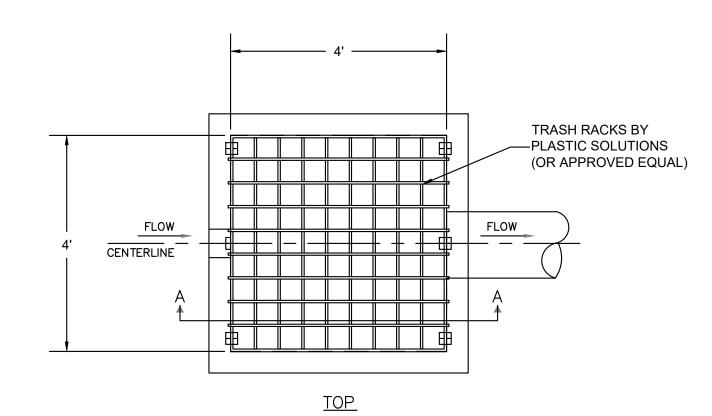

WQV POND DATA	
POND RIM ELEV. (FT)	1072.7
POND INVERT ELEV. (FT)	1069.7
GRATE ELEV. (FT)	1071.7
WQV ORIFICE ELEV. (FT)	1071.0
WQV ORIFICE DIAM. (IN)	1.5
OUTLET CULVERT DIAM. (IN)	6
OUTLET CULVERT LENGTH (FT)	35
OUTLET CULVERT MATERIAL	HDPE
OUTLET CULVERT INLET INV (FT)	1068.7
OUTLET CULVERT OUTLET INV (FT)	1068.0



SECTION A-A

WATER QUALITY POND OUTLET STRUCTURE

DETAIL

SCALE: N.T.S.

PRELIMINARY DRAWING

NOT TO BE

USED FOR

CONSTRUCTION



SITE OR AREA

DOCUMENT CONTROL NUMBER

705-2317230200-DWG-C0003-C

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CLEARVIEW SOLAR

SCALE: AS SHOWN DATE DESIGNED: R. DEMILIO 02/20/202 clearview_1ft_dwg NSRS11-South_TT Surface.DWG R.DEMILIO 02/20/20 0028621V-SURV_TT.DWG RCD | RCD | JRW | ISSUED FOR 90% DESIGN MFR 04/11/202 CHECKED: J. WAKE |02/20/202 0028621V-PLANIMET.DWG ISSUED FOR 90% DESIGN RCD | RCD | JRW | MFR 04/11/2023 CLEARVIEW SOLAR - SITE LAYOUT (144MWAC) - REV.7.DWG 02/20/2023 APPROVED: M.ROBINSO 02/20/202 ISSUED FOR 30% DESIGN RCD | RCD | JRW | MFR REFERENCE DRAWINGS REFERENCE DRAWINGS BY DESIGN CHECK APPROVED DATE DWG. NO. REVISION DESCRIPTION LIENT APP.:

SCALE: N.T.S.



PHONE: (647) 401-8379

KATY, TEXAS 77449

OVERALL SITE PLAN

DRAWING NUMBER REV 705-2317230200-DWG-C0003 SHEET 16 OF 16



Clearview Solar

Complaint Resolution Program

April 14, 2023





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	2.3	Complaint Documentation and Follow up	1



1. Introduction

Clearview Solar I, LLC ("Clearview Solar") has developed a complaint resolution program for implementation during the construction and operation of the Project to provide an effective process for identification and resolution of concerns voiced by members of the community. Clearview Solar is committed to complying with requirements established through the Ohio Power Siting Board ("OPSB") and other regulatory processes, and to establishing an accessible process for community members to voice concerns and for those concerns to be addressed as quickly and effectively as possible. Maintaining detailed records of all complaints and resulting actions is an important aspect of the complaint resolution program. Clearview Solar's policy is to take all reasonable and necessary actions to rectify disturbances that are a direct result of the Project.

2. Complaint Resolution Procedure

2.1 Clearview Solar Contacts

Clearview Solar has established a toll-free telephone number (1-(833) 604-7125) and will provide that number to the county commissioners, township trustees, emergency responders, schools, and public libraries within the Project Area; that number is also posted on the Project website (https://www.clearviewsolarproject.com). To register a complaint, individuals may call the telephone number and leave a message. Phone messages left at the provided number will be checked daily, Monday thru Friday and initial follow up will occur within two business days. Complaints received by letter, email, and through the project website will also receive prompt follow-up within two business days of their receipt. Any emergency situations should be addressed with the appropriate local authorities or by calling 911.

2.2 Notification

Clearview Solar will provide contact information and details regarding the Complaint Resolution Program to the officials and public locations noted above. Clearview Solar will also maintain a Project contact list and will provide notification to affected property owners and tenants including those individuals who were provided notice of the public informational meeting, residences located within one mile of the project area, parties to this case, county commissioners, township trustees, emergency responders, airports, schools, and libraries, as well as anyone who has requested updates regarding the project., seven (7) days prior to the start of construction and seven (7) days prior to start of facility operations.

2.3 Complaint Documentation and Follow up


Clearview Solar will keep a logbook to register every complaint received. The logbook will include pertinent information about the person making the complaint, the issues surrounding the complaint, and the date the complaint was received; the complaint resolution form is attached. The logbook will also document Clearview Solar's



recommended resolution, the date agreement was reached on a proposed resolution, and the date when the proposed resolution was implemented. Clearview Solar personnel will generate a quarterly report based on the information recorded in the logbook about the nature and resolution of all complaints received in that quarter and submit the report to OPSB Staff by the fifteenth day of April, July, October and January during construction and for the first five years of operation. No later than two business days after an individual registers a complaint, Clearview Solar will respond by phone to that individual if contact information is provided with the complaint. If a phone number is not provided, Clearview will reply by mail or email, whichever is provided by the individual registering the complaint. The intent of the initial correspondence is to gather more information to better understand the complaint. Within 30 days of the complaint being logged, Clearview Solar will initiate reasonable action to resolve any legitimate interference or disturbance that is a direct result of the Project.

If Clearview Solar and the complaining individual cannot agree to a resolution, Clearview Solar will provide a summary of the complaint and proposed resolution to the complaining individual and document this information in the logbook.

Diagram of Complaint Resolution Process

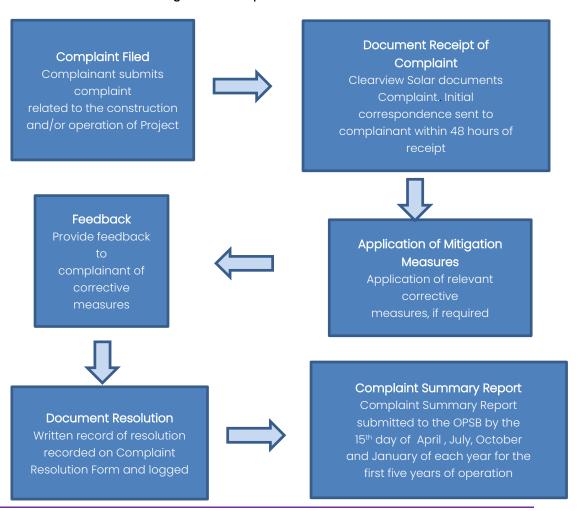



Clearview Solar Complaint Resolution Form

Complaint Log Number:	
Complainant's name and address:	
Phone number/email:	
Date complaint received:	
Time complaint received:	
Date complainant first contacted:	
Nature of complaint:	
Definition of problem after investigation:	
Description of corrective measures taken:	
Complainant's signature:	Date:
Clearview Solar Project Manager Signature:	Date:

(Attach additional pages and supporting documentation, as required.)



This foregoing document was electronically filed with the Public Utilities Commission of Ohio Docketing Information System on

4/19/2023 4:50:17 PM

in

Case No(s). 20-1362-EL-BGN

Summary: Correspondence Correspondence Regarding Compliance with Conditions 6, 8 - 11, 15, 22, 29, 32, and 33 electronically filed by Ms. Anna Sanyal on behalf of Clearview Solar, LLC.