




## **Exhibit A**

### **Preliminary Site Plan**


**Case No. 20-1814-EL-BGN**

# DODSON CREEK SOLAR

## HIGHLAND COUNTY OHIO

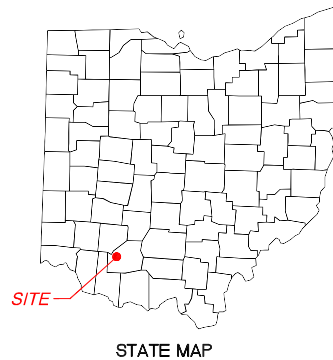

STATE MAP

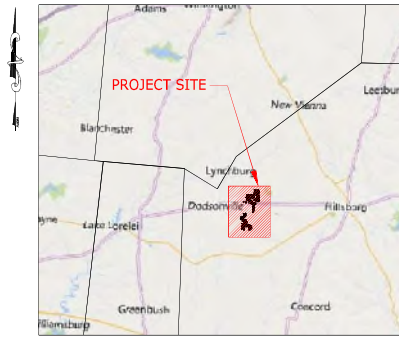

VICINITY MAP

### Sheet List Table

Sheet Number	Sheet Title
DDC-E-000-01	COVER SHEET
DDC-E-000-02	LEGEND & SYMBOLS
DDC-E-500-03	OVERALL SOLAR ARRAY SITE PLAN
DDC-E-502-01	SOLAR ARRAY SITE PLAN
DDC-E-502-02	SOLAR ARRAY SITE PLAN
DDC-E-502-03	SOLAR ARRAY SITE PLAN
DDC-E-502-04	SOLAR ARRAY SITE PLAN
DDC-E-502-05	SOLAR ARRAY SITE PLAN
DDC-E-502-06	SOLAR ARRAY SITE PLAN
DDC-E-502-07	SOLAR ARRAY SITE PLAN
DDC-E-502-08	SOLAR ARRAY SITE PLAN
DDC-E-502-09	SOLAR ARRAY SITE PLAN
DDC-E-502-10	SOLAR ARRAY SITE PLAN
DDC-E-501-01	COLLECTOR SYSTEM SINGLE DIAGRAM
DDC-E-522-01	COLLECTION SYSTEM CABLE CROSSING DETAILS
DDC-E-522-02	COLLECTION SYSTEM CABLE CROSSING DETAILS
DDC-E-530-01	SHOALS BLA HARNESS & TRUNK BUS CABLE SYSTEM
DDC-E-200-01	SUBSTATION SINGLE LINE DIAGRAM
DDC-E-200-02	SUBSTATION DEVICE LEGEND
DDC-E-210-01	SUBSTATION EQUIPMENT GENERAL ARRANGEMENT
DDC-E-211-01	SUBSTATION EQUIPMENT SECTION A-A
DDC-E-211-02	SUBSTATION EQUIPMENT SECTION B-B & SECTION C-C

### PROJECT DESCRIPTION & NOTES

- BOUNDARY INFORMATION PROVIDED BY NATIONAL GRID RENEWABLES.
- TOPOGRAPHIC INFORMATION SHOWN FROM OHIO PUBLIC LIDAR DATABASE.
- WETLAND INFORMATION PROVIDED BY NATIONAL WETLAND INVENTORY
- PARCEL DATA PROVIDED BY LANDGRID DATA STORE



**OWNER:**  
NATIONALGRID RENEWABLES  
8400 NORMANDALE LAKE BLVD. SUITE 1200  
BLOOMINGTON, MN 55437



**ENGINEER:**  
TIMMONS GROUP  
971 NORTH GILBERT ROAD, SUITE 204  
GILBERT, AZ 85234  
TELEPHONE: (480) 386-8058  
WWW.TIMMONS.COM



PROJECT NAME & ADDRESS

**DODSON  
CREEK SOLAR**  
HIGHLAND COUNTY  
OHIO

DATE: 04/02/2021  
PROJECT NUMBER: 47486  
DRAWN BY: R. SIERRA  
CHECKED BY: S. UPADHYAY

**PRELIMINARY  
NOT FOR CONSTRUCTION**

REVISIONS	
1	ISSUED FOR PERMIT
2	ISSUED FOR PERMIT
3	ISSUED FOR PERMIT
4	ISSUED FOR PERMIT
5	ISSUED FOR PERMIT

COVER SHEET

SCALE	1"=100'
DATE	04/02/2021


# LEGEND

	PROJECT AREA
	PROPERTY LINE
	EXISTING ROADS CENTERLINE
	EXISTING DIRT ROADS
	ROAD RIGHT OF WAY
	EXISTING RAIL ROAD TRACKS
	RAIL ROAD RIGHT OF WAY
	EXISTING FENCE LINE
	STREAMS
	WETLAND BOUNDARY
	100-YEAR FLOOD BOUNDARY
	EXISTING EASEMENT
	NATURAL GAS PIPELINE
	EXISTING OVERHEAD LINE
	EROSION CONTROL BUFFER
	EXISTING LANDSCAPE SCREENING
	EXISTING LANDSCAPE SCREENING
	EXISTING TREE LINE AVOIDANCE
	OUTSIDE OF PROJECT BOUNDARY
	50' EQUIPMENT SETBACK
	50' ROAD SETBACK
	300' RESIDENTIAL SETBACK
	20' WETLAND SETBACK
	LAYDOWN AREA
	OVERBUILD AREAS
	PROPOSED SITE FENCE
	16' PROPOSED SITE ROAD
	PROPOSED CIRCUIT 11A
	PROPOSED CIRCUIT 11B
	PROPOSED CIRCUIT 12A
	PROPOSED CIRCUIT 12B

# SYMBOLS

	PROPOSED 34.5kV OVERHEAD POLE
	MV JUNCTION BOX / MV SECTIONALIZING CABINET
	DIRECTIONAL BORE
	JUNCTION BOX
	INVERTER PAD
	PV PANEL TRACKER
	PROPOSED MET STATION
	ENTRANCE / EXIT POINTS

Y:\MVA\0819 - Dodson Creek Solar\DWG\SitePlan.dwg [Printed on 4/16/2021, 1:35 PM] by Robert Sierra

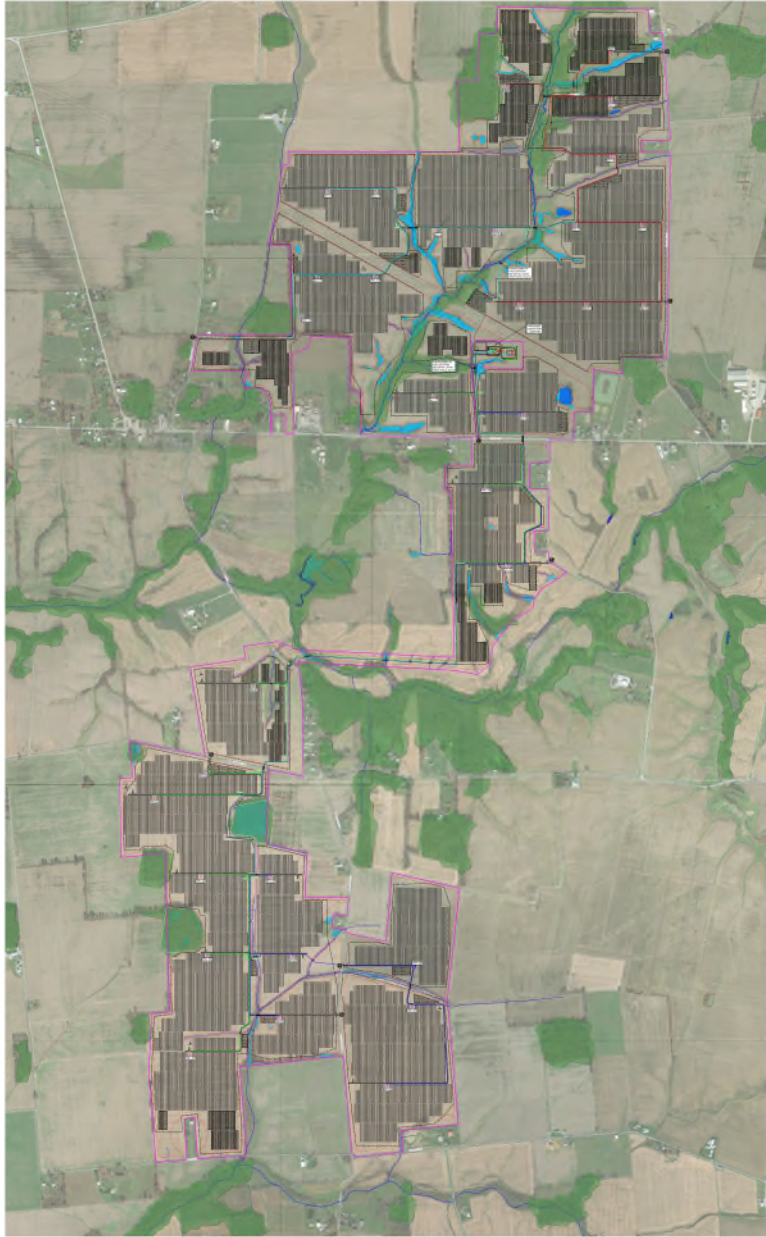

### QUANTITY SUMMARY

SYSTEM DC RATING (MW)	193.08
SYSTEM AC CAPACITY (MW)	117
SYSTEM AC NAMEPLATE (MW)	134.4
DC/AC RATIO (AT INVERTER)	1.48
DC/AC (AT PO)	1.85
MODULE MODEL	JAM72030-540W
GCR	4.30
PITCH (CENTER TO CENTER)	25
TOTAL 540W MODULES	357,502
INVERTER MODEL	SMA SC4000-UP
TOTAL NUMBER INVERTERS	32
MODULES PER STRING	26
TOTAL STRINGS	13,752
DC SYSTEM VOLTAGE (V)	1500
COLLECTOR SYSTEM VOLTAGE (KV)	34.5
AC MVAH	9

**TIMMONS GROUP**  
CONSULTING ENGINEERS & ARCHITECTS  
1001 North 10th Street, Suite 200  
Tulsa, Oklahoma 74103  
Tel: 918.582.8555 Fax: 918.582.8555 www.timmons.com

**nationalgrid**  
renewables

PROJECT NAME & ADDRESS

**DODSON CREEK SOLAR**  
HIGHLAND COUNTY  
OHIO

DATE: 04/16/2021

PROJECT NUMBER: 47489

DRAWN BY: R. SIERRA

CHECKED BY: S. UPADHYAY

SCALE:

**PRELIMINARY**  
NOT FOR CONSTRUCTION

REVISIONS	
#	DESCRIPTION
1	ISSUED BY
2	REVISED BY
3	REVISED BY
4	REVISED BY
100	REVISED BY

DRAWING DESCRIPTION

**OVERALL SOLAR ARRAY SITE PLAN**

8 1/2" X 11" FULL SIZE  
(11" X 17" PLOTS AND SHEET SCALES)


SCALE	SHEET NUMBER
1" = 1,000'	DDC-E-500-03

SCALE 1"=1,000'


0 1,000' 2,000'

Call at least two full working days before you begin excavation.

**811** Know what's below.  
Call 811 before you dig.

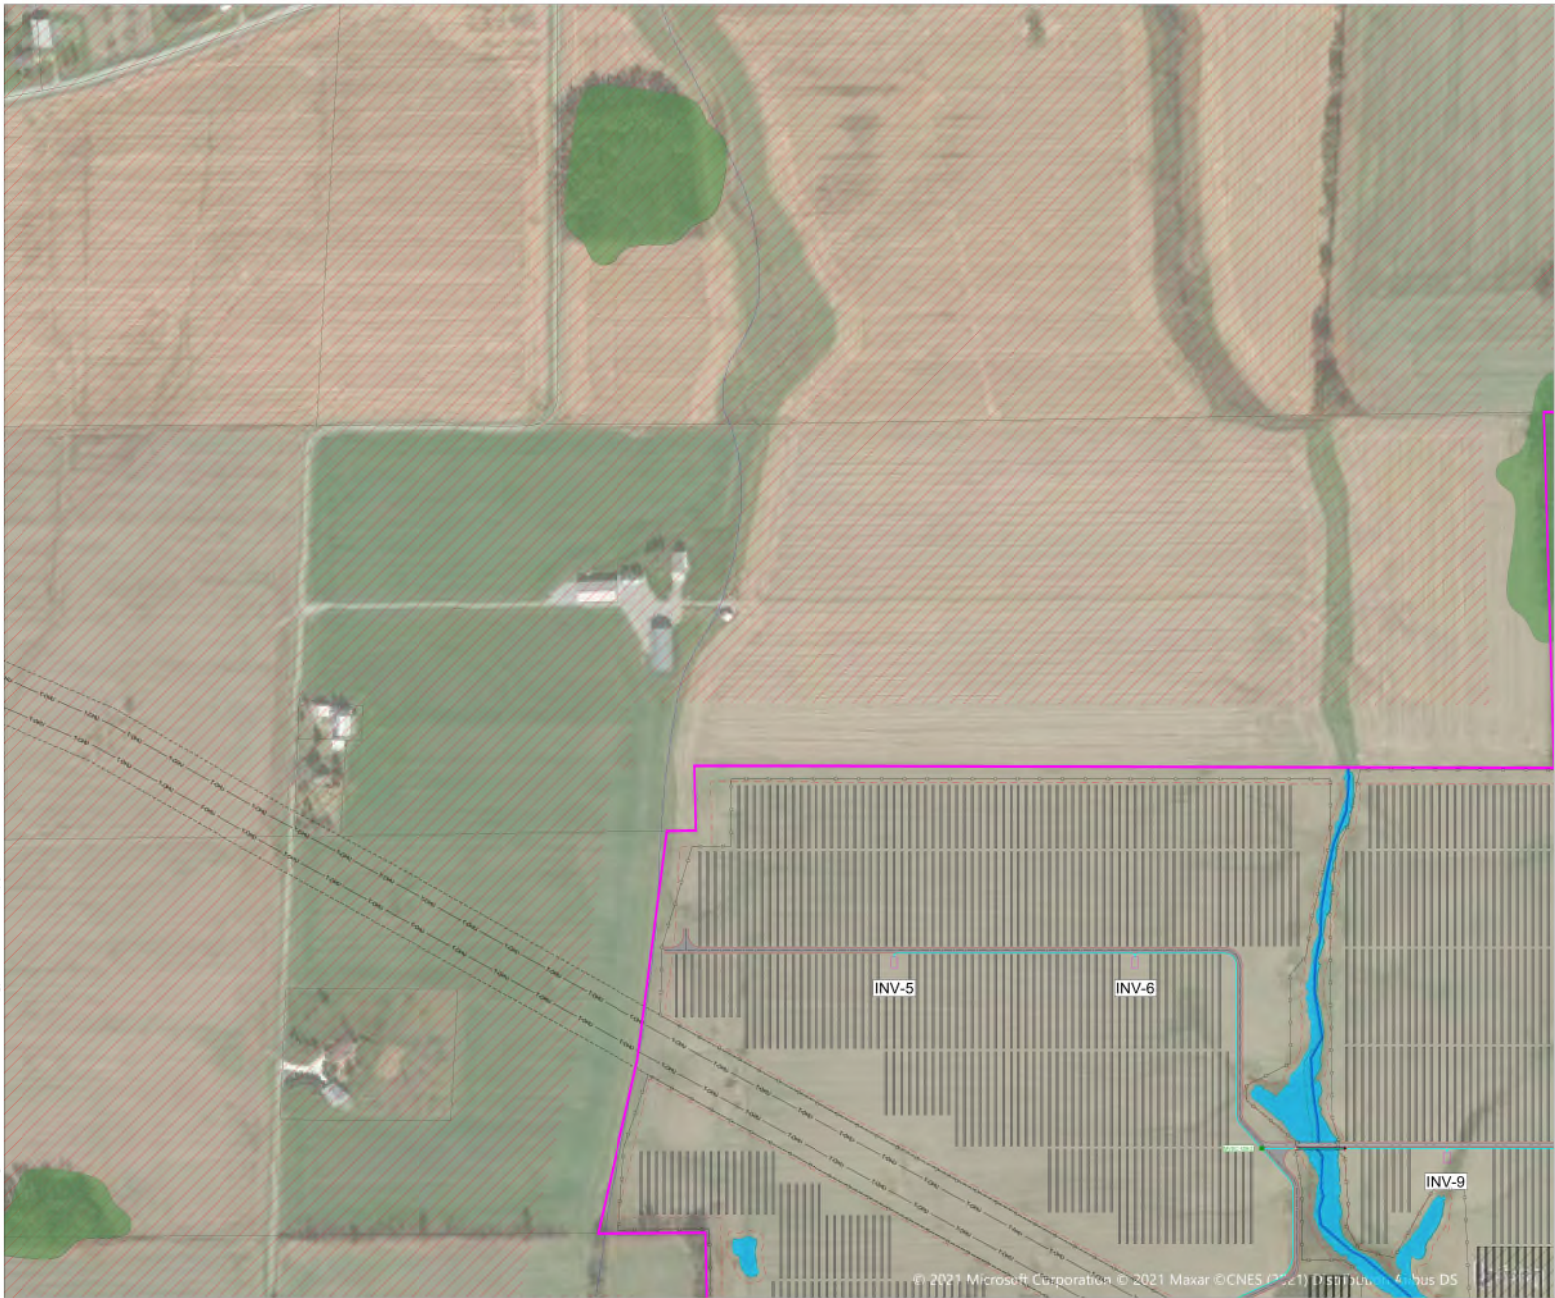

**KEYMAP:**

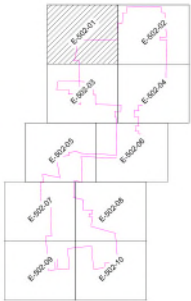

NOTE:  
A SINGLE JB IS REQUIRED AT EVERY DIRECTIONAL BORE.  
CONTRACTOR SHALL DETERMINE PLACEMENT OF JB IN  
DIRECTIONAL BORING

**TIMMONS GROUP**  
YOUR PARTNER IN CONSTRUCTION  
1000 N. HIGHWAY 100, SUITE 100, COLUMBUS, OH 43240  
TEL: 614.291.1000 FAX: 614.291.1001 www.timmons.com

**nationalgrid**  
renewables

**DODSON CREEK SOLAR**  
HIGHLAND COUNTY OHIO

DATE:	04/15/2021
PROJECT NUMBER:	47489
DESIGNED BY:	R. SIERRA
DESIGNED BY:	S. UPADHYAY

**PRELIMINARY**  
NOT FOR CONSTRUCTION

#	REVISION	DESCRIPTION
1	REVISED	ADDED NEW ROWS
2	REVISED	ADDED NEW ROWS
3	REVISED	ADDED NEW ROWS
4	REVISED	ADDED NEW ROWS
5	REVISED	ADDED NEW ROWS
6	REVISED	ADDED NEW ROWS
7	REVISED	ADDED NEW ROWS
8	REVISED	ADDED NEW ROWS
9	REVISED	ADDED NEW ROWS
10	REVISED	ADDED NEW ROWS


**SOLAR ARRAY SITE PLAN**

REVISED FULL SIZE  
(17" X 22" PLATES ARE USED FOR ALL)


SCALE: 1" = 200'

DATE: 04/15/2021

V:\M147189 - Dodson Creek Solar\Proj\Drawings\DDC-E-502-01 SOLAR ARRAY SITE PLAN.dwg (Plotted on 4/16/2021 1:23 PM by: Rylan Davis)

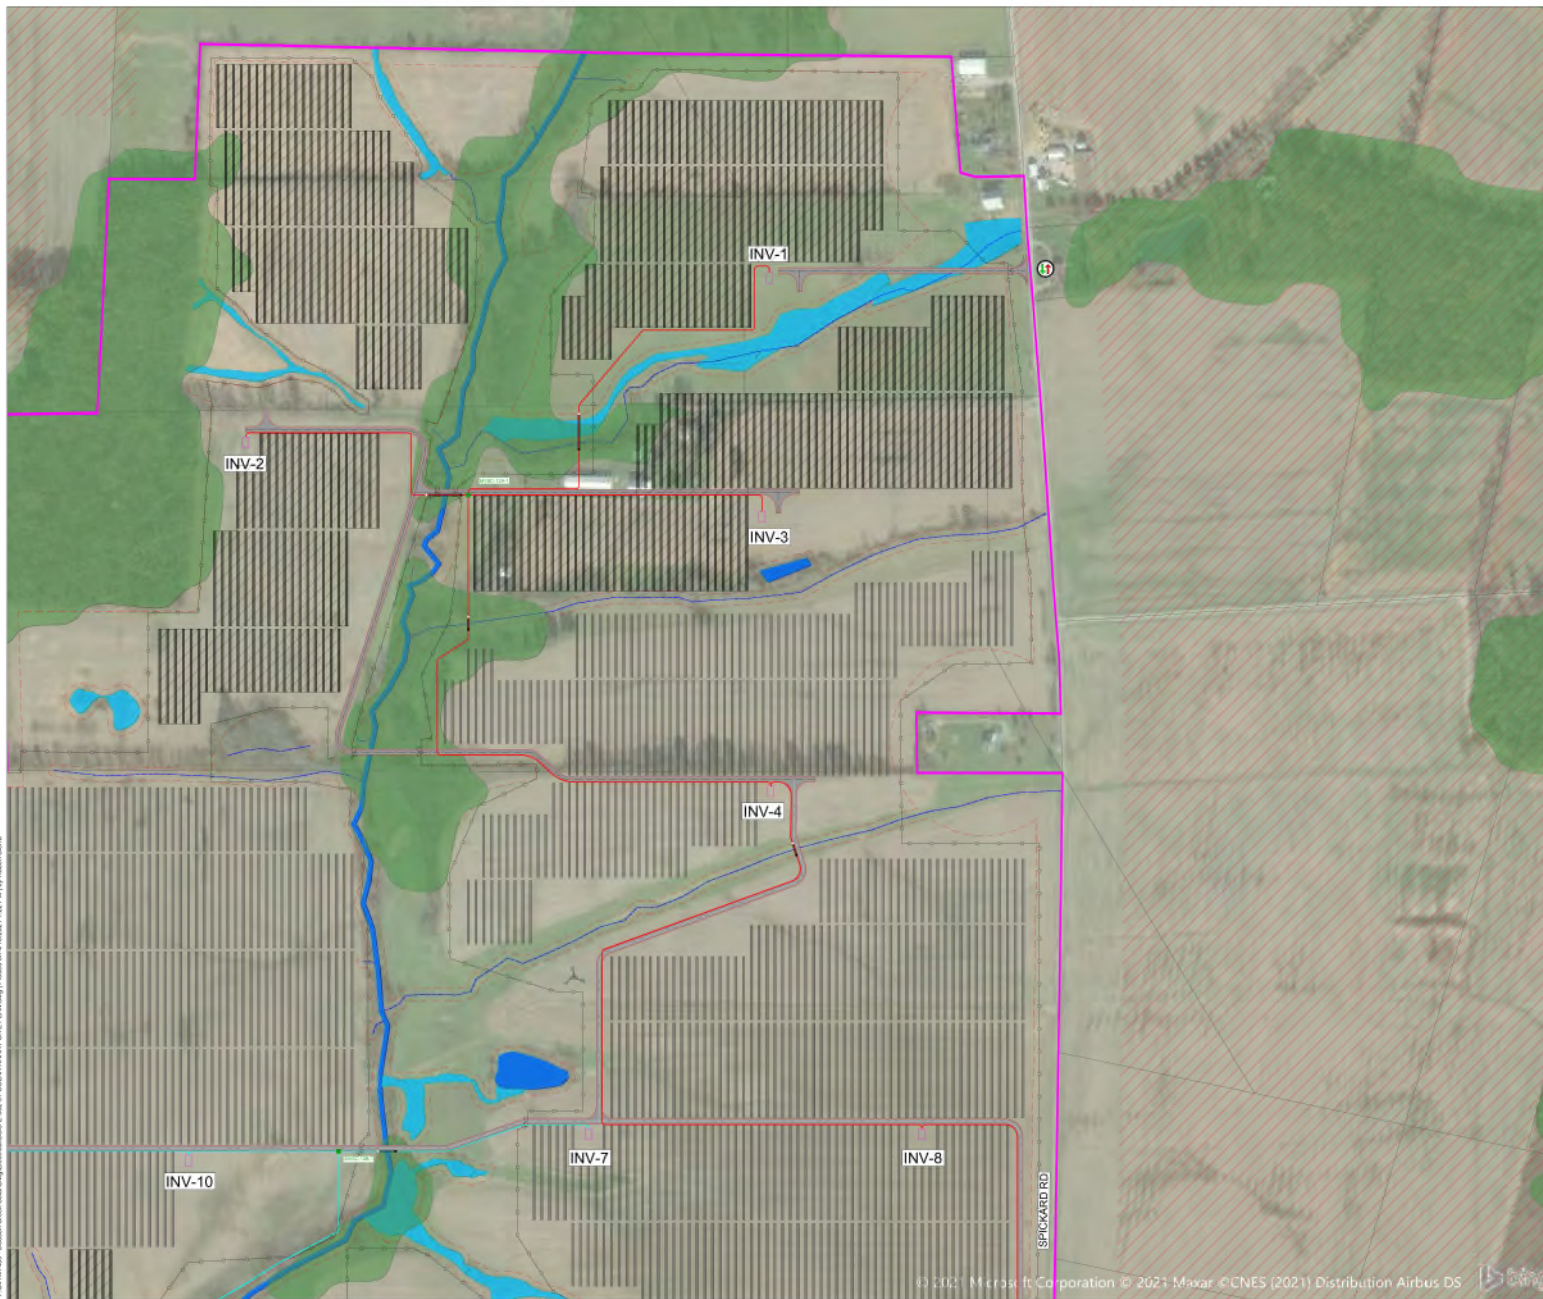

#### KEYMAP:

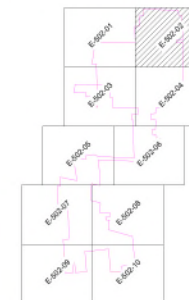

NOTE:  
A SINGLE JB IS REQUIRED AT EVERY DIRECTIONAL BORE.  
CONTRACTOR SHALL DETERMINE PLACEMENT OF JB IN  
DIRECTIONAL BORING



SCALE 1"=200'  
0 200' 400'



Know what's below.  
Call 811 before you dig.

PROJECT NAME & ADDRESS

**DODSON  
CREEK SOLAR**  
HIGHLAND COUNTY  
OHIO

DATE: 04/16/2021  
PROJECT NUMBER: 47489  
PREPARED BY: R. SIERRA  
DESIGNED BY: S. UPADHYAY  
DRAWN BY:

**PRELIMINARY  
NOT FOR CONSTRUCTION**


REVISIONS	
#	DESCRIPTION
1	REVISED: REVISION 1
2	REVISED: REVISION 2
3	REVISED: FOR COUNTY APPROVAL
4	REVISED: REVISION 3
5	REVISED: REVISION 4

DRAWING DESCRIPTION:

**SOLAR  
ARRAY SITE  
PLAN**

1/4" = 1" FULL SIZE  
(OTHER PLOTS ARE HALF SCALE)


SCALE: 1" = 200' SHEET NUMBER: DDC-E-502-02

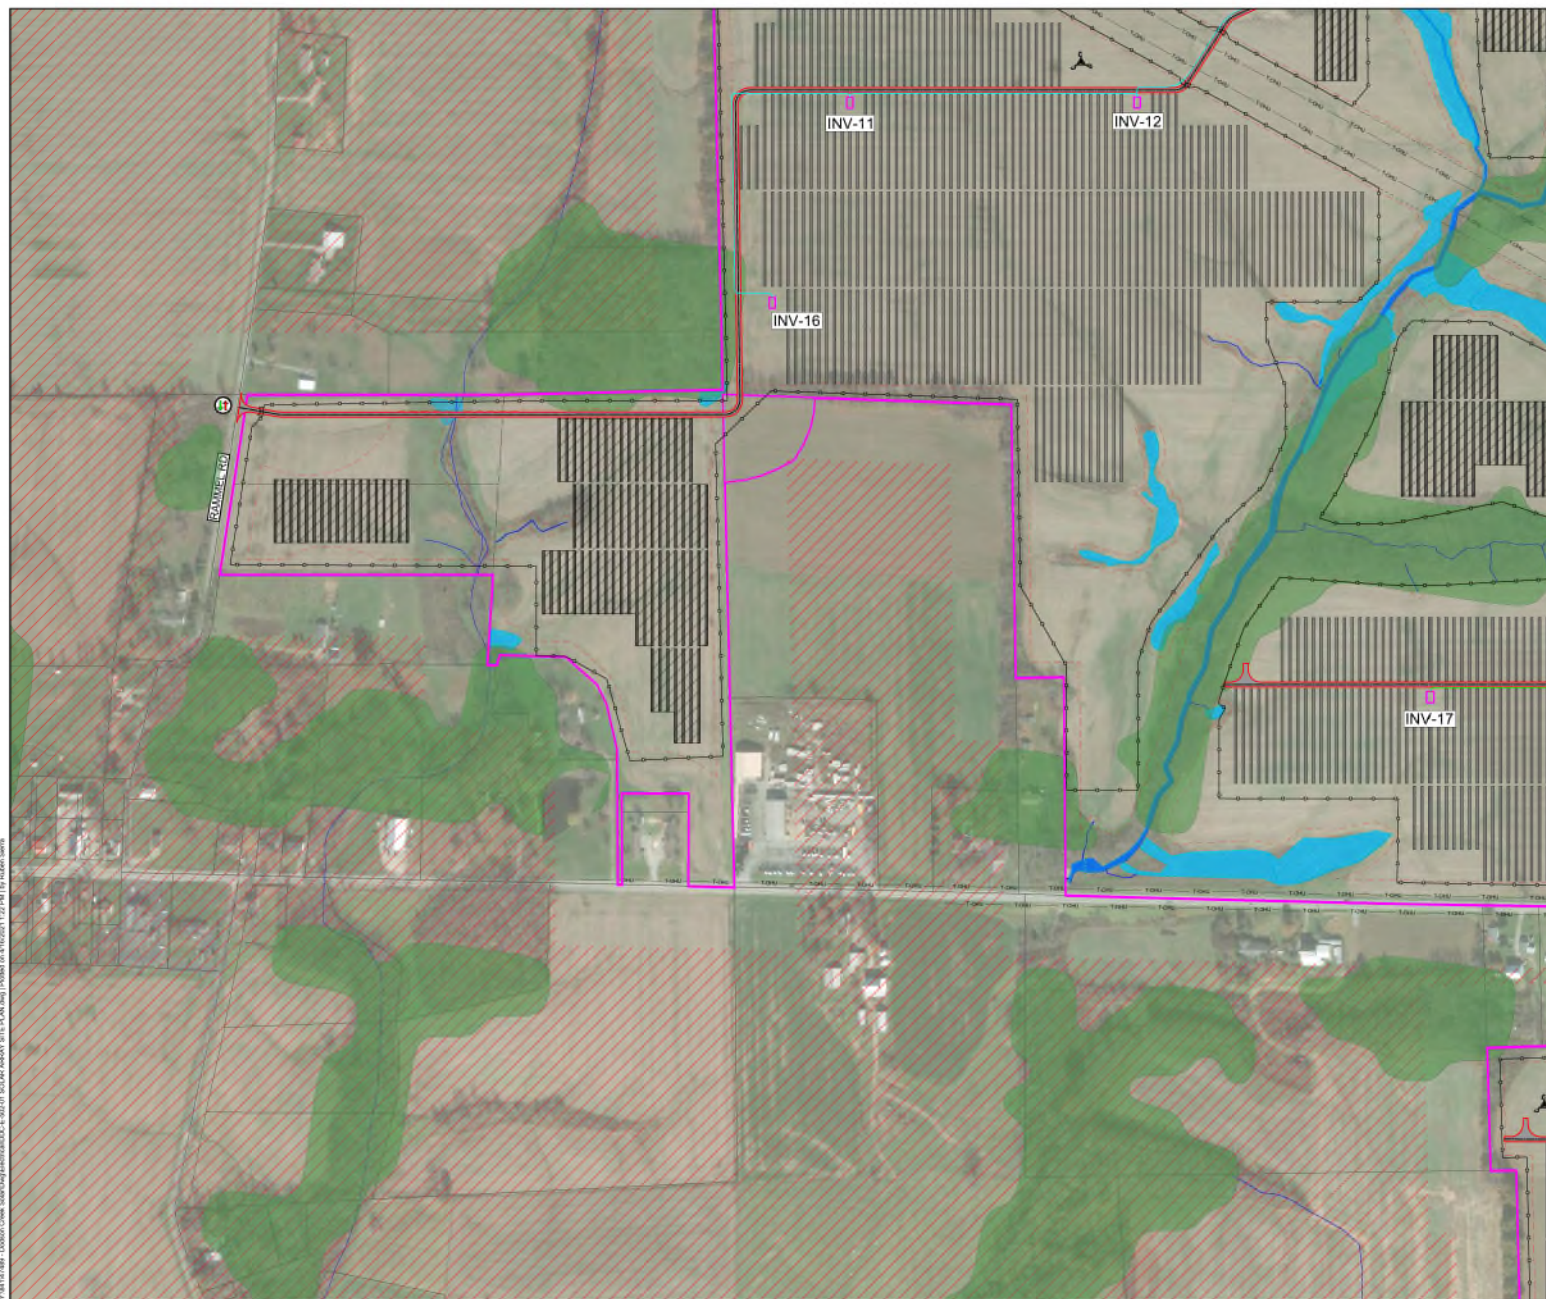

34"x22" FULL SIZE (17"x11" PLOTS ARE HALF SCALED)	
SCALE	SHEET NUMBER
1" = 200'	ODC-E-502-0



**KEYMAP:**

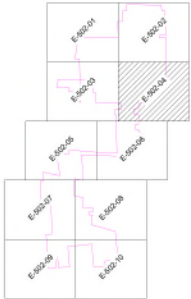

**NOTE:**  
A SINGLE JB IS REQUIRED AT EVERY DIRECTIONAL BORE.  
CONTRACTOR SHALL DETERMINE PLACEMENT OF JB IN  
DIRECTIONAL BORING

**TIMMONS GROUP**  
YOUR BEST CHOICE FOR THE FUTURE  
THE DODSON CREEK SOLAR ARRAY  
811 before you dig. Call 811 before you dig.  
811 before you dig. Call 811 before you dig.  
811 before you dig. Call 811 before you dig.

**nationalgrid**  
renewables

**DODSON CREEK SOLAR**  
HIGHLAND COUNTY OHIO

DATE: 04/18/2021  
PROJECT NUMBER: 47489  
DESIGNED BY: R. SIERRA  
CHECKED BY: S. UPADHYAY


**PRELIMINARY**  
NOT FOR CONSTRUCTION

REVISIONS	
#	DESCRIPTION
1	ISSUED FOR PERMITTING
2	ISSUED FOR PERMITTING
3	ISSUED FOR PERMITTING
4	ISSUED FOR PERMITTING
5	ISSUED FOR PERMITTING
6	ISSUED FOR PERMITTING
7	ISSUED FOR PERMITTING
8	ISSUED FOR PERMITTING
9	ISSUED FOR PERMITTING
10	ISSUED FOR PERMITTING


**SOLAR ARRAY SITE PLAN**

811 Know what's below.  
Call 811 before you dig.


V:\M147189 - Dodson Creek Solar\Proj\Drawings\DDC-E-502-01 SOLAR ARRAY SITE PLAN.dwg (Plotted on 4/16/2021 1:25 PM) by: Brian Sarno

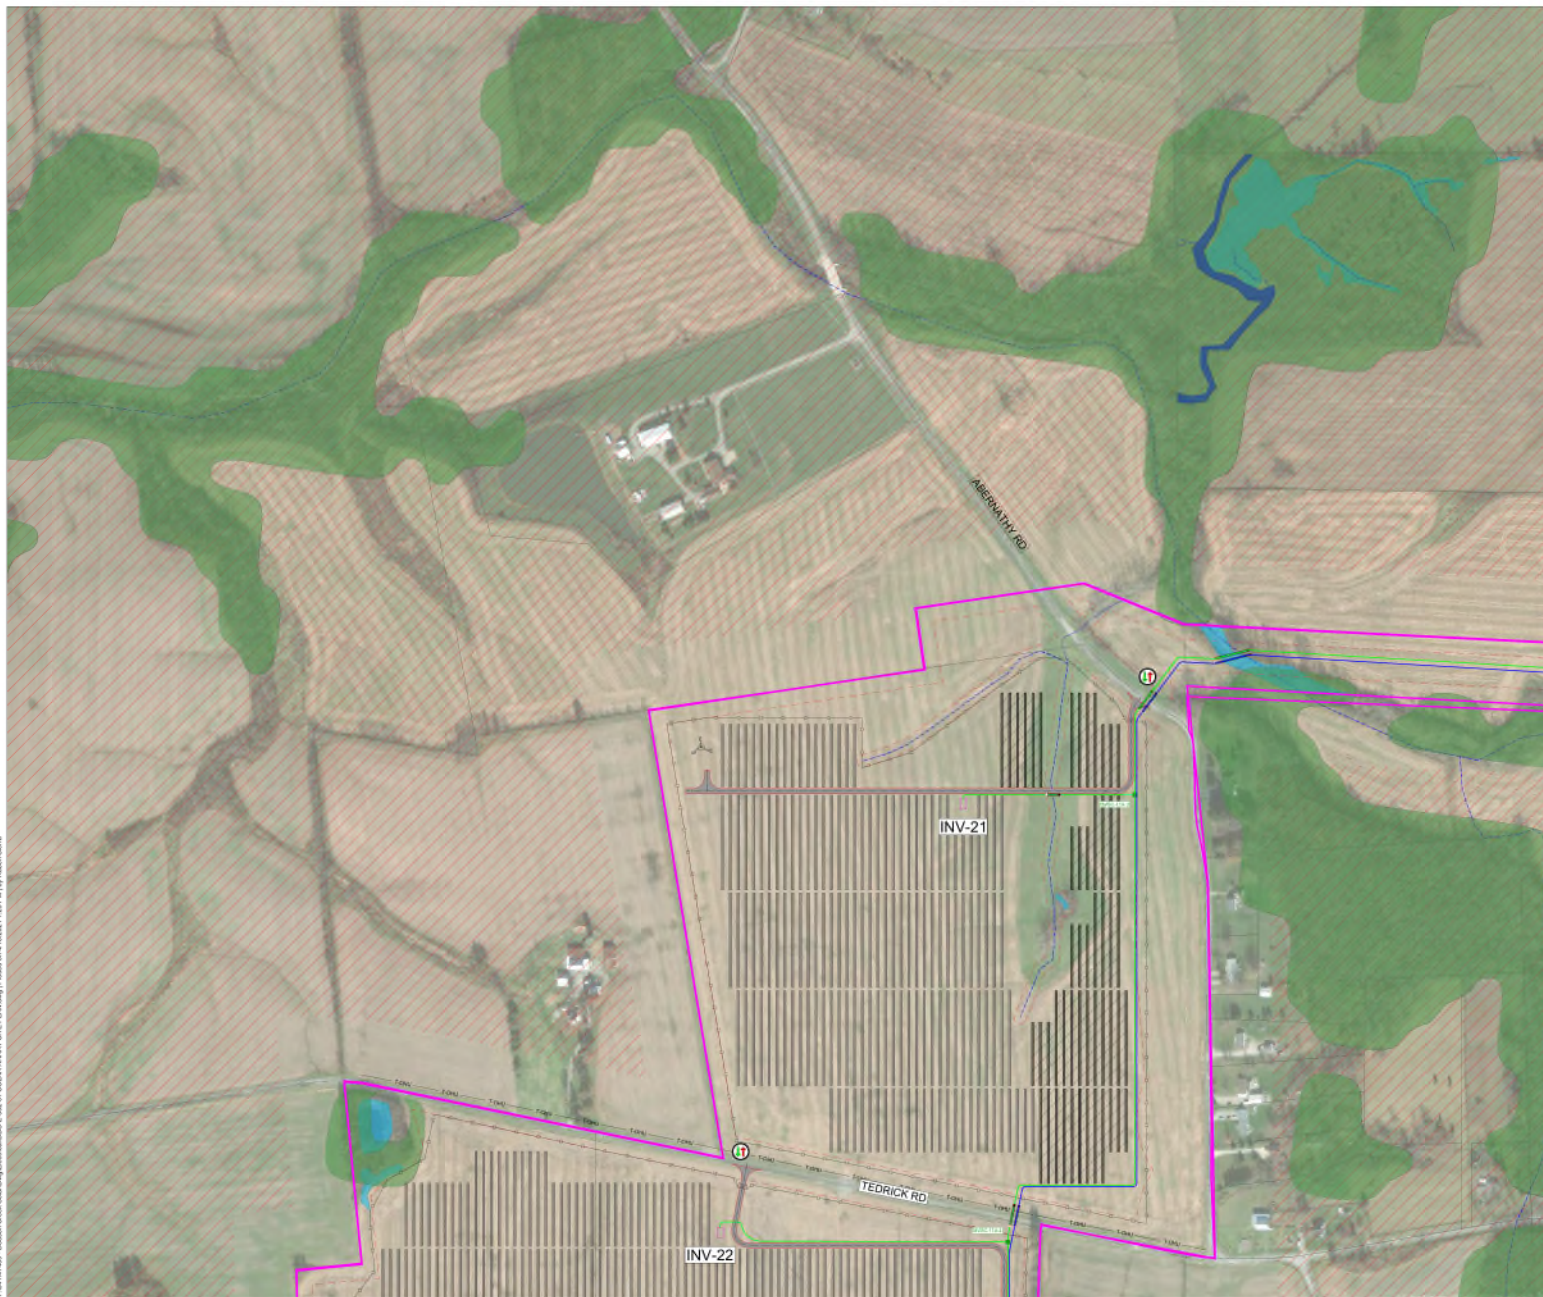

**KEYMAP:**

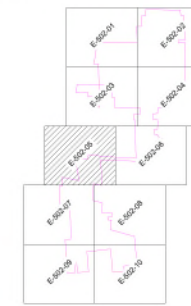

**NOTE:**  
A SINGLE JB IS REQUIRED AT EVERY DIRECTIONAL BORE.  
CONTRACTOR SHALL DETERMINE PLACEMENT OF JB IN  
DIRECTIONAL BORING

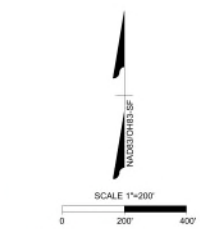

Call at least two full working days  
before you begin excavation.

**811** Know what's below.  
Call 811 before you dig.

**TIMMONS GROUP**  
FOUNDER, DESIGN, CONSTRUCTION, MAINTENANCE  
321 North Green Street, Suite 200, AT 2224  
Tulsa, Oklahoma 74103  
TEL: 918.258.2555 FAX: 918.258.2553 www.timmons.com

**nationalgrid**  
renewables

PROJECT NAME & ADDRESS

**DODSON CREEK SOLAR**  
HIGHLAND COUNTY  
OHIO

DATE: 04/16/2021

PROJECT NUMBER: 47459

PREPARED BY: R. SIERRA

DESIGNED BY: S. UPADHYAY

SCALE:

**PRELIMINARY**  
NOT FOR CONSTRUCTION

REVISIONS	
#	DESCRIPTION
1	ISSUED
2	REVISED
3	REVISED
4	REVISED
100	REVISED


DRAWING DESCRIPTION:

**SOLAR ARRAY SITE PLAN**

3/4" X 27" FULL SIZE  
(1/4" X 11" PLOTS ARE HALF SCALE)

SCALE	SHEET NUMBER
1" = 200'	DDC-E-502-06

\\M1472189 - Dodson Creek Solar\Proj\Drawings\DDC-E-502-01 SOLAR ARRAY SITE PLAN.dwg (Plotted on 4/10/2021 1:28 PM) by: Brian Davis

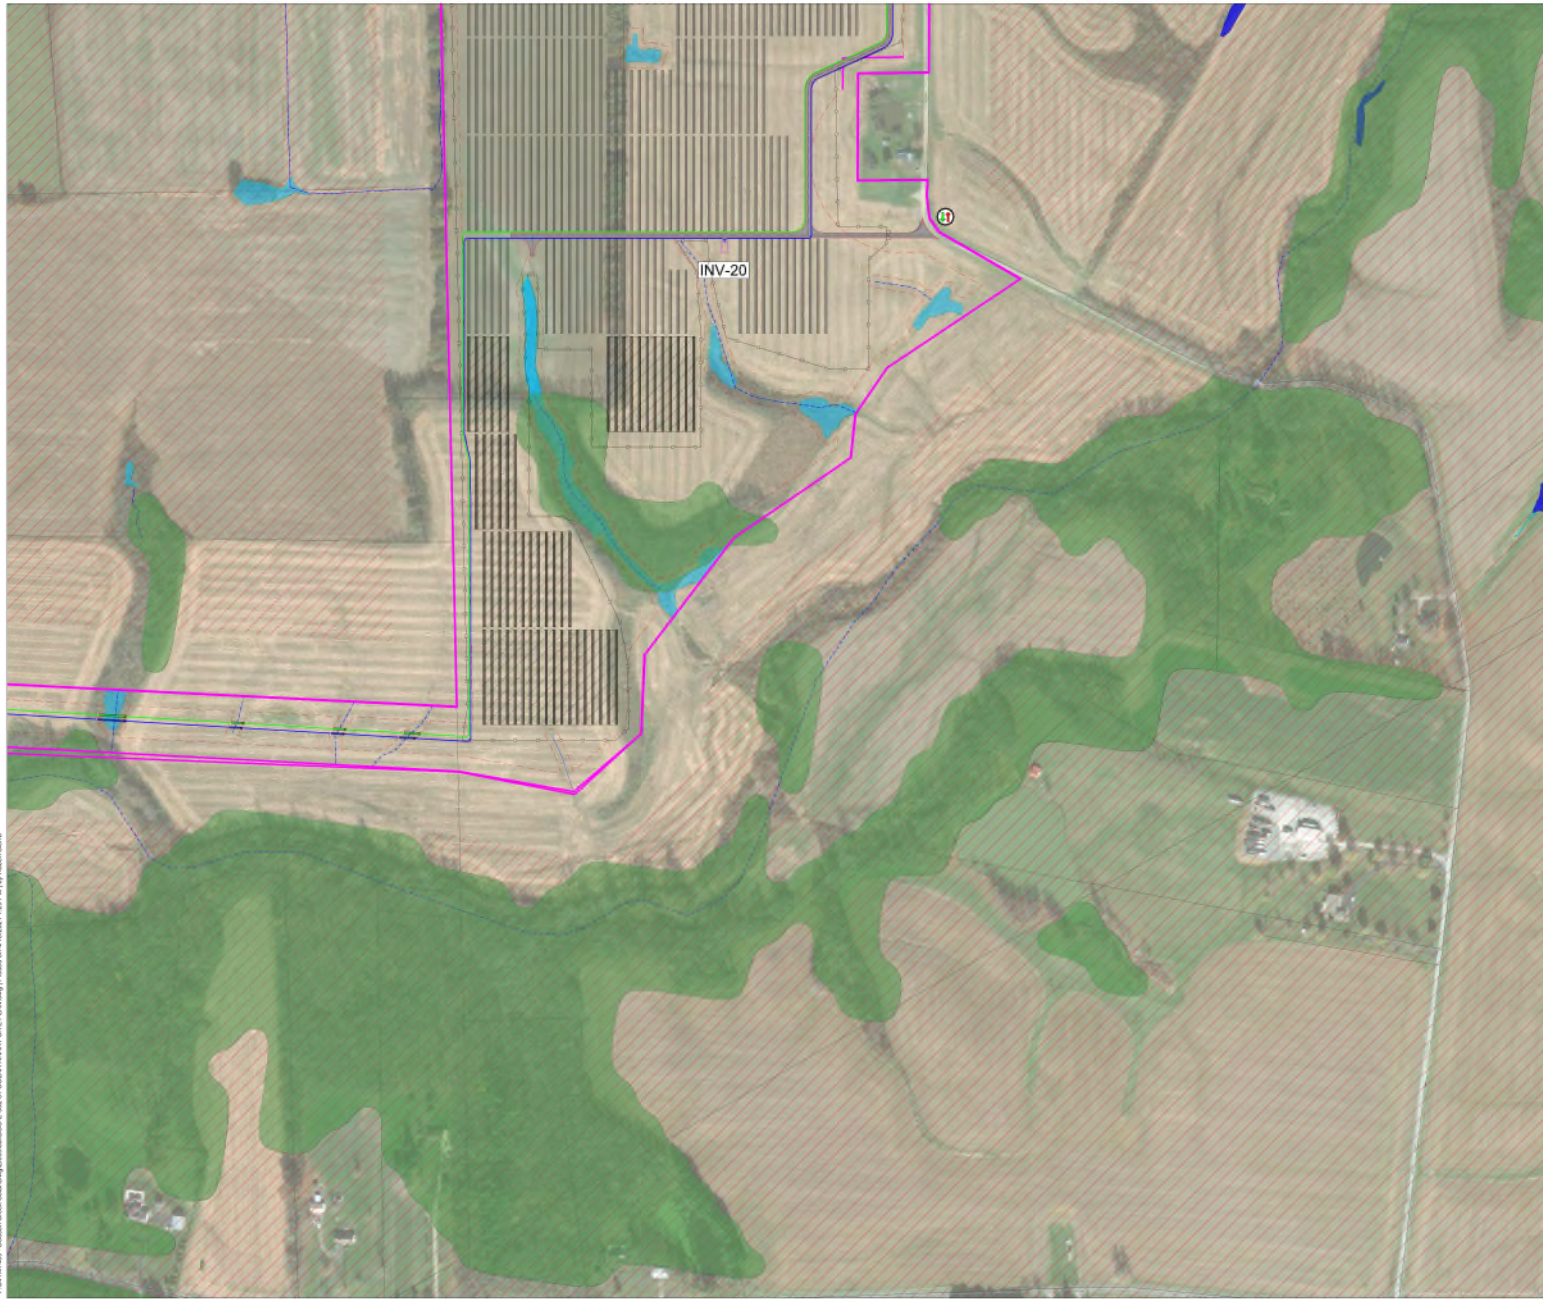

**KEYMAP:**

**NOTE:**  
A SINGLE JB IS REQUIRED AT EVERY DIRECTIONAL BORE.  
CONTRACTOR SHALL DETERMINE PLACEMENT OF JB IN  
DIRECTIONAL BORING

**SCALE 1"=200'**  
0 200' 400'

Call at least two full working days  
before you begin excavation.

**REVISIONS**

#	REVISION	DESCRIPTION
1	REVISED	REVISIONS
2	REVISED	REVISIONS
3	REVISED	REVISIONS
100	REVISED	REVISIONS

**SOLAR  
ARRAY SITE  
PLAN**

3/4"X27" FULL SIZE  
(11"X17" PLOTS ARE HALF SCALE)

SCALE SHEET NUMBER  
1" = 200' DDC-E-502-06

**TIMMONS GROUP**  
YOUR BEST CHOICE FOR THE PROJECT TEAM  
THE DODSON CREEK SOLAR PROJECT  
811 before you dig. Call 811 before you dig.  
TOL 402.283.2555 FAX 402.283.2555 www.timmons.com

**nationalgrid  
renewables**

**DODSON  
CREEK SOLAR**  
HIGHLAND COUNTY  
OHIO

DATE: 04/16/2021  
PROJECT NUMBER: 47489  
DESIGNED BY: R. SIERRA  
CHECKED BY: S. UPADHYAY  
SCALE: 1" = 200'

**PRELIMINARY  
NOT FOR CONSTRUCTION**

**REVISIONS**


#	REVISION	DESCRIPTION
1	REVISED	REVISIONS
2	REVISED	REVISIONS
3	REVISED	REVISIONS
100	REVISED	REVISIONS

**SOLAR  
ARRAY SITE  
PLAN**


3/4"X27" FULL SIZE  
(11"X17" PLOTS ARE HALF SCALE)

SCALE SHEET NUMBER  
1" = 200' DDC-E-502-06


V:\M1472189 - Dodson Creek Solar\Proj\Drawings\DDC-E-502-01 SOLAR ARRAY SITE PLAN.dwg (Plotted on 4/16/2021 1:35 PM) by: Ruler-Siemer

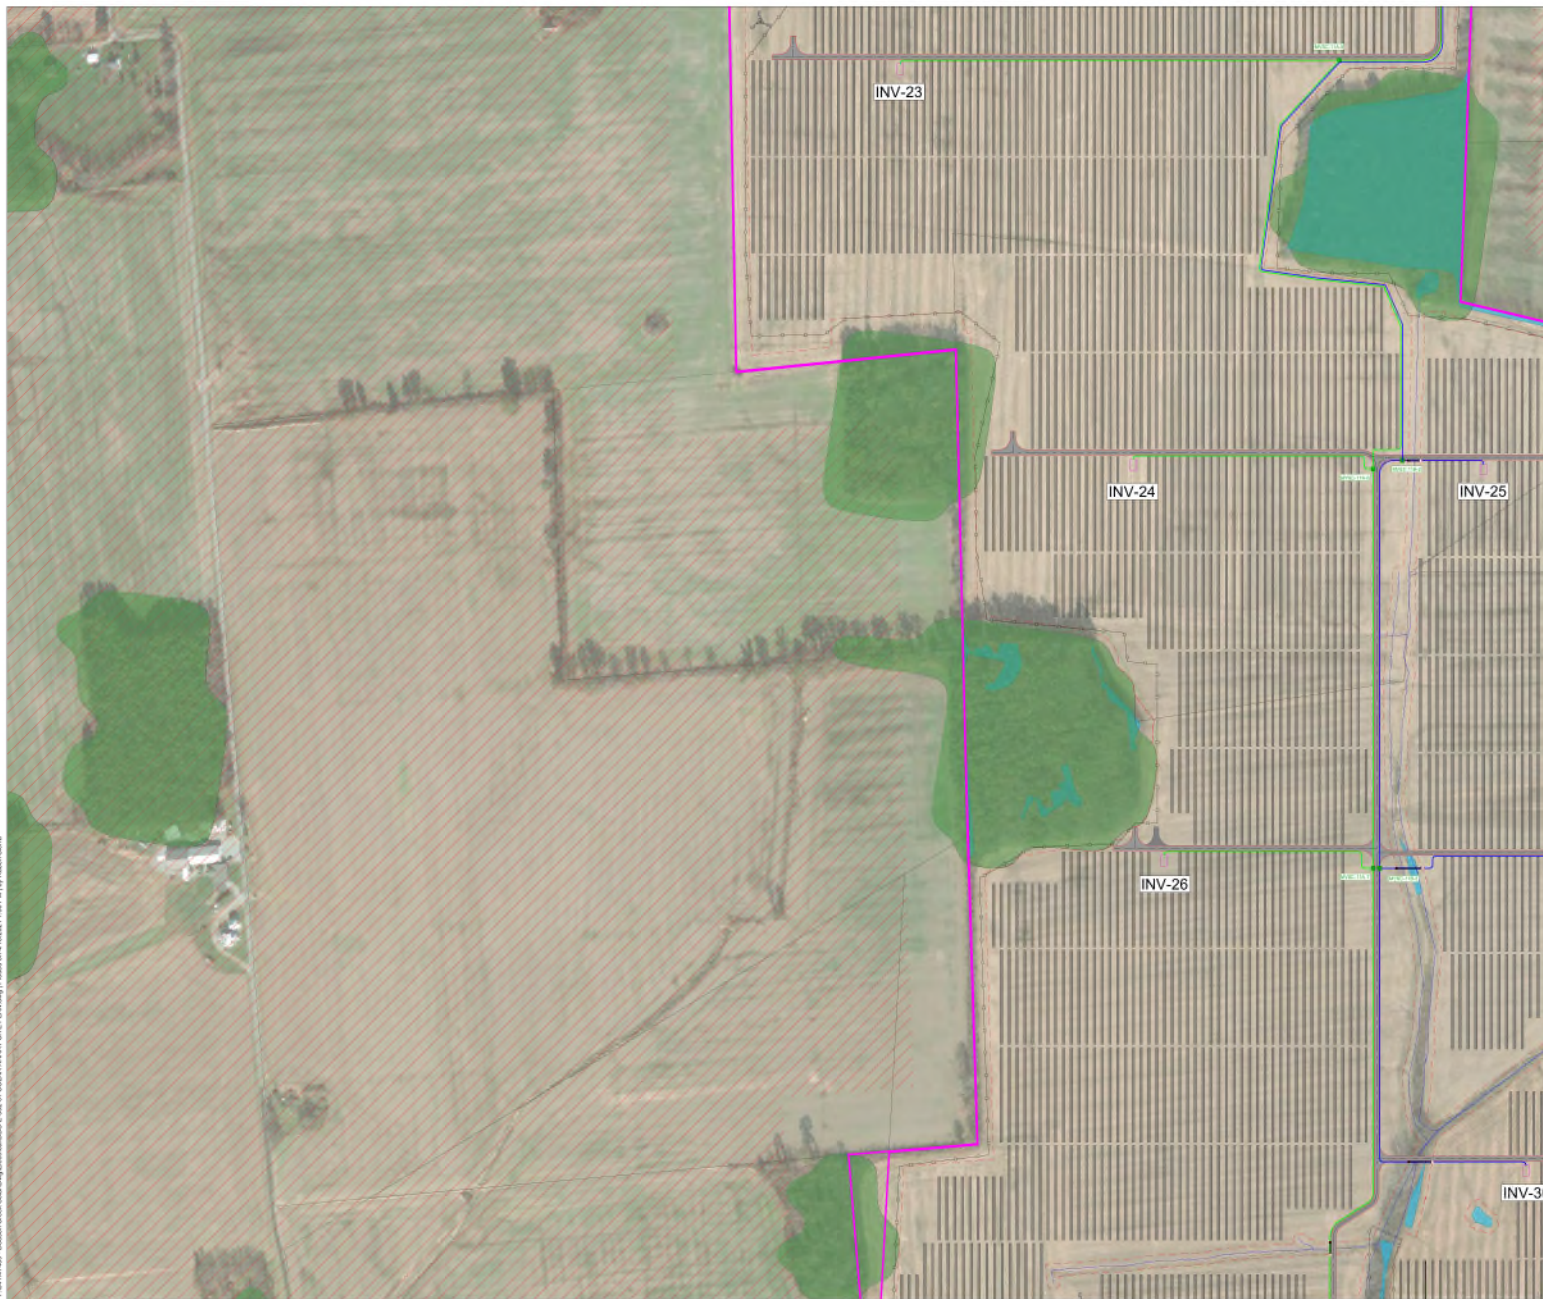

#### KEYMAP:

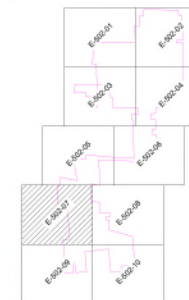

NOTE:  
A SINGLE JB IS REQUIRED AT EVERY DIRECTIONAL BORE.  
CONTRACTOR SHALL DETERMINE PLACEMENT OF JB IN  
DIRECTIONAL BORING

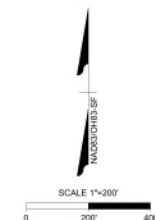

**811** Know what's below.  
Call 811 before you dig.

**TIMMONS GROUP**  
YOUR BEST CHOICE FOR THE PROJECT  
THIS DRAWING IS PART OF THE  
PERMIT APPLICATION  
311 North Street, Suite 200, AT 5204  
Tulsa, OK 74103  
TEL: 918.258.2555 FAX: 918.258.2553 www.timmons.com

**nationalgrid**  
renewables

**DODSON  
CREEK SOLAR**  
HIGHLAND COUNTY  
OHIO


DATE: 04/16/2021  
PROJECT NUMBER: 47489  
PREPARED BY: R. SIERRA  
DESIGNED BY: S. UPADHYAY  
SCALE:

**PRELIMINARY  
NOT FOR CONSTRUCTION**

REVISIONS	
#	DESCRIPTION
1	ISSUED FOR PERMIT REVIEW
2	ISSUED FOR PERMIT REVIEW
3	ISSUED FOR PERMIT REVIEW
4	ISSUED FOR PERMIT REVIEW
5	ISSUED FOR PERMIT REVIEW
6	ISSUED FOR PERMIT REVIEW
7	ISSUED FOR PERMIT REVIEW
8	ISSUED FOR PERMIT REVIEW
9	ISSUED FOR PERMIT REVIEW
10	ISSUED FOR PERMIT REVIEW

DRAWING DESCRIPTION:  
**SOLAR  
ARRAY SITE  
PLAN**

3/4" x 27" FULL SIZE  
(1/4" x 11" PLOTS ARE HALF SCALE)  
SCALE: 1" = 200'  
SHEET NUMBER: DDC-E-502-07

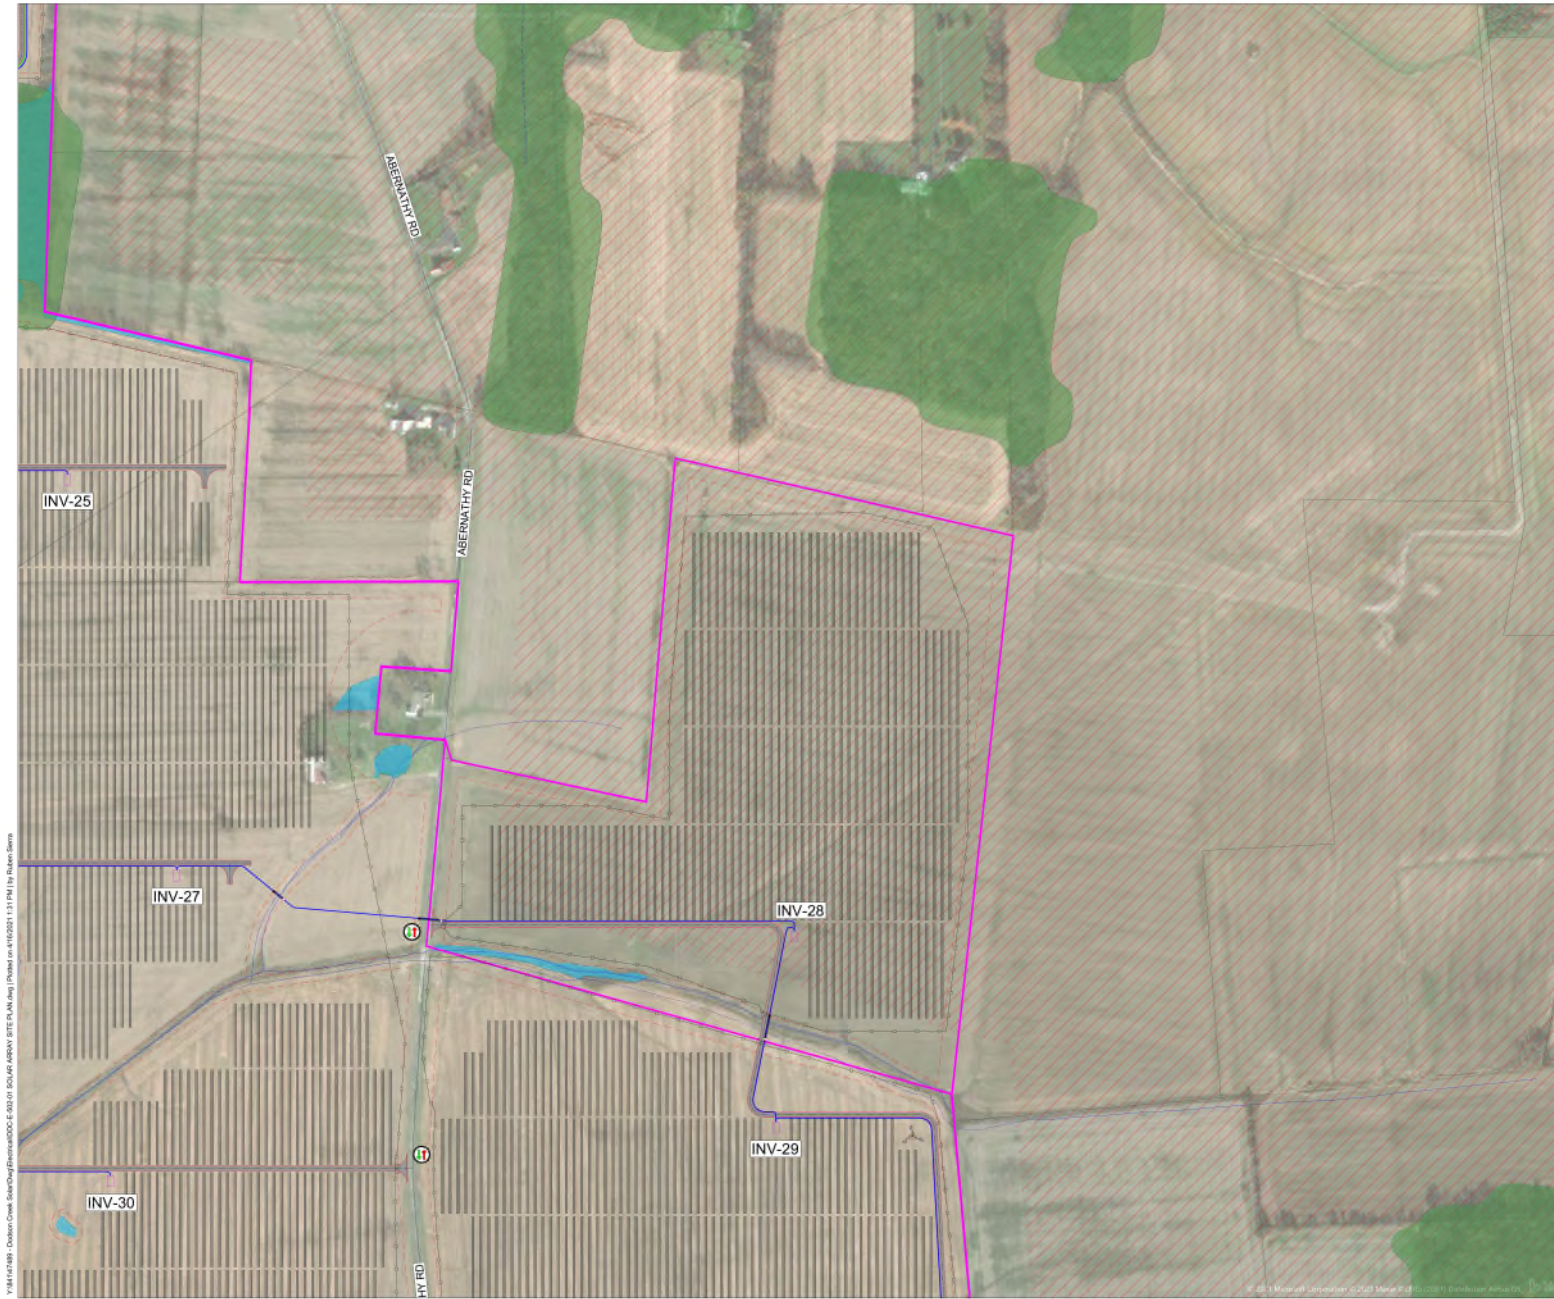

**KEYMAP:**

**NOTE:**  
A SINGLE JB IS REQUIRED AT EVERY DIRECTIONAL BORE. CONTRACTOR SHALL DETERMINE PLACEMENT OF JB IN DIRECTIONAL BORING.

**nationalgrid**  
renewables

**DODSON CREEK SOLAR**  
HIGHLAND COUNTY, OHIO

DATE: 04/16/2021  
PROJECT NUMBER: 47469  
INTEGRITY: R. SIERRA  
DESIGNED BY: S. UPADHYAY  
SCALE:

**PRELIMINARY**  
NOT FOR CONSTRUCTION

#	REVISION	DESCRIPTION
1	REVISED	REDESIGN WORK
2	REVISED	DESIGN
3	REVISED	FOR SCHEMATIC
4	REVISED	FOR SCHEMATIC
5	REVISED	FOR SCHEMATIC


DRAWING DESCRIPTION:

**SOLAR ARRAY SITE PLAN**

3/4" X 27" FULL SIZE  
(OTHER PLOTS ARE HALF SCALE)

SCALE	SHEET NUMBER
1" = 200'	DDC-E-502-08

Y:\MKT2089 - Dodson Creek Solar\Proj\Drawings\DDC-E-502-08 SOLAR ARRAY SITE PLAN.dwg (Plotted on 4/16/2021 1:11 PM) by: R. Sierra

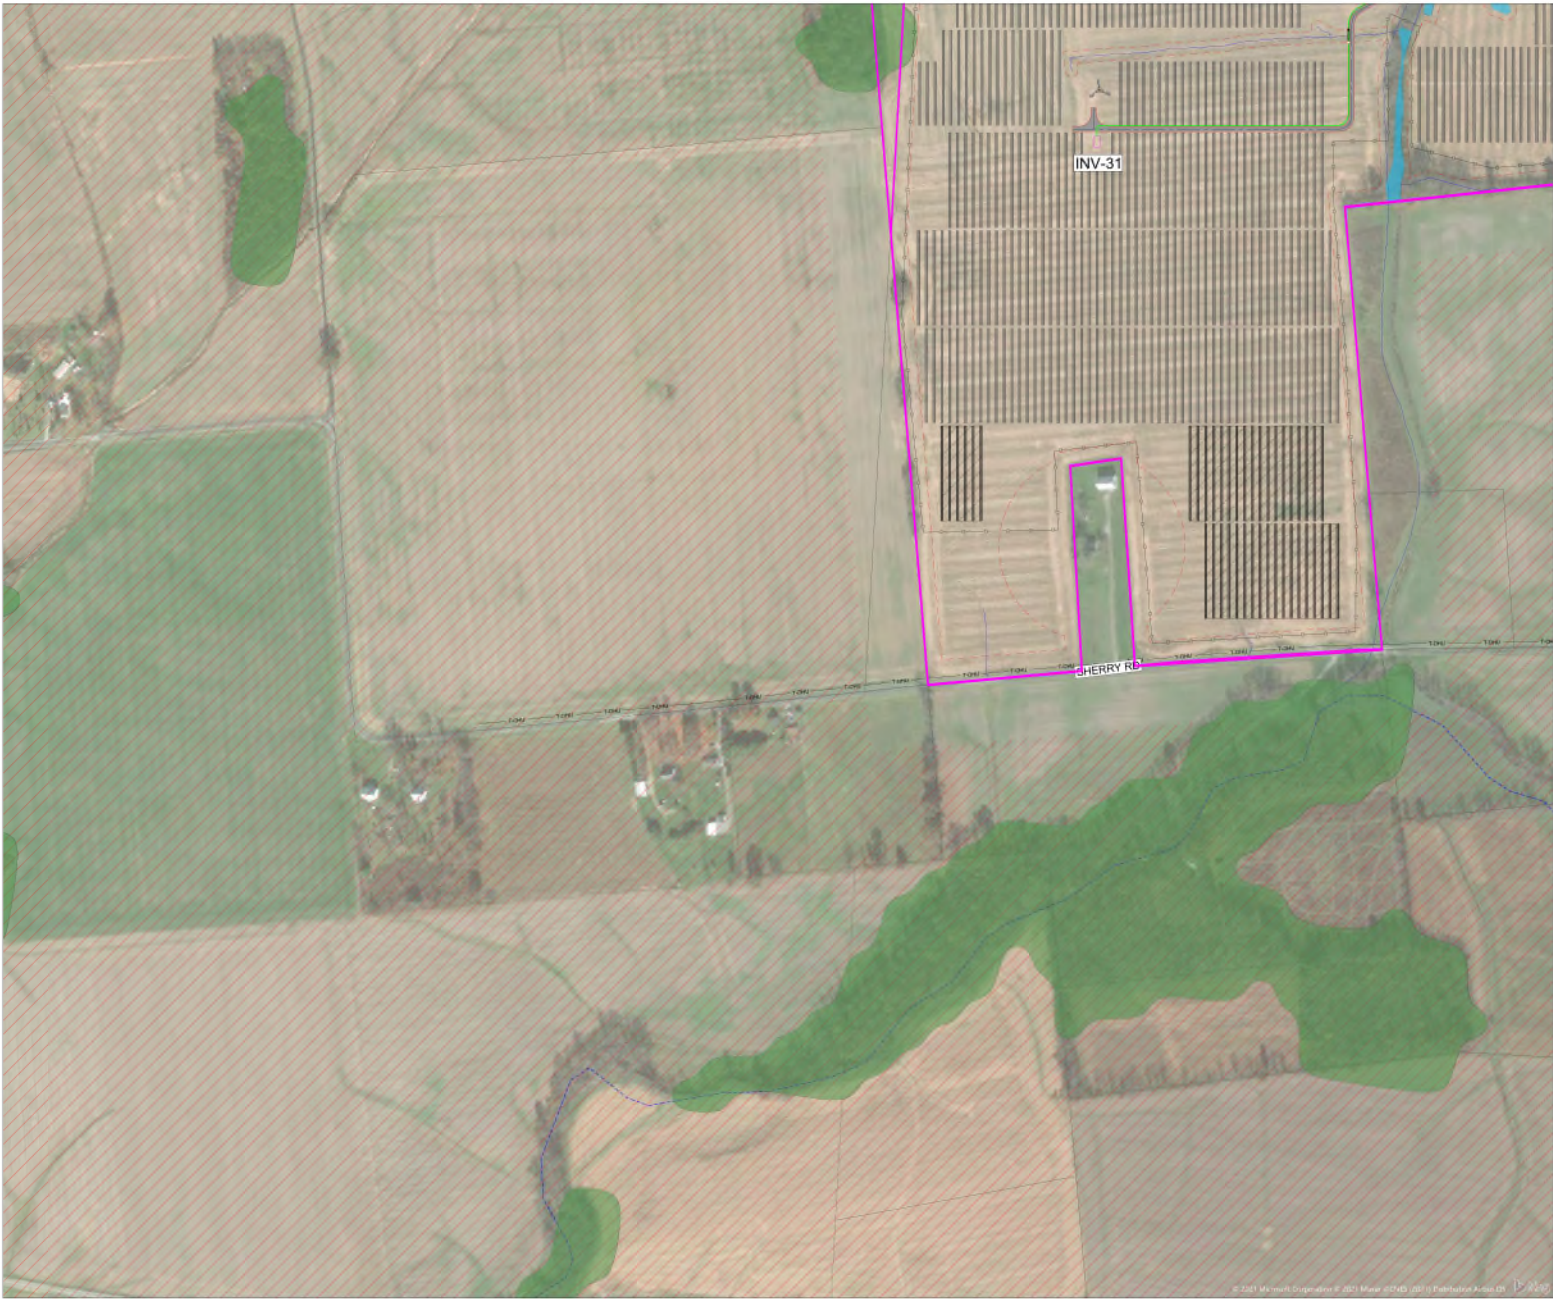

**KEYMAP:**



NOTE:  
A SINGLE JB IS REQUIRED AT EVERY DIRECTIONAL BORE.  
CONTRACTOR SHALL DETERMINE PLACEMENT OF JB IN  
DIRECTIONAL BORING



**TIMMONS GROUP**  
YOUR BEST CHOICE FOR THE PROJECT TEAM

THE DODSON CREEK SOLAR ARRAY  
HIGHLAND COUNTY, OHIO

311 Main Street, Suite 200, Dayton, OH 45404  
TEL: 937.233.2333 FAX: 937.233.2334 www.timmons.com

**nationalgrid**  
renewables

**DODSON CREEK SOLAR**  
HIGHLAND COUNTY, OHIO

DATE: 04/16/2021  
PROJECT NUMBER: 47459  
PREPARED BY: R. SIERRA  
DESIGNED BY: S. UPADHYAY  
SCALE:

**PRELIMINARY**  
NOT FOR CONSTRUCTION

#	REVISION	DESCRIPTION
1	REVISED	REVISIONS
2	REVISED	REVISIONS
3	REVISED	REVISIONS
4	REVISED	REVISIONS
5	REVISED	REVISIONS
6	REVISED	REVISIONS
7	REVISED	REVISIONS
8	REVISED	REVISIONS
9	REVISED	REVISIONS
10	REVISED	REVISIONS
11	REVISED	REVISIONS
12	REVISED	REVISIONS


**SOLAR ARRAY SITE PLAN**

3/4" = 1" FULL SIZE  
(1/4" = 1" PLOTS ARE HALF SCALE)


SCALE	DATE
1" = 200'	DDC-E-502-09

Y:\MKTG\2019 Dodson Creek Solar Array\DDC-E-502-09 SOLAR ARRAY SITE PLAN.dwg (Plotted on 4/16/2021 1:11 PM) by: R. Sierra



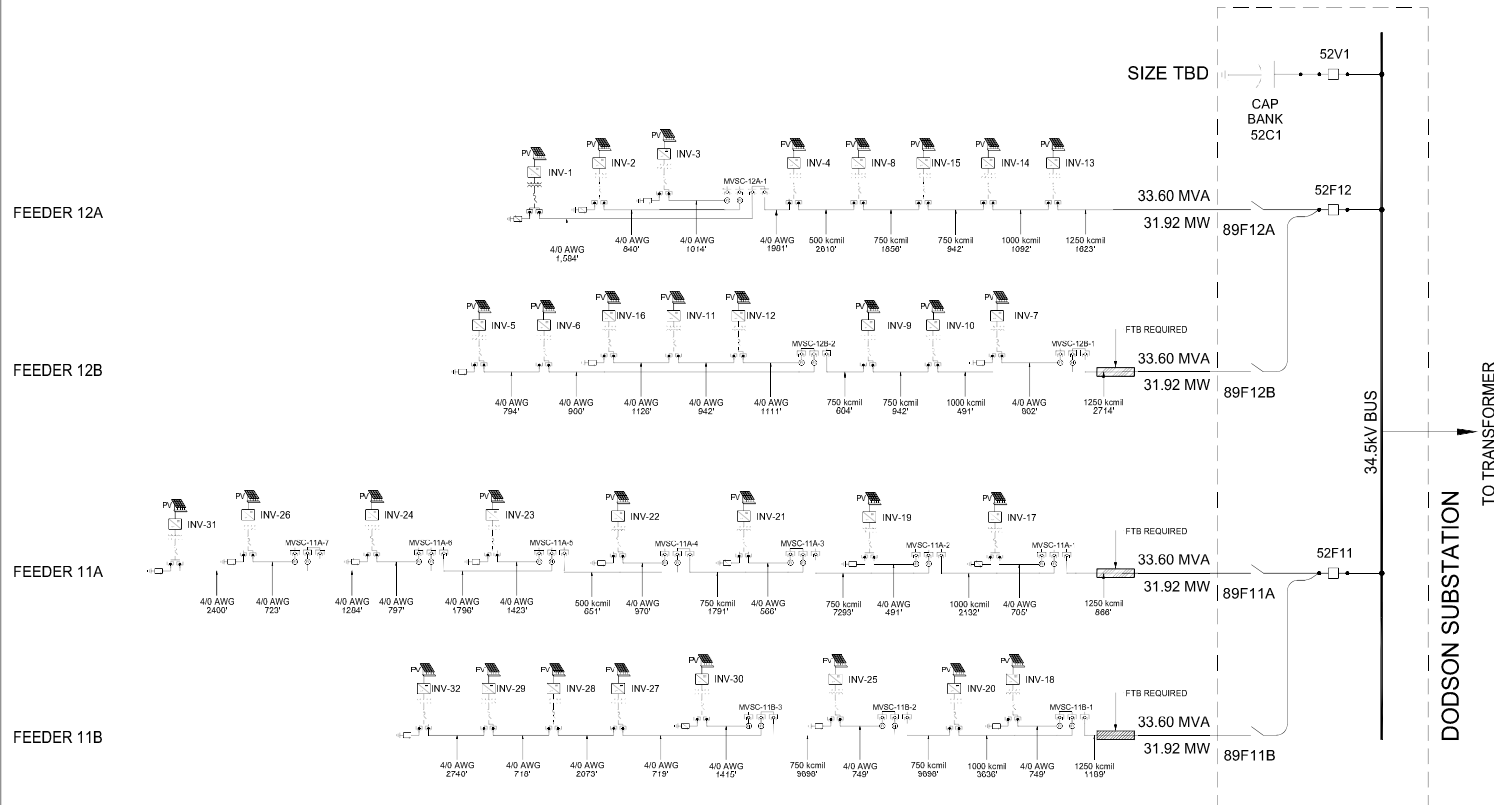


34"x22" FULL SIZE (17"x11" DOTS ARE HALF SCALE)	
SCALE	SHEET NUMBER
N.T.S.	DDC-E-501-01

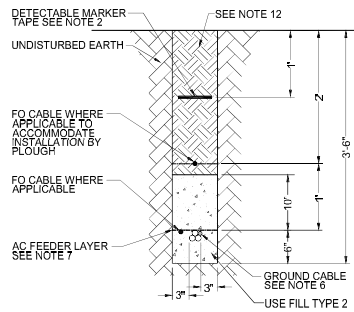


**UGT01 - SINGLE POWER CABLE TRENCH**

SCALE: NTS  
MVAC (3-1/C TRIPLEX) / G4 / FO  
(TYPICAL)

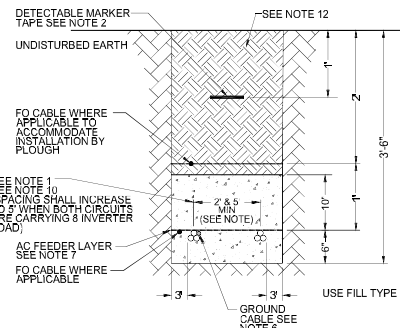


**UGT02 - TWO POWER CABLE TRENCH**

SCALE: NTS  
MVAC (3-1/C TRIPLEX) / G4 / FO  
(IN & OUT OF PCS)

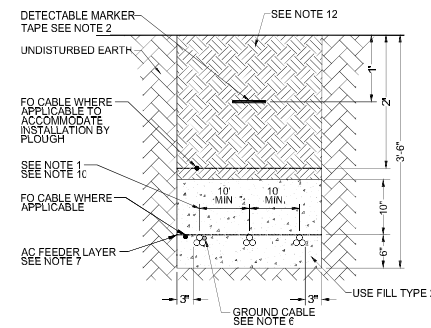


**UGT03 - 3 POWER CABLE TRENCH**

SCALE: NTS  
MVAC (3-1/C TRIPLEX) / G4 / FO  
(COLLECTION SYSTEM)

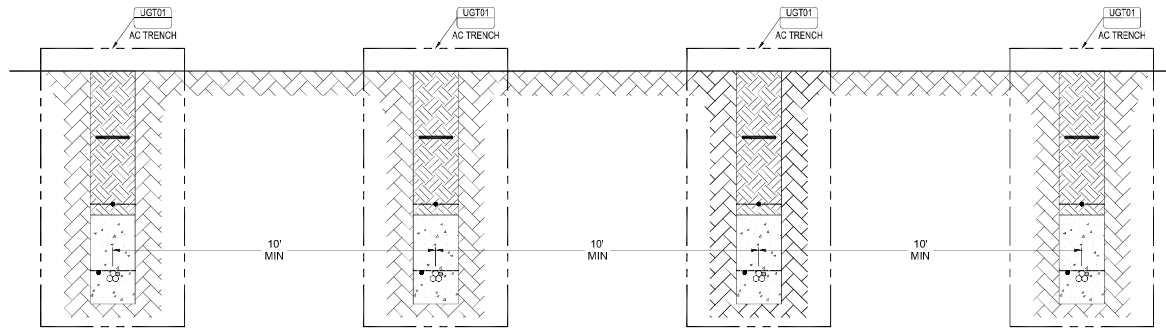

**UGT04 - AC TO AC TRENCH FOR 4 CIRCUITS**

SCALE: NTS  
MVAC (3-1/C TRIPLEX) / G4 / FO  
(TYPICAL)

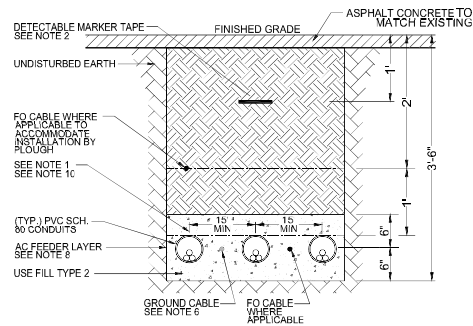

**SITE ROAD CROSSING**

SCALE: NTS  
MVAC (3-1/C) / G4 / FO

**NOTES:**

- THIS DRAWING IS DIAGRAMMATIC AND INTENDED TO SHOW THE TYPICAL LEVELS AND MINIMUM SPACING BETWEEN CABLES WITHIN THE TRENCH. THE EXACT TYPE OF NUMBER OF CABLES MAY VARY FROM WHAT IS SHOWN. NARROW OR WIDE TRENCHES ARE TO BE DETERMINED WHERE CABLES ARE APPLICABLE ON THE SITE. REFERENCE ALL AC, GROUNDING, FIBER OPTIC AND ALL OTHER CABLES TO THE PLAN.
- INSTALL 6" WIDE RED DETECTABLE MARKER TAPE IN ALL TRENCHES.
- TRENCHING AND CABLE INSTALLATION MUST BE COORDINATED TO AVOID ALL OBSTRUCTIONS. REFERENCE STRUCTURAL AND CIVIL DRAWINGS FOR EQUIPMENT LOCATION COORDINATES, GRADING, AND UNDERGROUND OBSTRUCTIONS.
- DIMENSIONS TO CABLE LAYERS ARE FROM FINISHED GRADE TO THE CENTER OF CABLES, EXCEPT WHERE NOTED.
- MISCELLANEOUS CABLES INCLUDING FIBER OPTIC, INSTRUMENTATION AND LOW VOLTAGE MAY UTILIZE THE TRENCH SECTIONS. FIBER OPTIC CABLES MAY BE INSTALLED IN TRENCHES SHOWN ON UNDERGROUND TRENCHING PLAN OR SEPARATELY VIA CABLE FLOW METHOD.
- ALL BARE CU, GROUND WIRE SHALL BE DIRECT BURIED TO A MINIMUM DEPTH OF 36" EXCEPT UNDER ROAD. GROUNDING WIRE SHALL BE BURIED AT 36".
- FOR MVAC CONDUCTOR SIZING SEE DRAWING E-S22-01. WHEN MVAC CROSSING FEEDERS, LOWER MVAC CABLES 12" BELOW DC LAYER.
- SOIL COMPACTION REQUIREMENTS: 85% COMPACTION AND 95% COMPACTION AT ROAD CROSSINGS. FILL HIT SHALL NOT EXCEED 10" MAX. LOOSE THICKNESS PER PROJECT GEOTECHNICAL REPORT.
- CLEAN FILL REQUIREMENTS:  
TRENCHING:  
9A. TYPE 1: NATIVE SOIL SHALL BE USED FOR BACKFILL AS SHOWN IN SECTIONS.  
9B. TYPE 2: FILL SHALL BE CLEAN MATERIAL CONTAINING PARTICLES NO LARGER THAN 3/8" IN DIAMETER IN THE AREA 6" ABOVE AND BELOW.  
9C. TYPE 3: FILL SHALL BE CLEAN MATERIAL CONTAINING PARTICLES NO LARGER THAN 3" IN DIAMETER.  
PLOWING:  
PLOWING IN OF FO CABLE IN SOIL CONTAINING ROCK OR OTHER SOLID MATERIAL SHALL BE DONE IN SUCH A MANNER THAT THE SOLID MATERIAL WILL NOT DAMAGE THE CABLE. EITHER DURING THE PLOWING OPERATION OR AFTERWARD. THE DESIGN OF THE PLOWING EQUIPMENT AND THE PLOWING IN OPERATION SHOULD BE SUCH THAT THE CABLE WILL NOT BE DAMAGED BY BENDING, SIDE WALL PRESSURE, OR EXCESSIVE CABLE TENSION.
- NOTE THAT SEPARATION BETWEEN CABLES MAY CHANGE ONCE ACTUAL RHO VALUE IS RECEIVED.
- TREFOIL CABLE SHALL BE ZIPTIED AT INTERVALS NO LESS THAN 3 FT.
- WHEN APPLICABLE, FOR EXAMPLE, TRENCH IS RUN ACROSS FARMLAND, OR ON SIDE OF SOLAR PLANT BOUNDARY, THE FIRST 10' TOPSOIL SHALL BE WINDROWED BEFORE TRENCHING BEGINS. THE TOPSOIL SHALL BE RETURNED TO THE ORIGINAL CONDITION AFTER TRENCHING. THE WINDROWED MATERIAL SHALL NOT BE MIXED WITH AN OTHER MATERIAL. THE NATIVE BACKFILL FOR THIS PORTION OF THE TRENCH SHALL BE NO GREATER THAN 1" SCREENED MATERIAL. PROVIDE ADDITIONAL BACKFILL MATERIAL TO ALLOW FOR SETTLING OF THE DISTURBED SOIL. MAINTAIN A MINIMUM 10' TO TOP OF FINISHED GRADE FROM TOP OF CABLE.

**LEGEND:**

	FILL TYPE 1 (NATIVE SOIL) SEE NOTE 9A
	FILL TYPE 2 (CLEAN FILL) SEE NOTE 9B
	FILL TYPE 3 (CLEAN FILL) SEE NOTE 9C


G1	1/0 AWG BARE COPPER CABLE
G4	4/0 AWG BARE COPPER CABLE

**SITE UNDERGROUND TRENCH  
DESIGN BASIS**

THERMAL RESISTIVITY: (RHO) = 200  
EARTH TEMPERATURE = 25.0° C


\*SEE NOTE 10

\\NAVP001 - Dodson Creek Solar Detail\Drawings\DDC-E-S22-01 COLLECTION SYSTEM CABLE CROSSING DETAIL.dwg Plot Date: 02/20/2021 10:40 AM By: Nathan Sierra

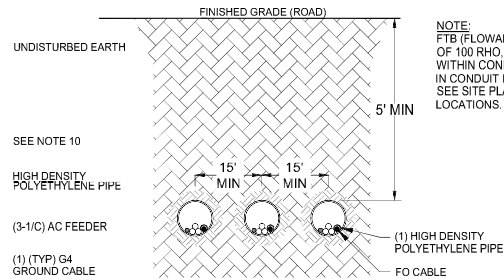


### UGT06 - DIRECTIONAL BORING SECTION

SCALE: NTS  
MVAC (3-1/C) / G4 / FO

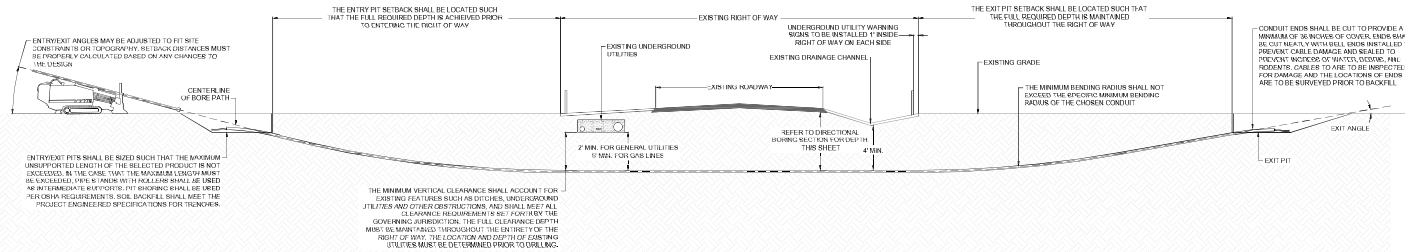

### UNDERGROUND UTILITY HORIZONTAL DIRECTIONAL DRILL ROAD CROSSING

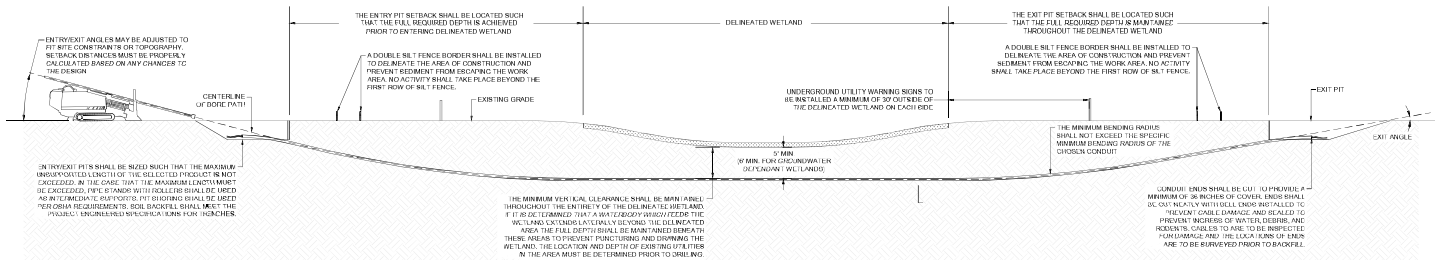

### UNDERGROUND UTILITY HORIZONTAL DIRECTIONAL DRILL WETLAND CROSSING

#### NOTES:

- THIS DRAWING IS DIAGRAMMATIC AND INTENDED TO SHOW THE TYPICAL LEVELS AND MINIMUM SPACING BETWEEN CABLES WITHIN THE TRENCH. THE EXACT TYPE OR NUMBER OF CABLES MAY VARY FROM WHAT IS SHOWN, NARROW OR WIDE TRENCH AS NEEDED, TO DETERMINE WHERE CABLES ARE APPLICABLE ON THE SITE. REFERENCE ALL AC GROUNDING, FIBER OPTIC AND ALL OTHER CABLEING PLANS.
- INSTALL 6" WIDE RED DETECTABLE MARKER TAPE IN ALL TRENCHES.
- TRENCHING AND CABLE INSTALLATION MUST BE COORDINATED TO AVOID ALL OBSTRUCTIONS, GRADING, AND UNDERGROUND OBSTRUCTIONS. FOR EQUIPMENT LOCATION COORDINATES, GRADING, AND UNDERGROUND OBSTRUCTIONS.
- DIMENSIONS TO CABLE LAYERS ARE FROM FINISHED GRADE TO THE CENTER OF CABLES, EXCEPT WHERE NOTED.
- MISCELLANEOUS CABLES INCLUDING FIBER OPTIC, INSTRUMENTATION AND LOW VOLTAGE MAY UTILIZE THE TRENCH SECTIONS. FIBER OPTIC CABLES MAY BE INSTALLED IN TRENCHES SHOWN ON UNDERGROUND TRENCHING PLAN OR SEPARATELY VIA CABLE PLOW METHOD.
- ALL BARE CU GROUND WIRE SHALL BE DIRECT BURIED TO A MINIMUM DEPTH OF 30".
- FOR MVAC CONDUCTOR SIZING SEE DRAWING E-501-01.
- SOIL COMPACTION REQUIREMENTS: 85% COMPACTION AND 95% COMPACTION AT ROAD CROSSINGS. REFERENCE GEOTECHNICAL REPORT LIFT SEPARATIONS.
- CLEAN FILL REQUIREMENTS:  
TRENCHING:  
9A. TYPE 1: NATIVE SOIL SHALL BE USED FOR BACKFILL WITH INTERLOCK ARMOR CABLES OR AS SHOWN IN SECTIONS.  
9B. TYPE 2: FILL SHALL BE CLEAN MATERIAL CONTAINING PARTICLES NO LARGER THAN 3/8" IN DIAMETER IN THE AREA 6" ABOVE AND BELOW.  
9C. TYPE 3: FILL SHALL BE CLEAN MATERIAL CONTAINING PARTICLES NO LARGER THAN 3" IN DIAMETER.  
FLOWING:  
FLOWING-IN OF FO CABLE IN SOIL CONTAINING ROCK OR OTHER SOLID MATERIAL SHALL BE DONE IN SUCH A MANNER THAT THE SOLID MATERIAL WILL NOT DAMAGE THE CABLE. EITHER DURING THE FLOWING OPERATION OR AFTERWARD. THE DESIGN OF CABLE-FLOWING EQUIPMENT AND THE FLOWING-IN OPERATION SHOULD BE SUCH THAT THE CABLE WILL NOT BE DAMAGED BY BENDING, SIDE-WALL PRESSURE, OR EXCESSIVE CABLE TENSION.
- NOTE THAT SEPARATION BETWEEN CABLES MAY CHANGE ONCE ACTUAL RHO VALUE IS RECEIVED.
- SEE TABLE 1 FOR INDICATED BORE SIZE TO CABLE SIZE.
- TREF OIL CABLE SHALL BE ZIP TIED AT INTERVALS NO LESS THAN 3 FT.

#### LEGEND:

	FILL TYPE 1 (NATIVE SOIL) SEE NOTE 9A
	FILL TYPE 2 (CLEAN FILL) SEE NOTE 9B
	FILL TYPE 3 (CLEAN FILL) SEE NOTE 9C
	G1 10 AWG BARE COPPER CABLE
	G4 40 AWG BARE COPPER CABLE

TABLE 1 HORIZONTAL DIRECTIONAL BORE REQUIREMENTS <sup>1)</sup>		
35KV CABLE SIZE	HOPE BOR 13.5 BORE CONDUIT SIZE	HOPE FIBER OPTIC INNERDUCT SIZE: 50R
(3) 10 AWG	MIN. 6"	2.9"
(3) 30 AWG	MIN. 6"	1.39"
(3) 40 AWG	MIN. 6"	1.25"
(3) 350 KCMIL	MIN. 6"	1.25"
(3) 500 KCMIL	MIN. 8"	1.25"
(3) 750 KCMIL	MIN. 8"	1.25"
(3) 1000 KCMIL	MIN. 8"	1.25"
(3) 1250 KCMIL	MIN. 8"	1.25"

#### SITE UNDERGROUND TRENCH DESIGN BASIS

THERMAL RESISTIVITY: (RHO) = 200  
EARTH TEMPERATURE = 25.0° C

\*SEE NOTE 10

**TIMMONS GROUP**  
YOUR VISION ACHIEVED THROUGH OURS.  
THIS CHARTER IS OWNED BY THE CLIENT OFFICE  
9711 North Glenhurst Avenue, Suite 200, AZ 85734  
TEL: 480.388.8888 FAX: 480.355.1018 www.timmons.com

**nationalgrid**  
renewables

PROJECT NAME & ADDRESS

**DODSON CREEK SOLAR**  
HIGHLAND COUNTY  
OHIO

DATE: 04/02/2021  
PROJECT NUMBER: 47489  
DRAWN BY: R. SIERRA  
CHECKED BY: C. HARRIS

SCALE:

**PRELIMINARY**  
NOT FOR CONSTRUCTION

REVISIONS	
1	REVISIONS
2	REVISIONS
3	REVISIONS
4	REVISIONS
5	REVISIONS
6	REVISIONS
7	REVISIONS
8	REVISIONS
9	REVISIONS
10	REVISIONS

FORWARD DESCRIPTION





**COLLECTION SYSTEM CABLE CROSSING DETAIL**

3/4"X2" FULL SIZE


1/4"X1/2" FULL SIZE AND SMALLER

SCALE: SHEET NUMBER:

N.T.S. DDC-E-S22-02

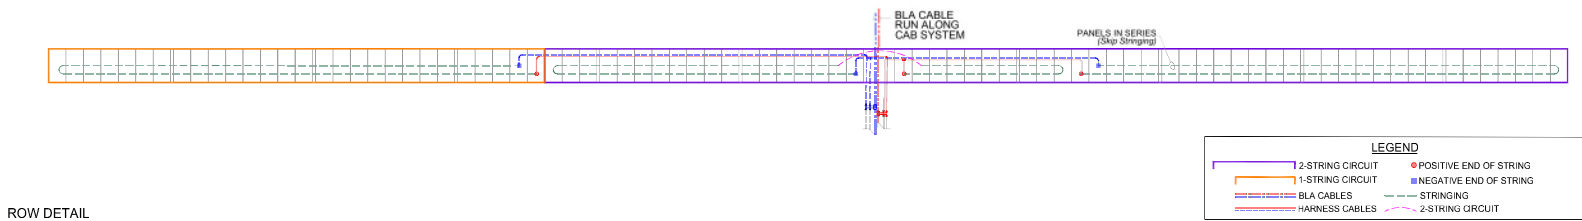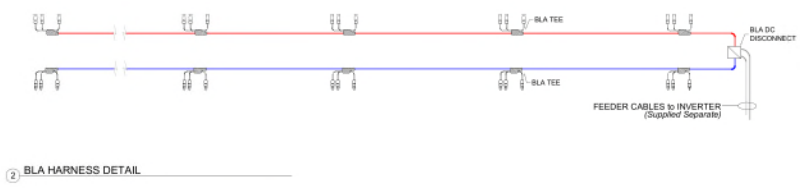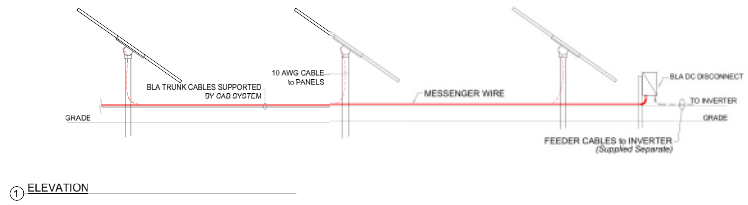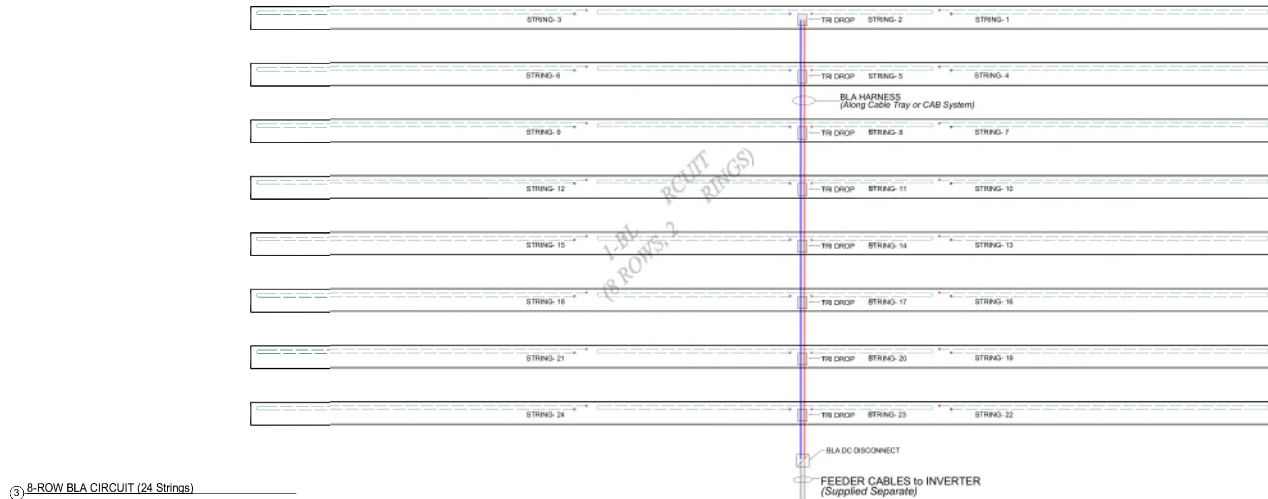

1. CURRENT INPUT OF RELAY WIRED FOR REVERSE POLARITY.  
ITIL RELAY PROVIDES BACKUP BUS PROTECTION.
2. 11V2 RELAY WILL TRIP SWITCHER 89C2 ONE SECOND AFTER  
BREAKER 52V2 IS OPENED

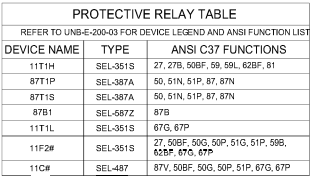

DATE 04/05/2021  
PROJECT NUMBER 47489  
DRAWN BY R. TANDEL  
DESIGNED BY S. UPADHYAY

#### DRAWING DESCRIPTION

SCALE	SHEET NUMBER
N.T.S.	DDC-E-200-01

# DEVICE LEGEND



DEVICE FUNCTION NUMBER LIST (ANSI C37.2)			
NO.	FUNCTION AND DEFINITION	NO.	FUNCTION AND DEFINITION
11	MULTIFUNCTION	59L	HOT LINE (SYNCH. CHECK)
21	DISTANCE	59B	HOT BUS (SYNCH. CHECK)
21G	GROUND DISTANCE	62	TIMING RELAY
24	VOLTS PER HERTZ	63	TRANSFORMER PRESSURE RELAY
25	SYNCH. CHECK (HOT LINE/DEAD BUS)	64	GROUND FAULT
26G	OIL TEMPERATURE THERMOMETER	67P	AC DIRECTIONAL OVERCURRENT
27	UNDERVOLTAGE	67G	GROUND DIRECTIONAL OVERCURRENT
27B	DEAD BUS (SYNCH. CHECK)	71Q	OIL LEVEL INDICATOR DEVICE
46	REVERSE PHASE LOCK-OUT	81	FREQUENCY
49T	TRANSFORMER THERMAL RELAY	86B	BUS LOCK-OUT RELAY
50	INSTANTANEOUS OVERCURRENT	86BF	BREAKER FAILURE LOCK-OUT RELAY
50G	GROUND INSTANTANEOUS OVERCURRENT	86T	TRANSFORMER LOCK-OUT RELAY
50BF	BREAKER FAILURE	87	DIFFERENTIAL
51	AC TIME OVERCURRENT	87L	LINE DIFFERENTIAL
51P	PHASE AC TIME OVERCURRENT	87B	BUS DIFFERENTIAL
51G	GROUND AC TIME OVERCURRENT	87T	TRANSFORMER DIFFERENTIAL
51N	NEUTRAL TIME OVERCURRENT	87N	RESTRICTED EARTH FAULT
52	AC CIRCUIT BREAKER	87V	ZERO SEQ. VOLTAGE DIFFERENTIAL
59	OVERVOLTAGE	89	LINE DISCONNECT SWITCH
59N	NEUTRAL VOLTAGE DISPLACEMENT	90	REGULATING DEVICE



DATE	04/05/2021
PROJECT NUMBER	47489
DESIGNED BY	R. TANDEL
DESIGNED BY	S. UPADHYAY




REVISIONS	
#	DESCRIPTION
1	REVISION 1
2	REVISION 2
3	REVISION 3
4	REVISION 4
5	REVISION 5

SUBSTATION DEVICE LEGEND	
34"x22" FULL SIZE (1/31" DUTY AND 1/32" SCALE)	
SCALE	INCHES
N.T.S.	DDC-E-200-02



Y:\MVA\000 - Dodson Creek Solar\Out\Drawings\DDC-E-211-01 - SUBSTATION EQUIPMENT GENERAL ARRANGEMENT.dwg (Reviewed 4/20/21 12:51 PM) by Robert Sierra

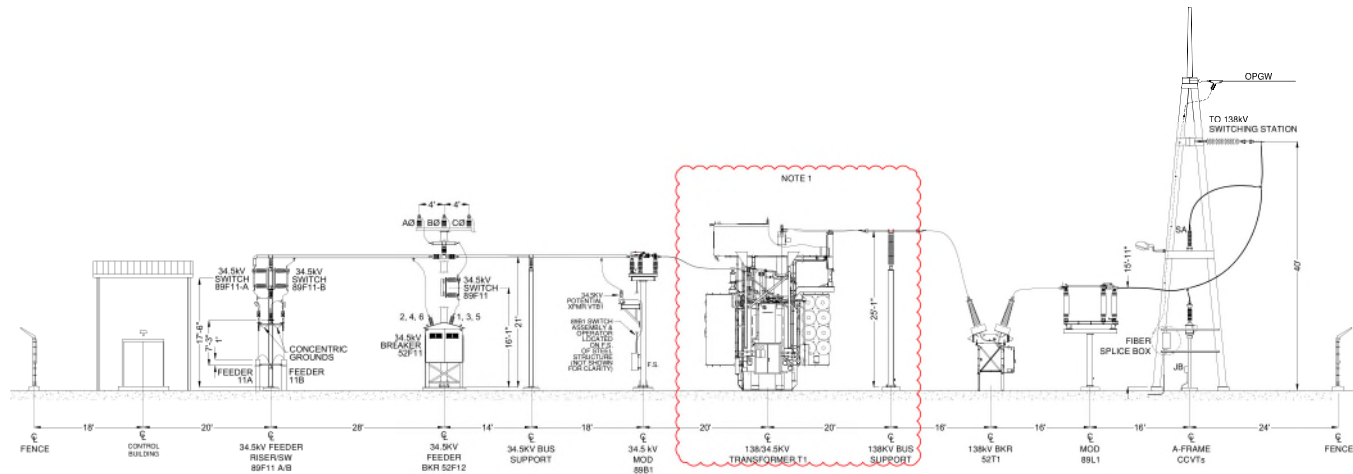

SECTION A-A


SCALE 1"=10'  
0 10' 20'

NOTES


1. THE DIMENSIONS/DRAWING OF TRANSFORMER IS NOT AVAILABLE. TRANSFORMER FOOTPRINT, BUS SUPPORT HEIGHT AND CONFIGURATION WILL CHANGES PER THE TRANSFORMER DIMENSION.

REVISIONS	
#	DESCRIPTION
1	ISSUED FOR REVIEW
2	ISSUED FOR REVIEW
3	ISSUED FOR REVIEW
4	ISSUED FOR REVIEW
5	ISSUED FOR REVIEW
6	ISSUED FOR REVIEW

\\NAVAIR\BID - Dodson Creek Solar\Drawings\Substation Equipment\SECTION B-B.dwg (Revision 4/20/21 12:51 PM) by: R. Sierra

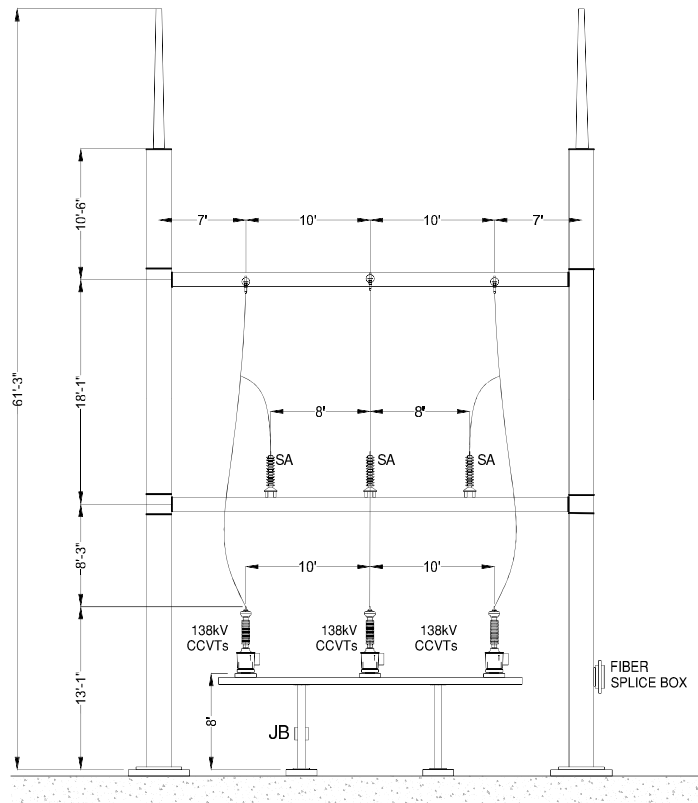

SECTION B-B

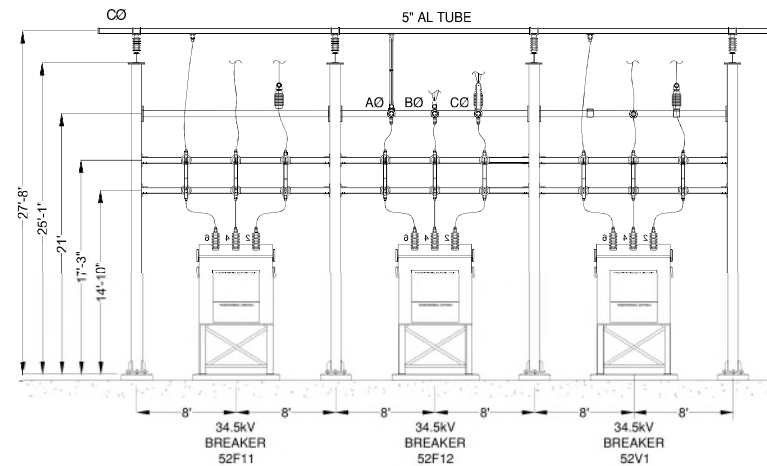

SECTION C-C

SCALE 1"=5'

PROJECT NAME & ADDRESS

**DODSON  
CREEK SOLAR**  
HIGHLAND COUNTY  
OHIO

DATE: 04/05/2021  
PROJECT NUMBER: 4748E  
DRAWN BY: R. SIERRA  
DESIGNED BY: S. UPADHYAY

SCALE:

**PRELIMINARY  
NOT FOR CONSTRUCTION**

REVISIONS	
NO.	DESCRIPTION
1	ISSUED FOR REVIEW
2	REVISED FOR APPROVAL
3	REVISED FOR APPROVAL
4	REVISED FOR APPROVAL
5	REVISED FOR APPROVAL

APPROVAL DESCRIPTION

SUBSTATION  
EQUIPMENT  
SECTION B-B  
&  
SECTION C-C

34"x22" FULL SIZE  
(1/4"=1' SCALE)

SCALE: 1"=5'

SHEET NUMBER: DDC-E-211-02

**This foregoing document was electronically filed with the Public Utilities**

**Commission of Ohio Docketing Information System on**

**5/27/2021 4:58:16 PM**

**in**

**Case No(s). 20-1814-EL-BGN**

Summary: Application Exhibit A (Preliminary Site Plan) electronically filed by Mr. Michael J. Settineri on behalf of Dodson Creek Solar, LLC