Public Utilities Commission of Ohio

Memo

To: Docketing Division

From: Jill Henry, Rail Specialist, Rail Division

Cc: PUCO Legal Department

Date: 7/20/18

Re: PUCO Case No. 18-1135-RR-FED- In the Matter of a Request for the Installation of Active Warning Devices at the Norfolk Southern Railway & Wheeling & Lake Erie Railway Crossings, on Public Road DOT#503-246N & DOT#473-002U in Jefferson County, Ohio.

On July 25, 2016, the Ohio Rail Development Commission (ORDC) authorized funding for Norfolk Southern Railway (NS) & Wheeling & Lake Erie Railway (WE) to install active warning devices at Public Road, DOT#503-246N & DOT#473-002U, in Jefferson County, Ohio. The crossings were surveyed on April 19, 2016 and found to warrant the upgrades. The electric utility provider for the crossings is American Electric Power- AEP.

The project will be paid for with federal funds and are actual cost. The plans and estimates for the project in the amount of \$275,439 for NS and \$221,222.17 for WE have been approved. Construction may commence at once. **Staff requests a Finding & Order with completion of the project in nine months.** Staff requests that the following language be incorporated in the Finding & Order:

It is expected that all work necessary for FHWA acceptance of the warning devices will be completed by the in-service due date and that the <u>railroad will be responsible</u> for this work. This work includes, but is not limited to:

- Any ancillary work to make the warning devices function as designed and visible to the roadway user, and
- MUTCD compliance, including minor roadway work if necessary.

Please serve the following parties of record:

Norfolk Southern Railway Company Stephen Klinger Public Projects Engineer 1200 Peachtree Street NE Atlanta, GA 30309-3597

Norfolk Southern Railway Company Cayela Wimberly Director Grade Crossing Safety 1200 Peachtree Street NE Atlanta, GA 30309-3597

Eastman & Smith LTD.
Casey Talbott
Attorney for Norfolk Southern
One SeaGate 24th Floor
P.O. Box 10032
Toledo, OH 43699-0032

Ohio Rail Development Commission Cathy Stout Safety Manager 1980 West Broad Street Mail Stop #3140 Columbus, OH 43223

Wheeling & Lake Erie Railway Company Tim Andrews Signal & Communication Supervisor 100 E. First Street Brewster, OH 44613

Village of Yorkville Blair Closser Mayor 139 Market Street Yorkville, OH 43971

American Electric Power- AEP

OHIO RAIL DEVELOPMENT COMMISSION INTER-OFFICE COMMUNICATION

TO: Randall Schumacher, Rail Division, PUCO

FROM: Cathy Stout, Manager, Safety Section, ORDC

BY: James Tucker, Project Manager, ORDC J. T.

SUBJECT: Jefferson County, CR2/Public Rd. DOT #473002U

Wheeling & Lake Erie (WE), PID 103324

Jefferson County, CR2/Public Rd. DOT #503246N

Norfolk Southern (NS), PID 103324

DATE: May 22, 2018

The Public Utilities Commission of Ohio (PUCO) established a diagnostic survey at the subject location on May 19, 2016. The Ohio Rail Development Commission (ORDC) attended the review. The Diagnostic Team recommended the improvement of warning devices for both the WE and NS to new flashing lights and roadway gates with circuitry upgrades to include 19 seconds of APT for future use. Copies of the diagnostic review form and the plan and estimates are attached.

PE has already been provided by the railroad. ORDC approves the site plans and estimates as provided. Please issue a construction-only order for the project outlined above for twelve months. This construction authorization is made with the stipulation and understanding that any field work needs prior approval before the work begins. This authorization is made with the stipulation and understanding that an approved estimate may contain entries for items or activities that may be cited and found to be ineligible for federal participation during the project audit.

It is expected that all work necessary for FHWA acceptance of the warning devices will be completed by the in-service due date and that the <u>railroad will be responsible</u> for this work. This work includes, but is not limited to:

- any ancillary work to make warning devices function as designed and visible to the roadway user, and
- MUTCD compliance including minor roadway work if necessary.

Thank you for your assistance with these matters.

Attachment: Diagnostic Review

Plan & Estimate



Mail Stop #3140, 1980 West Broad Street, Columbus OH 43223 John R. Kasich, Governor • Mark Policinski, ORDC Chairman

May 22, 2018

Mr. Stephen Klinger Public Projects Engineer 1200 Peach Street NE, Box 123 Atlanta, Ga. 30309

RE:

Jefferson County, CR2/Public Rd, DOT #503246N

PID#103324, NS Project 10.2204

Dear Mr. Klinger:

The plan and estimate dated March 28, 2018, for the referenced project has been reviewed and is acceptable. NS may proceed with the construction of the proposed light and gate with circuitry upgrades to include 19 seconds of APT (future use) in accordance with the abbreviated plan. This authorization is made with the stipulation and understanding that the approved estimate may contain entries for items or activities that may be cited and found to be ineligible for federal participation during the project audit. Reimbursement of eligible actual cost from ORDC is limited to \$275,439.00. Additional costs must be approved in writing by the Ohio Rail Development Commission (ORDC) prior to being incurred. Emergency verbal authorizations by ORDC may be permitted and will be confirmed by ORDC in writing within ten (10) business days of the verbal approval.

This authorization is contingent upon NS accepting the following instructions:

- 1. NS's project foreman will furnish written notification five (5) working days prior to the date work will start at the project site to James Tucker, ORDC, email james.tucker@dot.ohio.gov and to the Public Utilities Commission of Ohio at jill.henry@puco.oh.gov NS's project foreman will also notify the same of any stops and re-starts of the work activity and of the date work was completed for the project.
- 2. NS will arrange for utilities to be located at the project site by the Ohio Utilities Protection Service (OUPS) prior to any construction activities at the site. Utilities that are not participating members of the service must be contacted directly by NS.
- 3. NS's project foremen will notify James Tucker at 614-398-6897 (telephone) or james.tucker@dot.ohio.gov (email) of any changes in the scope of work, cost overruns, material changes, etc. which are not included in the approved plan and estimate and secure approval of same before the work is performed.
- 4. Open cut of roadways is not permitted except in unusual circumstances and must be coordinated with the local highway authority and preapproved by ORDC.
- 5. NS will furnish two (2) copies of each partial bill to ORDC. Please find the enclosed ODOT Purchase Order to reference when billing.



www.rail.ohio.gov phone: 614.644.0306

IMPROVING RAIL TODAY FOR TOMORROW'S ECONOMY

- 6. NS will furnish two (2) copies of the final all-inclusive bill to ORDC stating the exact dates of starting and completing work, the initial and final dates of construction and location where the accounts may be audited.
- 7. This installation will include any ancillary work to make the warning devices function as designed and meet MUTCD.

Thank you for your assistance with these matters.

Sincerely,

James Tucker Project Manager

C: Randall Schumacher, Rail Division Supervisor, PUCO Jill Henry, Grade Crossing Planner, PUCO Susan Arduini, ORDC ORDC (file)

OHIO RAIL DEVELOPMENT COMMISSION



Mail Stop #3140, 1980 West Broad Street, Columbus OH 43223 John R. Kasich, Governor • Mark Policinski, ORDC Chairman

May 22, 2018

Mr. Tim Andrews Wheeling & Lake Erie Railway 100 East First Street Brewster, Ohio 44613

RE: Jefferson County, CR 2/Public Rd. Wheeling & Lake Erie (WE)

DOT 473002U, PID# 103324

Dear Mr. Andrews:

The plan dated September 7, 2017 and estimate dated February 21, 2018, for the referenced project has been reviewed and is acceptable. WE may proceed with the construction of the proposed light and gate with circuitry upgrades to include 19 seconds of APT (future use) in accordance with the abbreviated plan. This authorization is made with the stipulation and understanding that the approved estimate may contain entries for items or activities that may be cited and found to be ineligible for federal participation during the project audit. Reimbursement of eligible actual cost is limited to \$221,222.17. Additional costs must be approved in writing by the Ohio Rail Development Commission (ORDC) prior to being incurred. Emergency verbal authorizations by ORDC may be permitted and will be confirmed by ORDC in writing within ten (10) business days of the verbal approval.

This authorization is contingent upon WE accepting the following instructions:

- 1. WE's project foreman will furnish written notification five (5) working days prior to the date work will start at the project site to James Tucker, ORDC, email James.tucker@dot.ohio.gov and to the Public Utilities Commission of Ohio at Jill.henry@puco.oh.gov WE's project foreman will also notify the same of any stops and re-starts of the work activity and of the date work was completed for the project.
- 2. WE will arrange for utilities to be located at the project site by the Ohio Utilities Protection Service (OUPS) prior to any construction activities at the site. Utilities that are not participating members of the service must be contacted directly by WE.
- 3. WE's project foremen will notify James Tucker at <u>James.tucker@dot.ohio.gov</u> (email) of any changes in the scope of work, cost overruns, material changes, etc. which are not included in the approved plan and estimate and secure approval of same before the work is performed.
- 4. Open cut of roadways is not permitted except in unusual circumstances and must be coordinated with the local highway authority and preapproved by ORDC.
- 5. WE will furnish two (2) copies of each partial bill to ORDC. Please find the enclosed ODOT Purchase Order to reference when billing.



www.rail.ohio.gov phone: 614.644.0306

IMPROVING RAIL TODAY FOR TOMORROW'S ECONOMY

- 6. WE will furnish two (2) copies of the final all-inclusive bill to ORDC stating the exact dates of starting and completing work, the initial and final dates of construction and location where the accounts may be audited.
- 7. This installation will include any ancillary work to make the warning devices function as designed and meet MUTCD.

Thank you for your assistance with these matters.

Sincerely,

James Tucker Project Manager

C: Randall Schumacher, Rail Division Supervisor, PUCO Jill Henry, Grade Crossing Planner, PUCO Susan Arduini, ORDC ORDC (file)



Detailed Estimate for Grade Crossing Warning Devices

City/State: YORKVILLE, OH Road: PUBLIC RD.

MilePost: RO-33.09 DOT/AAR: 503246N

State Proj. No.: County: JEFFERSON

S&E Proj. No.: 10.2204-2 File Number:

Man Days: 156

Purchases - Others

Meals and Lodging: \$21,338.55
Rental of Equipment: \$29,169.72

(2 Trucks, 1 Backhoe w/ Trailer and 1 Pipe-Pusher for 26 Days)

Construction Supervision Vehicle: \$4,461.99

Purchases - Other Total: \$54,970.26

Material And Additives

Material Cost: \$83,628.00

Sales and Use Tax: \$6,690.00

Material Handling Freight: \$8,362.80

Material Total: \$98,680.80

Labor And Additives

Labor Cost: \$50,232.00

(6 man crew at \$1,932.00 a day for: 26 days)

Payroll Tax & Overheads: \$42,827.80

Preliminary Engineering: \$14,055.30

Construction Supervision: \$14,672.77

Labor Total: \$121,787.87

Project Cost: \$275,438.93

Scrap / Salvage Credit: \$0.00

Project Total: \$275,439.00

Estimated on: 28-Mar-18 Estimated by: ndney

Estimate valid for 1 year from date of estimate



Norfolk Southern Railway <u>Highway Crossing Signalization Program - Material List</u>



Do not substitute items without permission from S & E Engineering

City:	YORKVILLE					
Road:	PUBLIC RD.					
Mile Post:	RO-33.09					
Drawing Number:	22310331					
State ProjectNumber:						
County:	JEFFERSON					
A A R Number:	503246N					
Project Number:	10.2204-2					
File Number:						
New File Number:	CX1112077					
WBS:	F-03568					
Store Number:						
Supervisor:	W.D. MCCAULEY					
Tax Code:						
Vendor to supply the follo	owing copies after pricing:					
2 Sets - with plans shippe	1 Set - Material Management with original Invoice 2 Sets - with plans shipped in car with material 1 Set - S&EGen. Supt. Construction w/copy of invoice					

Location: YORKVILLE OH S&E Proj. No.: 10.2204-2 AFE No.: F-03568 Drawing No.: 22310331

Store No.: P.O.Number: Date Required: Date Shipped: Vendor: UNKNOWN

							Qua	ntity Insta	alled	Quantity	
			Price			Quantity	Date	Date	Date	Returned	Special
Qty.	Class-Item-CD	UI	per Item	Total Price	Item Description	Shipped	Quan.	Quan.	Quan.	(Credit)	Instructions
3	670-360693-4	EA	\$5.55	\$16.65	AAR/DOT NUMBER PLATE/DECAL, ORDER 3 PER PROJECT. 60 DAY LEAD TIME. SUPPLIED BY S'TRAN.						
1	165-006505-4	EA	\$1,075.23	\$1,075.23	AC SERVICE, COMPLETE LESS METER BASE, ASSEMBLED ON 30' POLE						
20	105-002620-4	EA	\$248.79	\$4,975.80	BATTERY, NICAD 340AH, MODEL SPL340						
1	670-503047-4	EA	\$183.15	\$183.15	BELL, CROSSING ELECTRONIC GENERL SIGNAL, EB-3-360-5 CR 02-044350						
2	670-980689-4	EA	\$75.48	\$150.96	BRACKET HIGH WIND, (RIGID 3'), WIG- 191036, WALRUS TUSK TYPE						
2	670-561375-4	EA	\$1,208.79	\$2,417.58	BRACKET, GATE SAVER, NEG385102GS, SPRING LOADED SWING AWAY ADAPTER FOR FIBERGLASS/ALUMINUM GATES, USE WITH GATE 38' AND LESS						
1	670-356949-4	EA	\$90.00	\$90.00	CABLE, 10' GENERATOR HOOK UP, SERRMI P/N 40524. FEMALE CONNECTOR						
500	465-939422-4	LF	\$2.92	\$1,460.00	CABLE, UG 12 CONDUCTOR NO 14 AWG SOLID EACH CONDUCTOR WITH 5/64 IN INSULATION 10 MIL						
350	465-292862-4	LF	\$1.49	\$521.50	CABLE, UG 2-6 TWISTED, S-23 OKONITE 113-12-3933 SOLID TINNED CONDUCTOR						
500	465-292929-4	LF	\$4.12	\$2,060.00	CABLE, UG 5 COND. NO. 6 AWG SOLID COPPER CABLE TO MEET NS CORP. SPEC. FOR SIGNAL						
350	465-791835-4	FT	\$3.54	\$1,239.00	CABLE, UG AC ENTRANCE 3C#6-7X OKONITE FMPF-L 094-078 TR W/G 1 X 8 7X W010 BRZ TAPE 600V PRODUCT CODE 206-11-6070						
2	670-010671-4	EA	\$738.15	\$1,476.30	CHARGER, BATTERY CRAGG MODEL 40 DTC-12V, 40 AMP, P/N 520940						
2	670-664917-4	EA	\$90.11		CONNECTOR KIT, WELDED FAR RAIL, CONSISTING OF RUBBER HOSE PROPERLY DRILLED, BONDSTRAND, 1 SPLICING SLEEVE, 1 REDUCING SLEEVE, 3 CLAMPS, 1 TRACK CLIP, 1 WEB WELDED TRACK CONNECTOR, 1 WELD METAL, SAFETRAN 111359-2X						
2	670-632520-4	EA	\$79.69	\$159.38	CONNECTOR KIT, WELDED NEAR RAIL, CONSISTING OF, RUBBER HOSE PROPERLY DRILLED, BONDSTRAND, SPLICING SLEEVE, 1 REDUCING SLEEVE, 5 CLAMPS, 1 TRACK CLIP, 1 WEB WELDED TRACK CONNECTOR, 1 WELD METAL, SAFETRAN 111359-1X						

APPROVED BY STATE APPROVED BY RAILROAD CAR NUMBER SEAL NUMBER

Location: YORKVILLE OH S&E Proj. No.: 10.2204-2 AFE No.: F-03568 Drawing No.: 22310331

Store No.: P.O.Number: Date Required: Date Shipped: Vendor: UNKNOWN

								ntity Insta	alled	Quantity	
Qty.	Class-Item-CD	UI	Price per Item	Total Price	Item Description	Quantity Shipped	Date Quan.	Date Quan.	Date Quan.	Returned (Credit)	Special Instructions
2	670-794453-4	EA	\$1,253.03	\$2,506.06	COUNTERWEIGHT PKAGE, 25-31'GATE S'TAN S- MECH ONLY, STAINLESS TO INCLUDE HUB, SUPPORT ARMS						
2	670-760012-4	EA	\$9.95	\$19.90	COVER, FOR 1 WAY FLASHING LIGHT ASSY. 18 OZ. BLACK VINYL COATED NYLON. ====TO COVER 2 LAMPS====						
1	670-986650-4	EA	\$354.27		DISPOSAL, CONSTRUCTION DEBRIS AND CLEANING X'ING EQUIPMENT CONTAINER						
1	670-000004-4	EA	\$700.00	\$700.00	FCC LICENSE FOR MONITOR/RADIO						
12	670-000003-4	EA	\$255.85		FILL/STONE #57, QUANITY IS BASED ON TRUCK LOAD PLUS DELIVERY COST						
1	670-015231-4	EA	\$599.40	\$599.40	FOUNDATION, DIXIE,S-2 GATE 2'6"X2'6"X5'6" ASSEMBLED						
1	670-005378-4	EA	\$387.95	\$387.95	GATE ARM, ALUMINUM, 25-31 FT, ARM ASSEMBLY, INCLUDES GATE GUARD FOR GATE LIGHT CABLE. HIGH INTENSITY /ERTICAL STRIPES.						
1	670-675667-4	EA	\$31,602.51		GCP4000 - 1 TRK (2TC) - REDUNDANT - 40/40 AMP WIRED RACK EQUIP. FOR 6X8 XING SHELTER, (INCL. 2 TRK CHASSIS A80465, 2 TRK MODS. A80418, 2-SSCC A80405, 2 CPU A80403, 1 SEAR A80410, 1 DISPLAY A80407, , 2-40 AMP CHARGERS) IPN: 003131-1X						
1	670-477991-4	EA	\$410.00	\$410.00	KIT, GROUNDING ASSY FOR AL I/S INCLUDES 8 GRD RDS,200'#4WIRE,12 4 WIRE ONE-SHOTS. ERICO SBK206						
1	670-123298-4	EA	\$345.97		KIT, HARDWARE SUPPLIES REQUIRED X'ING P'CKAGES. WEB CONNECTORS FOR SHUNT(8EA) TAPE, AMPS,P'GUM PAINT,SLEEVES,TAGS,GLUE, 100 EA WHITE TAGS,)NE CAN BLUE MARKING PAINT ETC						
1	670-092155-4	EA	\$160.00	\$160.00	LAMP ASSY, LED GATE ARM KIT (INCLUDES 3 LAMPS COMPLETE WITH CABLES AND MTG. HARDWARE) REC #: 9298-1120						
1	670-005058-4	EA	\$1,786.08		LAMP ASSY, LED, 5" MAST BACK TO BACK LIGHTS (IPN: 042003-L487XNS)						
4	255-590880-4	EA	\$17.52		LOCK, AMERICAN LOCK MODEL H-10KA KEYED ALIKE TO PRIVATE KEYWAY D456 AND STAMPED "NS SIG"						
1	670-637778-4	EA	\$1,384.63		MAST, 5" ALUMINUM 13'10" WITH DOUBLE JCT. BOX BASE. S'TRAN P# 070519-11AX.						
1	670-521147-4	EA	\$3,458.00	\$3,458.00	MECHANISM, GATE MODEL S-40, WITH CONTACT HEATER, COMPLETE W/RELAY S'TRAN # 074000-W00090						

APPROVED BY STATE APPROVED BY RAILROAD CAR NUMBER SEAL NUMBER

Location: YORKVILLE OH S&E Proj. No.: 10.2204-2 AFE No.: F-03568 Drawing No.: 22310331

Store No.: Date Required: Date Shipped: Vendor: UNKNOWN

								:			
			Price			Quantity	Quantity Installed Date Date Date		Quantity Returned	Special	
Qty.	Class-Item-CD	UI	per Item	Total Price	Item Description	Shipped		Quan.		(Credit)	Instructions
1	000-000000-4	EA	\$5,000.00	\$5,000.00	MISC. EXPENSE, UNDERGROUND BORING						
2	670-001347-4	EA	\$57.10		PACKAGE, HARDWARE SIGN 5 IN. MOUNTING, SERRMI A1250-5, HARMON @200965-000, OR						
1	255-646807-4	EA	\$32.59		PADLOCK, SAFETRAN PART NO. 030399-29X SCREW TYPE FOR CIR CONTROLLER AND BTY. BOX						
5	670-259211-4	EA	\$47.25	\$236.25	PLUG BOARD KIT, TYPE B-1 & VOLTAGE TEST TERMINAL, SAFETRAN 420000-75X						
1	165-902002-4	EA	\$297.48	\$297.48	PROTECTOR, SURGE 120/240VAC, ERICO P/N EPD120/240TDFL						
4	465-002899-4	EA	\$40.24	\$160.96	REEL, CABLE DISPOSABLE FOR CROSSING SIGNAL PACKAGES						
1	670-024861-4	EA	\$424.00		RELAY RACK, SWING, FARADAY SHELTER FOR EIGHT B1 RELAYS, SAFETRAN P/N 057883-1X						
5	670-707995-4	EA	\$510.12	\$2,550.60	RELAY, TYPE B1, NEV LINE, 900 OHMS, 008 AMPERES GRS A62-308 OR SAFETRAN @400003						
2	435-805560-4	EA	\$2.78	\$5.56	SAND, 25LB BAG FOR CABLE ENTRANCE INTO THE SHELTER						
1	670-113448-4	EA	\$910.23	\$910.23	SEARIII, (VHFC w/ANTENNA) - VHF COMMUNICATOR, SAFETRAN P/N A80276, 1/ PER CROSSING						
1	670-749325-4	EA	\$226.97	\$226.97	SHELF, FOLDING, FOR LAPTOP USE IN FARADAY 6X8 SHELTER, SAFETRAN 052852-128X						
1	670-755523-4	EA	\$9,333.50		SHELTER, 6'X8' ALUMN FARADAY W/1EA EQUIPMENT RACK, W/CABLE CHUTES BEHIND TERMINAL BOARD, W/GEN RECEPTICAL, BREAKER BOX GFI OUTLET FOR LAPTOP SHELF SAFETRAN 058400-68-85						
2	670-586967-4	EA	\$44.91	\$89.82	SHUNT COVER W/LAG SCREWS, 19"X19", SERRMI #40271, ORDER 1 PER SHUNT						
2	670-792699-4	EA	\$49.50	\$99.00	SHUNT, HARDWIRE SERRMI A1000-5						
1	670-554843-4	EA	\$77.05	\$77.05	SIGN, 2 TRACK SIGN, HIGH INTENSITY, SAFETRAN #035207- 2HX						
1	670-016346-4	EA	\$143.38		8 SIGN, X-BUCK, HI-INTENSIVE REFLECTIVE FRT. & BACK FOR ALL STATES, SAFETRAN# 035200-91X						
1	670-393331-4	EA	\$37.43	\$37.43	GN, CROSSING ENS MALFUNCTION ASSEMBLY FOR 4" AND MAST, SAFETRAN #T17215						

APPROVED BY STATE APPROVED BY RAILROAD CAR NUMBER SEAL NUMBER

Location: YORKVILLE ОН S&E Proj. No.: 10.2204-2 AFE No.: F-03568 Drawing No.: 22310331 P.O.Number:

Date Required:

Date Shipped:

Qty.	Class-Item-CD	UI	Price per Item	Total Price	Item Description	Quantity Shipped	Qua Date Quan.	ntity Insta Date Quan.	alled Date Quan.	Quantity Returned (Credit)	Special Instructions
1	670-330382-4	RL	\$18.06	\$18.06	TAPE, THOR 3" DURATEC, ORANGE 1000' LENGTHS. "WARNING STOP DIGGING"						
5	670-007238-4	EA	\$118.65		UNIT, THE INSTALLATION AND WIRING OF A DEVICE WHICH REQUIRE A MINIMUM OF FOUR WIRE CONNECT-						
1	450-986008-4	EA	\$30.45	\$30.45	WRENCH, TEST POST TYPE B DWG 55393-3, GR.1						
120	165-544477-4	FT	\$3.22		Z-DNO-CONDUIT, 4"x10' PVC, SCHEDULE 80 BELL CONNECTOR AT ONE END, 1/2 PT. GLUE IN KIT 670-123298-4						

Total Material: \$83,628.00

Vendor: UNKNOWN

APPROVED BY STATE APPROVED BY RAILROAD CAR NUMBER SEAL NUMBER

Store No.:

SH. NO.	CONTENTS
NX1	INDEX SHEET
1	LAYOUT
2	PROFILE
3	CABLE PLAN
4	LOAD CENTER
5	B12 & B16 CHARGERS & BATTERIES
6	4000 GCP 2-TK CHASSIS & MODULE LAYOUT
7	4000 GCP PROGRAMMING SETUP
8	4000 GCP PROGRAMMING SETUP
9	CONNECTORS FOR TRACK MODULES
10	RR INTERCONNECT CIRCUITS
11	CPU MODULE, SEAR III & VHF HOOK-UPS
12	SEAR III PROGRAMMING SETUP
13	SSCC#1 MODULE HOOK-UP
14	SIGNAL "A" S40 GATE & FLASHER CIRCUITS
15	BACKBOARD 1A & 1B
16	REAR BACKBOARD 1A & 1B
17	FARADAY SHIELD 1A & 1B
18	FARADAY SHIELD 1C
19	HOUSE SIDE C LAYOUT & RACK PLACEMENT
20	HOUSE SIDE A LAYOUT
21	HOUSE SIDE B LAYOUT & TOP VIEW


SCALE: 1" = 20' PROJECT #10.2204


INDEX SHEET


FILE CX1112077


DESIGNED BY:		GNED BY:	NORFOL	K				
	WJK	01-20-18	NS NORFOL SOUTHE					
	DRAWN BY:		OFFICE OF ASS'T. VICE PRESIDENT COMM. & SIGNAL, ATLANTA, GA.	M.P.: RO-33.09				
	XRL 01-20-18		· · · · · · · · · · · · · · · · · · ·					
		KED BY:	YORKVILLE, OH FLGS AT PUBLIC RD.					
	PEH	02-01-18	RIVER LINE	FILE R-				
	IN SERVICE:		* ' = - = - : -	NO. "				
		1	CADD or DWG. No. 22310331.NX1	SHEET 1 of 1				


REVISION INITIALS PROPERTY
PENNSYLVANIA R.R.

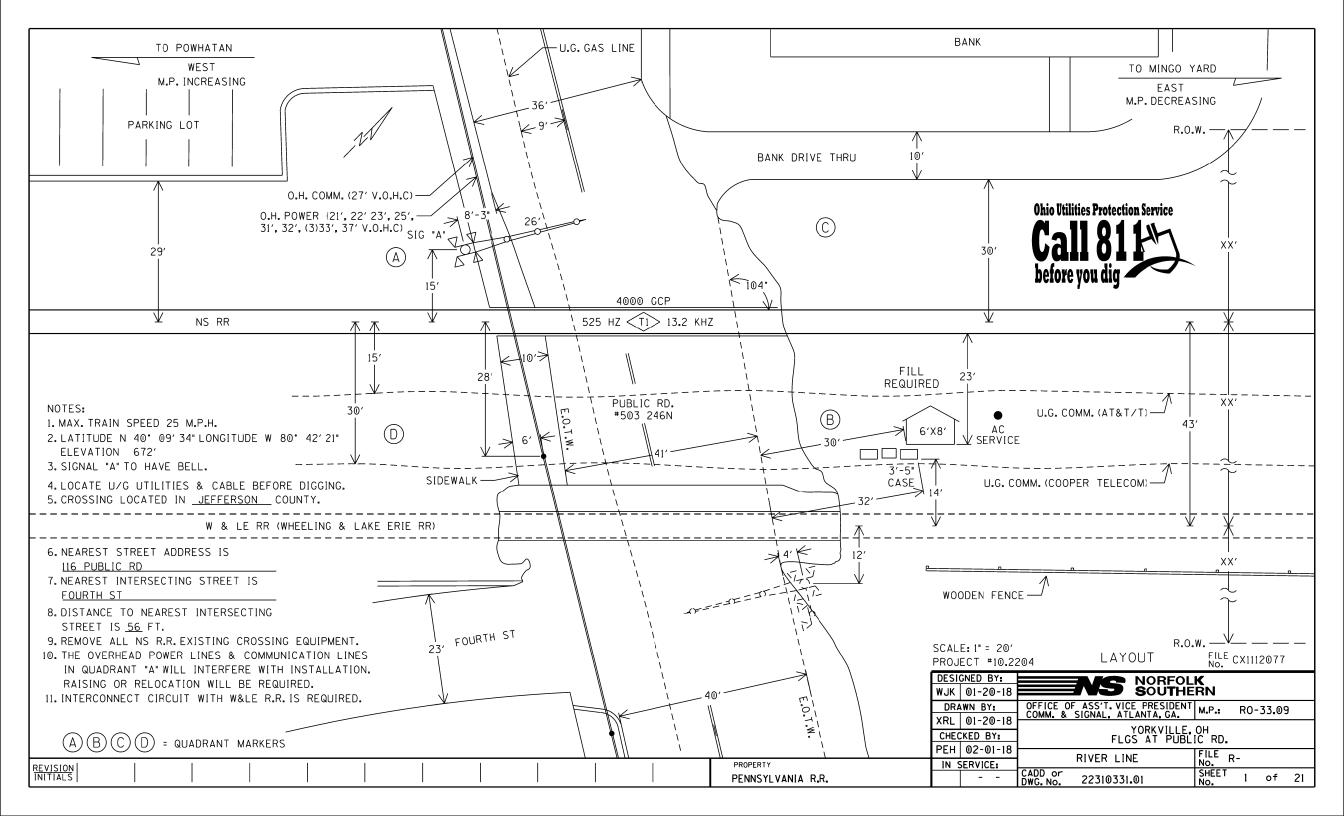


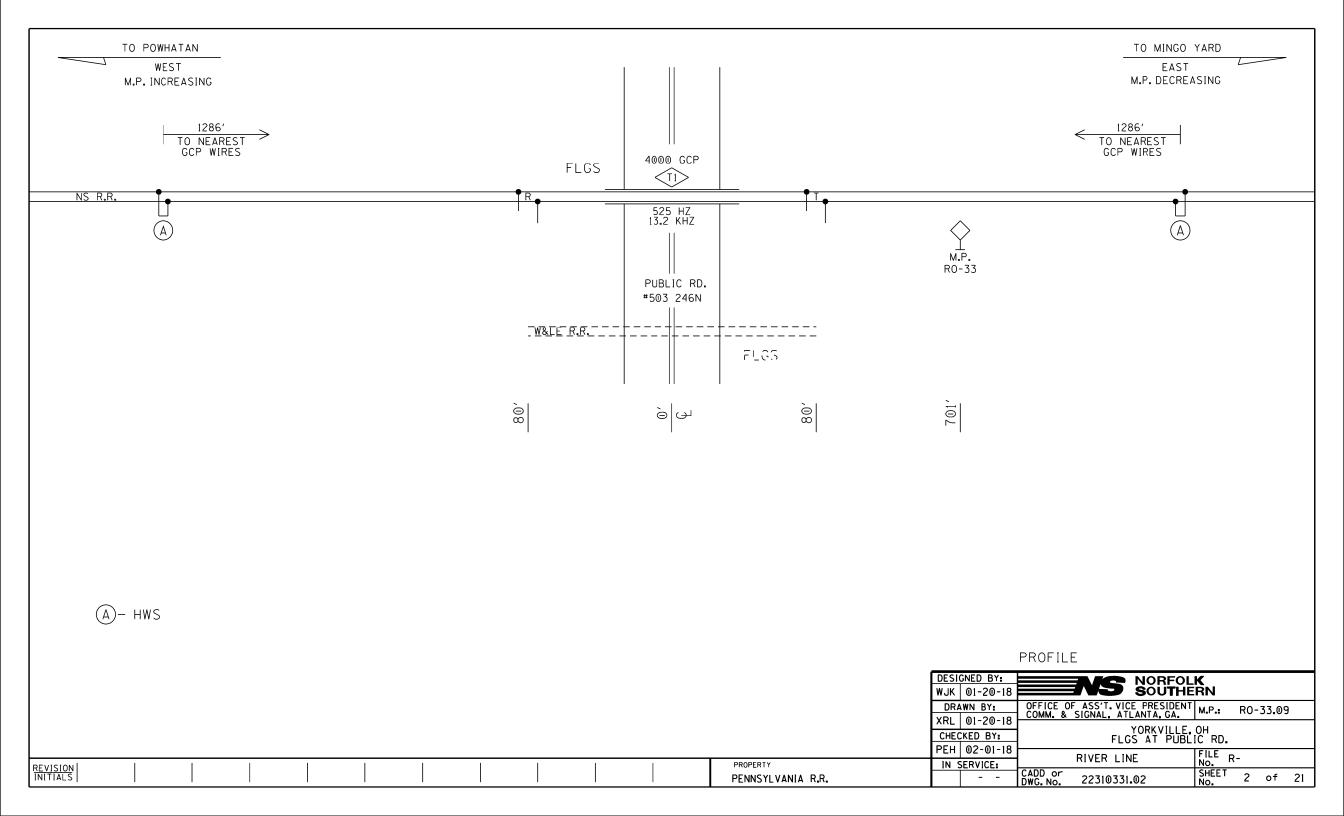

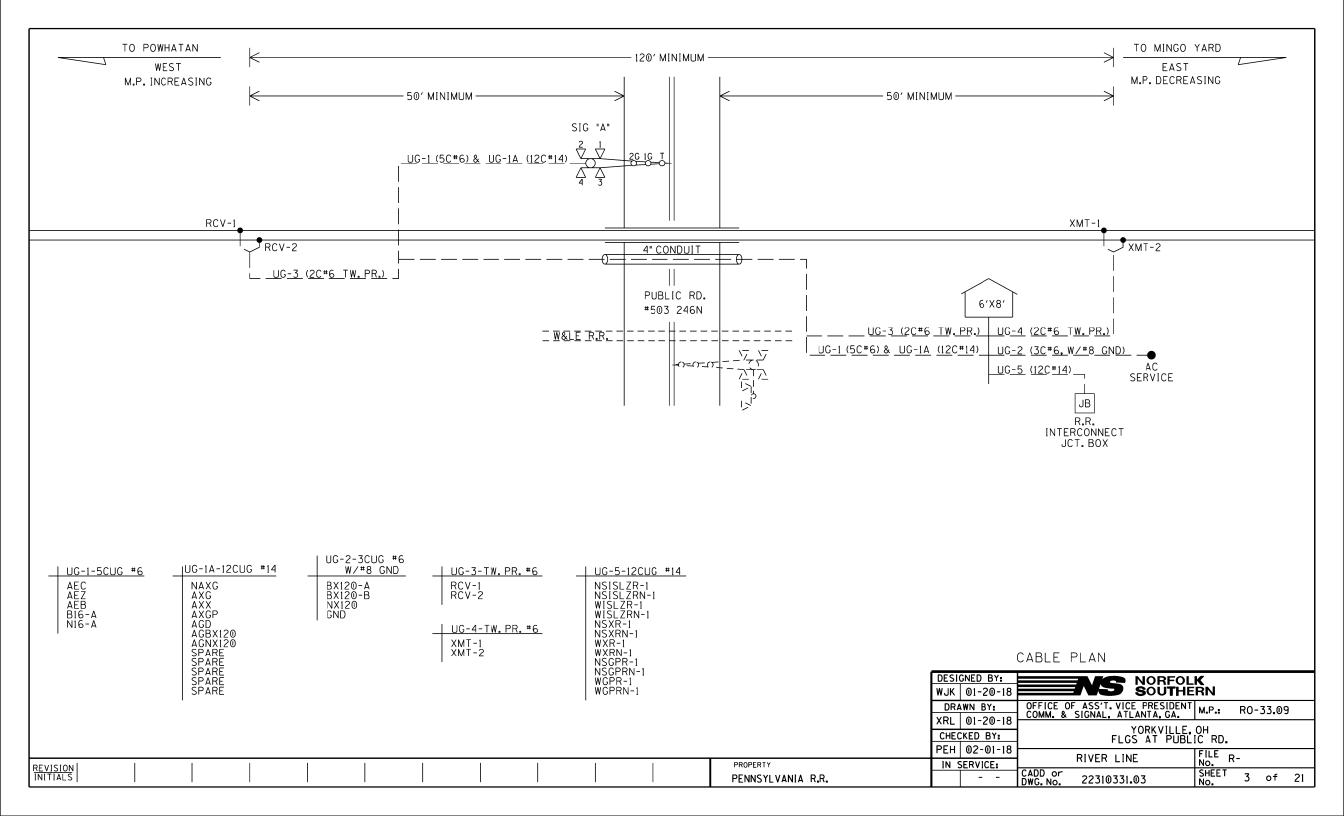

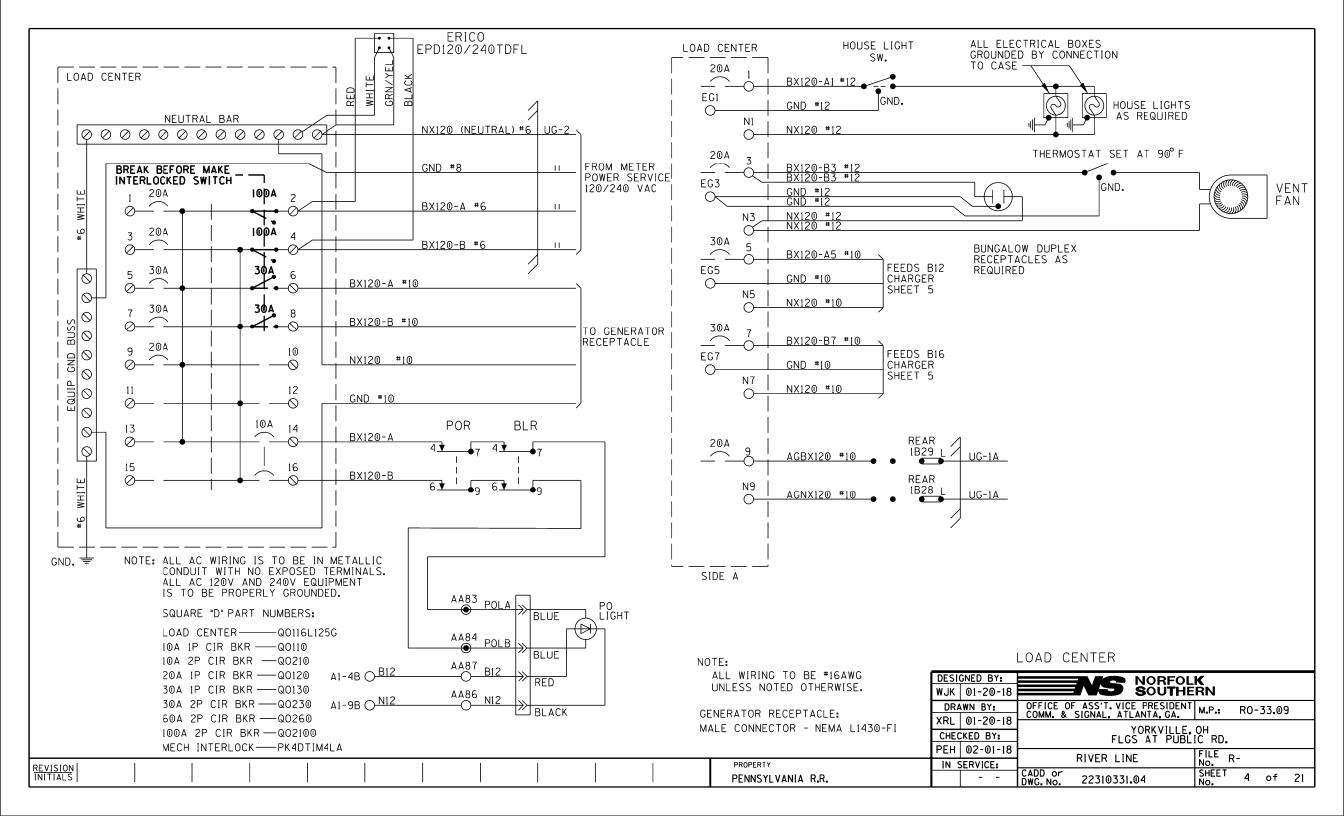

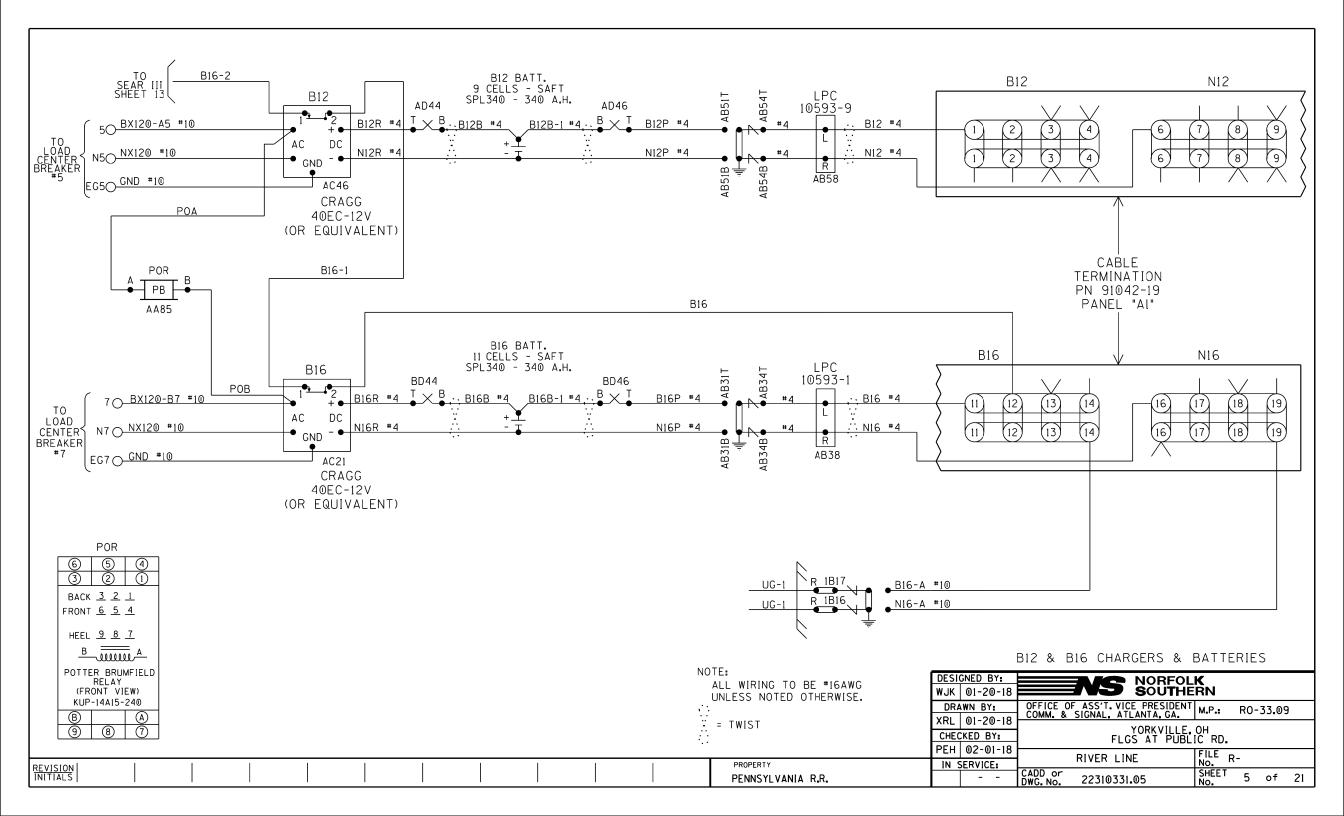

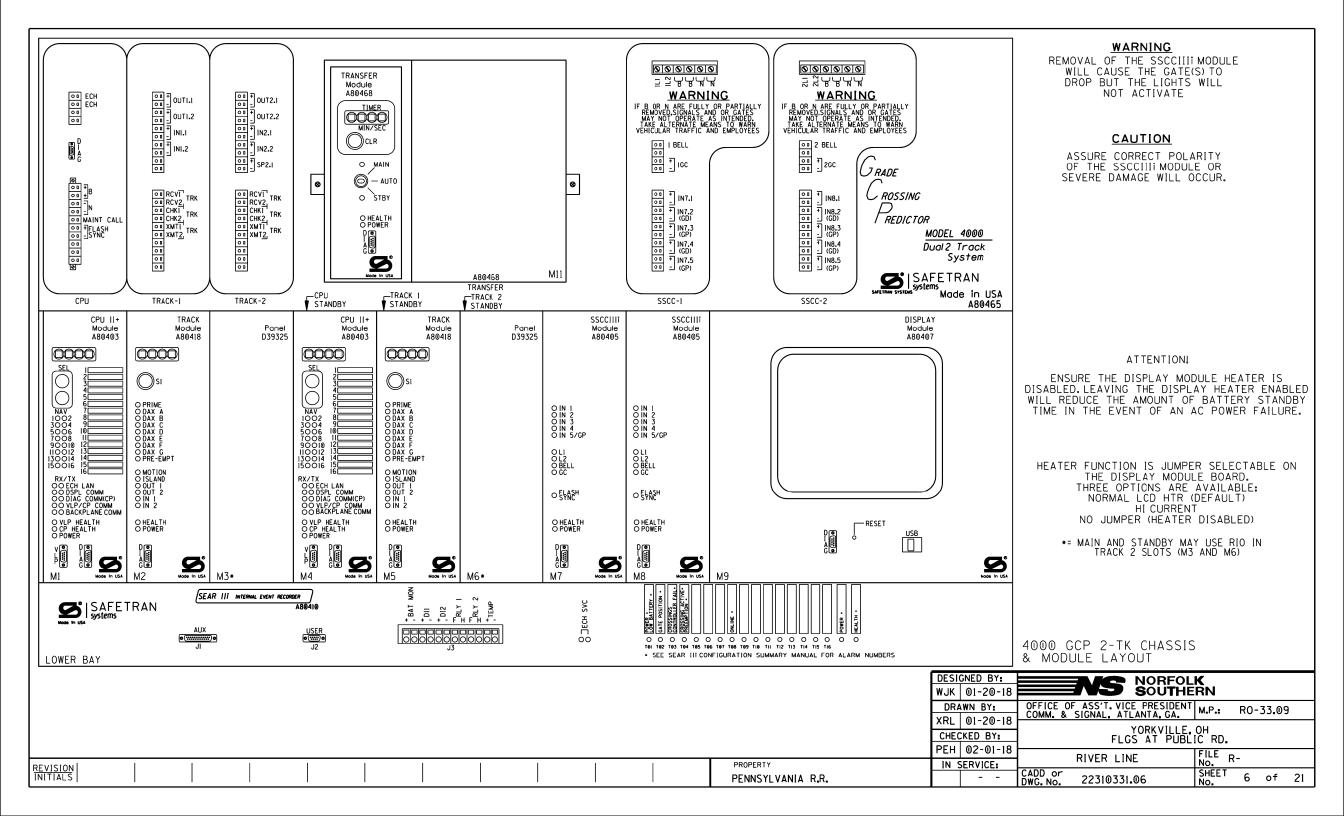

AND: AND 1 XR Program Report ADVANCED: internalI/O 1 GCP: track 1 AND 1 XR Track 1 = Prime _____ Track 1:GCP Freq Category = Standard Pass Thrus = No AND 1 Enable Used = Yes Track 1: GCP Frequency = 525 Hz Int.1 Sets = AND 1 XR Enable And 1 Enable Pickup = 1 sec Location and SIN Int.1 Set by = AND 2Track 1: Approach Distance = 1286 ft AND 1 Enable Drop = 0 sec Int.2 Sets = Not Used Track 1: Uni/Bi/Sim-BidirnI = BidirnI _____ AND 1 Wrap Used = No Int.2 Set by = Not Used DOT Number: 503246N Track 1:GCP Transmit Level= Medium Int.3 Sets = Not Used Milepost Number: R0-33.09 Track 1: Island Connection = Isl1 AND: AND 2 Site Name: PUBLIC RD Int.3 Set by = Not Used Track 1: Island Distance = 160 ft AND 2 Track 1 = Prime Int.4 Sets = Not Used Track 1: Computed Distance = 9999 ft AND 2 Enable Used = Yes SIN: 755048207216 Track 1: Linearization Steps = 100 Int.4 Set by = Not Used AND 2 Enable Pickup = 5 sec AND 2 Enable Drop = 0 sec MCF and Template Selection ADVANCED: internalI/O 2 GCP: track ! enhanced det AND 2 Wrap Used = No Track 1: Inbound PS Sensitivity = Off Int.5 Sets = Not Used Int.5 Set by = Not Used MCF Name: GCP-T6X-02-1.mcf Track 1: Speed Limiting Used = Yes AND: AND 3 Track 1: Outbound False Act Lvl = Normal Track 1: Outbound PS Timer = 20 sec MCF Revision: 021 Int.6 Sets = Not Used AND 3 Track 1 = IslOnly Int.6 Set by = Not Used MCFCRC: 6076E435 AND 3 Enable Used = No Int.7 Sets = Not Used Track 1: Trailing Switch Logic = On Int.7 Set by = Not Used Int.8 Sets = Not Used AND 3 Wrap Used = No Template = 1A:6 Trk Bi Track 1: Post Joint Detn Time = 15 sec Track 1: Adv Appr Predn = No Track 1: Cancel Pickup Delay = This Isl ADVANCED: MS restart Int.8 Set by = Not Used Check Numbers MS/GCP Restart Used = No Office Check No.(DT 4.6.0): 2F01AD29 GCP: track 1 prime ADVANCED: internal[/0 3 ADVANCED: out of service Office Check Number: 2F01AD29 Track 1: Prime Warning Time = 30 sec Int.9 Sets = Not Used Track 1: Prime Offset Distance = 0 ft 00S Control = Display+00S IPs Config. Check Number: 69FD0032 Int.9 Set by = Not Used 00S Timeout = Yes (Based on MCF Revision 021) Track 1: Switch MS EZ Level = 10 Int.10 Sets = Not Used 00S Timeout = 1 hrs Track 1:Prime MS/GCP Mode = Pred Int.10 Set by = Not Used Int.11 Sets = Not Used Track 1: Prime Pickup Delay = 15 sec ADVANCED: out of service 2 Int.11 Set by = Not Used Program Track 1: Prime UAX = Not Used TI OOS Control = OOS Input 1 Int.12 Sets = Not Used BASIC: module configuration Int.12 Set by = Not Used GCP: track 1 pos start ADVANCED: track wrap circuits Track | Slot = Track Track 1: Positive Start = Off Wrap LOS Timer = 5 sec Track 2/RIO 1 Slot = Not Used Track 1: Sudden Shnt Det Used = No ADVANCED: internalI/O 4 Track 1 Wrap Used = No Track 3 Slot = Not Used Track 1: Low EZ Detection Used = No Int.13 Sets = Not Used Track 4 Slot = Not Used Int.13 Set by = Not Used Track 5/RIO 2 Slot = Not Used Track 6/RIO 3 Slot = Not Used ADVANCED: trk 1 overrides Int.14 Sets = Not Used GCP: track 1 MS Control Track 1: All Predictors Override Used = No Track 1: MS/GCP CtrIIP Used = No Int.14 Set by = Not Used SSCC-1 Slot = SSCC3iTrack 1:MS Sensitivity Level = 0 Int.15 Sets = Not Used ADVANCED: OR logic SSCC-2 Slot = Not Used Track 1: Compensation Level = 1300 Int.15 Set by = Not Used OR 1 Used = No SEAR Used = Yes Track 1: Warn Time-Ballast Comp = High Int.16 Sets = Not Used OR 2 Used = No Track 1:Low EX Adjustment = 39 Int.16 Set by = Not Used OR 3 Used = No BASIC: MS/GCP operation Track 1: Bidirn Dax Passthru = No Track 1: MS/GCP Operation = Yes OR 4 Used = No ADVANCED: site options Track 1: False Act on Train Stop = No Daylight Savings = On Track 1:EX Limiting Used = Yes BASIC: island operation Track 1: EZ Correction Used = Yes Units = Standard Track 1: Island Used = Internal Maint Call Rpt IP Used = No Emergency Activate IP = No ISLAND: track 1 BASIC: preemption Track 1: IsIFrequency = 13.2 kHz EZ/EX Logging = Change Track 1: Pickup Delay (2s +) = 0 sec Preempt Logic = No EZ/EX Point Change = 3 Track 1: IslEnable IP Used = No BASIC: radio Dax links Radio DAX link A Used = No AND: track Anding Radio DAX link B Used = No AND 1 XR Used = Yes AND 2 Used = Yes BASIC: Vital Comms links AND 3 Used = Yes VitalComms link 1 Used = No AND 4 Used = No VitalComms link 2 Used = No AND 5 Used = No AND 6 Used = No PREDICTORS: track 1 AND 7 Used = No Track 1: Prime Used = Yes AND 8 Used = No Track 1: Dax A Used = No Track 1: Dax B Used = No Track 1:Dax C Used = No Track 1: Dax D Used = No Track 1: Dax E Used = No Track 1: Dax F Used = No

Track 1: Dax G Used = No

REVISION INITIALS 4000 GCP PROGRAMMING SETUP

ı	DESIGNED BY:		NORFOL	K				
	WJK	01-20-18	NORFOL SOUTHE					
DRAWN BY:			OFFICE OF ASS'T. VICE PRESIDENT COMM. & SIGNAL, ATLANTA, GA.	M.P.:	RO-	33.09	3	
	XRL	01-20-18	YORKVILLE, OH FLGS AT PUBLIC RD.					
ı	CHEC	KED BY:						
	PEH	02-01-18	RIVER LINE	FILE	R-			
	IN SERVICE:		KIVEK LINE	No.	• •			
			CADD or DWG. No. 22310331.07	SHEET No.	7	of	21	

PENNSYLVANIA R.R.


SSCC SEAR: inputs slot 5 Gates Used = Yes IN 5.1 = Not Used Min Activation = 0 sec IN 5.2 = Not Used Rmt Activation Cancel = 2 min SEAR: inputs slot 6 Bell On Gate Rising = No IN 6.1 = Not Used Mute Bell On Gate Down = No SSCCIV Controller Used = No IN 6.2 = Not Used SEAR: slot 7-8 inputs SSCC-1 Activation = AND 1 XR IN 7.2 = Not Used SSCC-1 Gate Delay = 6 sec IN 8.1 = Not Used SSCC-1 Number of GPs = 1 IN 8.2 = Not Used SSCC-1 Number of GDs = 1 SSCC 1: Flash Rate = 40 IN 8.3 = Not Used IN 8.4 = Not Used IN 8.5 = Not Used SSCC 1:Low Battery Detection = No SSCC 1: Flash Sync = master SSCC 1: Invert Gate Output = No SITE: programming SSCC 1: Lamp Neutral Test = Off Radio Subnode = 1 Aux-1 Xng CtrlUsed = No Field Password = Off Low Battery Enabled = Off OUTPUT: assignment page 1 Configuration Package File OUT 1.1 = AND 2 OUT 1.2 = AND 3 Filename: 22310331.pac INPUT: assignment page 1 IN 1.1 = AND 1 XR Enable IN 1.2 = Not Used IO: assignment SSCC OUT GC 1 = Gate Output 1 IN 7.1 = Out Of Service IP 1 IN 7.2 = Not Used IN 7.3 = AND 2 Enable IN 7.4 = GD 1.1IN 7.5 = GP 1.1SEAR Subnode = 3 DI 1 = POK 1 DI 2 = Not Used Rly 1 = General1 Rly 2 = Not Used SEAR: inputs SP 2.1 = Not Used SP 3.1 = Not Used SP 4.1 = Not Used SP 5.1 = Not Used SP 6.1 = Not Used SEAR: slot 1-4 inputs IN 1.2 = Not Used IN 2.1 = Not Used IN 2.2 = Not Used IN 3.1 = Not Used IN 3.2 = Not Used IN 4.1 = Not Used IN 4.2 = Not Used

REVISION INITIALS 4000 GCP PROGRAMMING SETUP

DESI	GNED BY:			NORFOL	K			
WJK	01-20-18		113	NORFOL SOUTHE	RN			
DRAWN BY:		OFFICE O	F ASS'T. VIC	E PRESIDENT ANTA, GA.	M.P.:	R0-	33.09)
XRL	01-20-18	-						
CHECKED BY:			YORKVILLE, OH FLGS AT PUBLIC RD.					
PEH	02-01-18		RIVER LIN	F	FILE B	<u>-</u>		
IN SERVICE:				_	NO.	•		
		CADD or DWG.No.	22310331	.08	SHEET No.	8	of	21

PROPERTY


PENNSYLVANIA R.R.

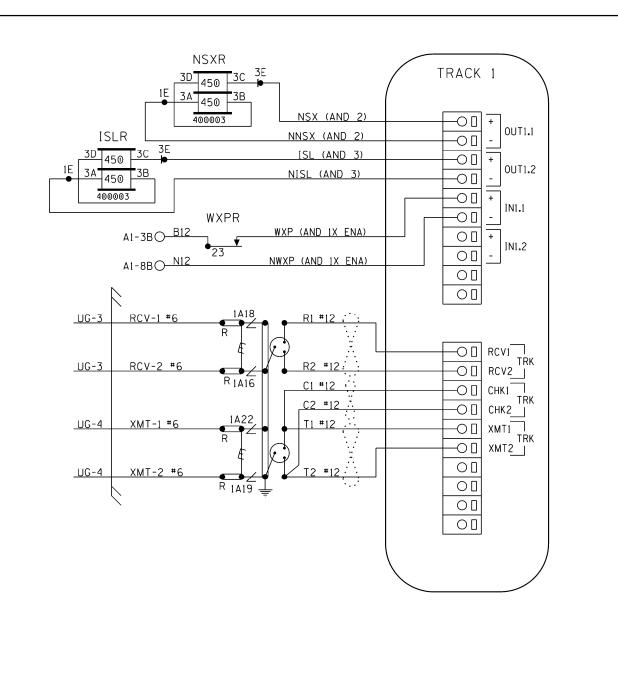


REVISION INITIALS

CONNECTORS FOR TRACK MODULES

NOTES: ALL WIRING TO BE #16AWG	DESIGNED BY: WJK 01-20-18	NS NORFOL SOUTHE	.K ERN
UNLESS NOTED OTHERWISE.	DRAWN BY:	OFFICE OF ASS'T. VICE PRESIDENT COMM. & SIGNAL, ATLANTA, GA.	M.P.: RO-33.09
∵ = TWIST	XRL 01-20-18 CHECKED BY:	YORKVILLE, FLGS AT PUBL	OH OH
<u> </u>	PEH 02-01-18	RIVER LINE	FILE D_
PENNSYLVANIA R.R.	IN SERVICE:	CADD or DWG. No. 22310331.09	SHEET 9 of 21

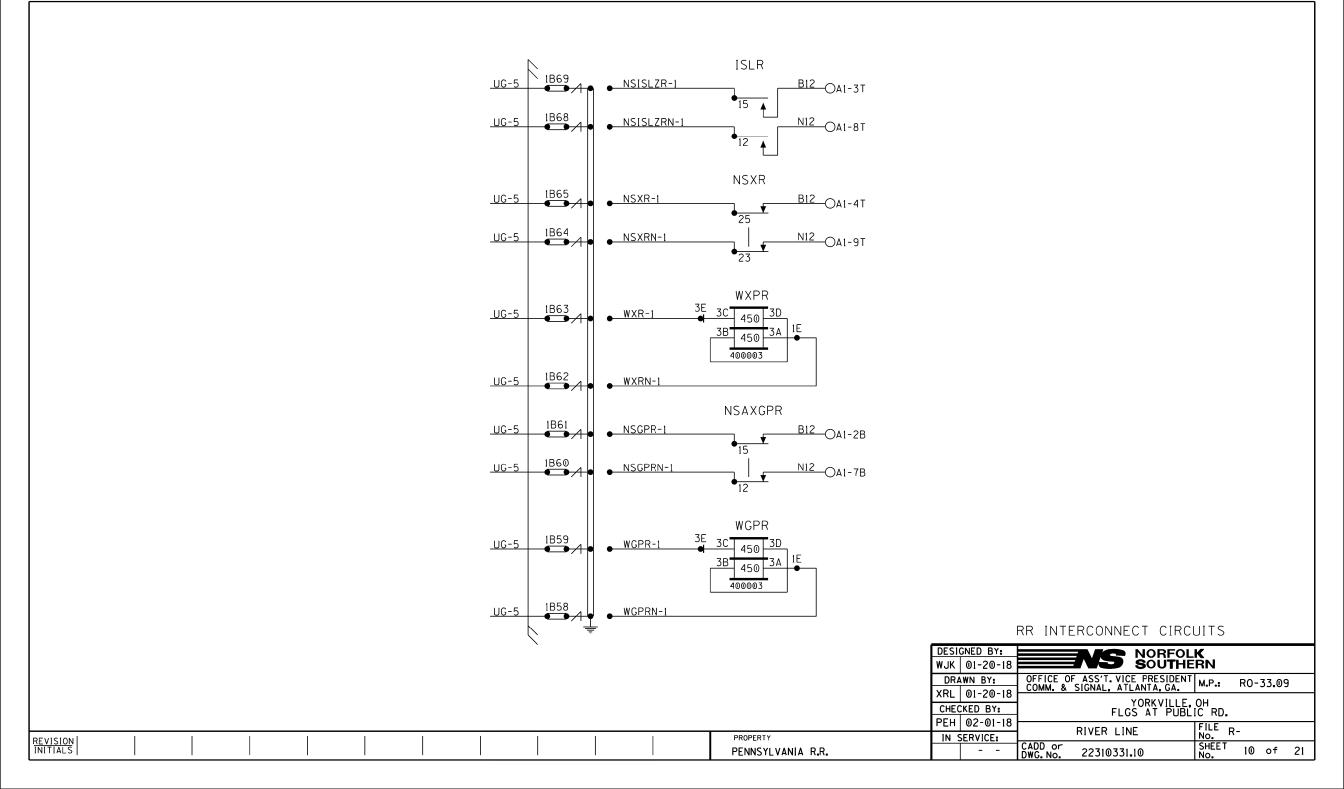

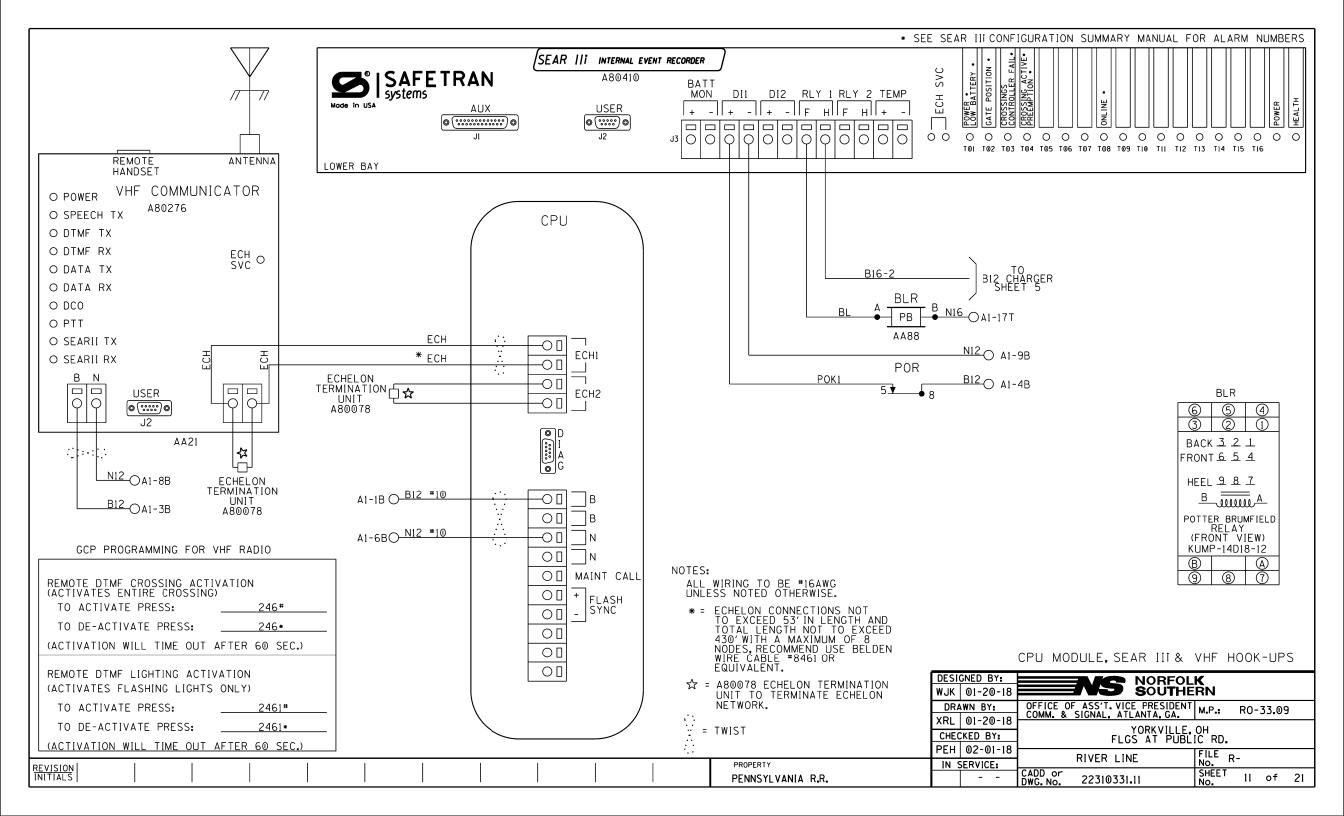

	SITE SET UP PROC	CEDURE				
	FUNCTION	LED DISPLAY				
	DATE/TIME					
	AUTOMATIC DST ADJUSTMENT	YES				
	TIME ZONE	EST				
	SITE NAME	PUBLIC RD.				
	MILEPOST	RO-33.09				
	DOT #	503246N				
	TESTER TYPE	CROSSING				
	DATE FORMAT	MM-DD-YYYY				
	TEMP FORMAT	FAHRENHEIT				
	INDICATE HOLD (SEC)	0				
	INDICATE REFRESH (SEC)	60				
	SITE ATCS	7.550.482.072.03.01				
	SITE TYPE	NO COMMUNICATION				
**	OFFICE ATCS ADDRESS	2.550.00.0000				
**	PRIMARY HOP ADDR	7.RRR.LLL.GGG.XX.XX				
**	BACKUP HOP ADDR 1	7.RRR.LLL.GGG.XX.XX				
**	BACKUP HOP ADDR 2	7.RRR.LLL.GGG.XX.XX				
**	POLL ID	1				
**	MODE	GEN/ATCS				
**	WAMS XID	DISABLED				
**	OFFICE COMM DEVICE	MCM (ECHELON)				
**	RADIO ATCS ADDR	7.RRR.LLL.GGG.01.01				
**	PHONE #	(OFFICE NUMBER)				
**	INIT STRING					
**	FIELD COMM DEVICE	NONE				
***	USER PORT BAUD	57600				
***	USER PORT DATA BITS	8				
***	USER PORT PARITY	NONE				
***	USER PORT STOP BITS	1				
***	USER PORT FLOW CONTROL	NONE				
***	AUX PORT BAUD	9600				
***	AUX PORT DATA BITS	8				
***	AUX PORT PARITY	NONE				
***	AUX PORT STOP BITS	1				
~ ~ *	AUX PORT FLOW CONTROL	NONE				

	CONTROL SYSTEM CONFIGURAT	TION MENU QUESTIONS
	THE QUESTION	SELECT FROM MENU OPTION
	RESET NAMES AND MODULES?	YES
	RAILROAD NUMBER	550
	CROSSING CONFIGURATION	NORMAL
	AND I USED AS XR?	YES
	AND 2 USED AS XR?	NO
	AND 3 USED AS XR?	NO
	AND 4 USED AS XR?	NO
	AND 5 USED AS XR?	NO
	AND 6 USED AS XR?	NO
	AND 7 USED AS XR?	NO
	AND 8 USED AS XR?	NO
*	XR CONTROLLED BY FOREIGN RR	
	ENTRANCE GATES	1
	85% VOLTAGE RELAY OUT	YES
*	GATES CONTROLLED BY FOREIGN RR	YES
	BATTERY BANKS	2
	BATTERY MON USED	NO
	PREEMPTION	NO
	INTERNAL CROSSING CONTROLLERS	1
	EXTERNAL CROSSING CONTROLLERS	0
	VHF COMMUNICATOR	YES
	DTMF ACTIVATION	YES
****	ACTIVATION CODE	246
	ACTIVATION TIMEOUT (SECONDS)	60
	ILOD MODULES	0
****	ANY LED BULBS USED	NO
	VHF VOICE CHANNEL	2
	VHF DATA CHANNEL	2
	USE CELL MODEM NON-CRITICAL FEATURE	NO

PROGRAM MENU QUESTIONS	PROGRAM
EDIT DIGITAL INPUTS	NO
EDIT BATTERIES	NO
EDIT RELAYS	NO
EDIT INDICATOR LEDS	NO
EDIT TEST LEDS	NO
EDIT ILOD SENSORS	NO
EDIT VHF SETTINGS	NO
GCP4K ATCS SUBNODE	16

NOTES:


- * = DISPLAYED IF CROSSING CONFIGURATION IS SPLIT GATE.
- •• = IF SITE TYPE = NO COMMUNICATION, THEN THESE OPTIONS ARE NOT DISPLAYED.
- *** = THESE SETTINGS SHOULD BE LEFT AT THE DEFAULT SETTING.
- **** = USE LAST 3 NUMBERS FROM DOT NUMBER.
- **** = IF ILOD MODULE >0.


SEAR III PROGRAMMING SETUP

١	DESIGNED BY:		NORFOL	K		
	WJK	01-20-18	SOUTHE			
		WN BY:	OFFICE OF ASS'T. VICE PRESIDENT COMM. & SIGNAL, ATLANTA, GA.	M.P.: RO-33.09		
	XRL	01-20-18	·			
		KED BY:	YORKVILLE, FLGS AT PUBL	IC RD.		
	PEH	02-01-18	RIVER LINE	FILE R-		
ı	IN SERVICE:		* ' = - = - : -	I NO		
			CADD or DWG. No. 22310331.12	SHEET 12 of 21		

TO CONFIGURE SEARIH PRESS SITE SETUP KEY. USE ARROW KEYS TO MAKE SELECTION, PRESS ENTER AFTER SELECTION HAS BEEN MADE.


PROPERTY
PENNSYLVANIA R.R.

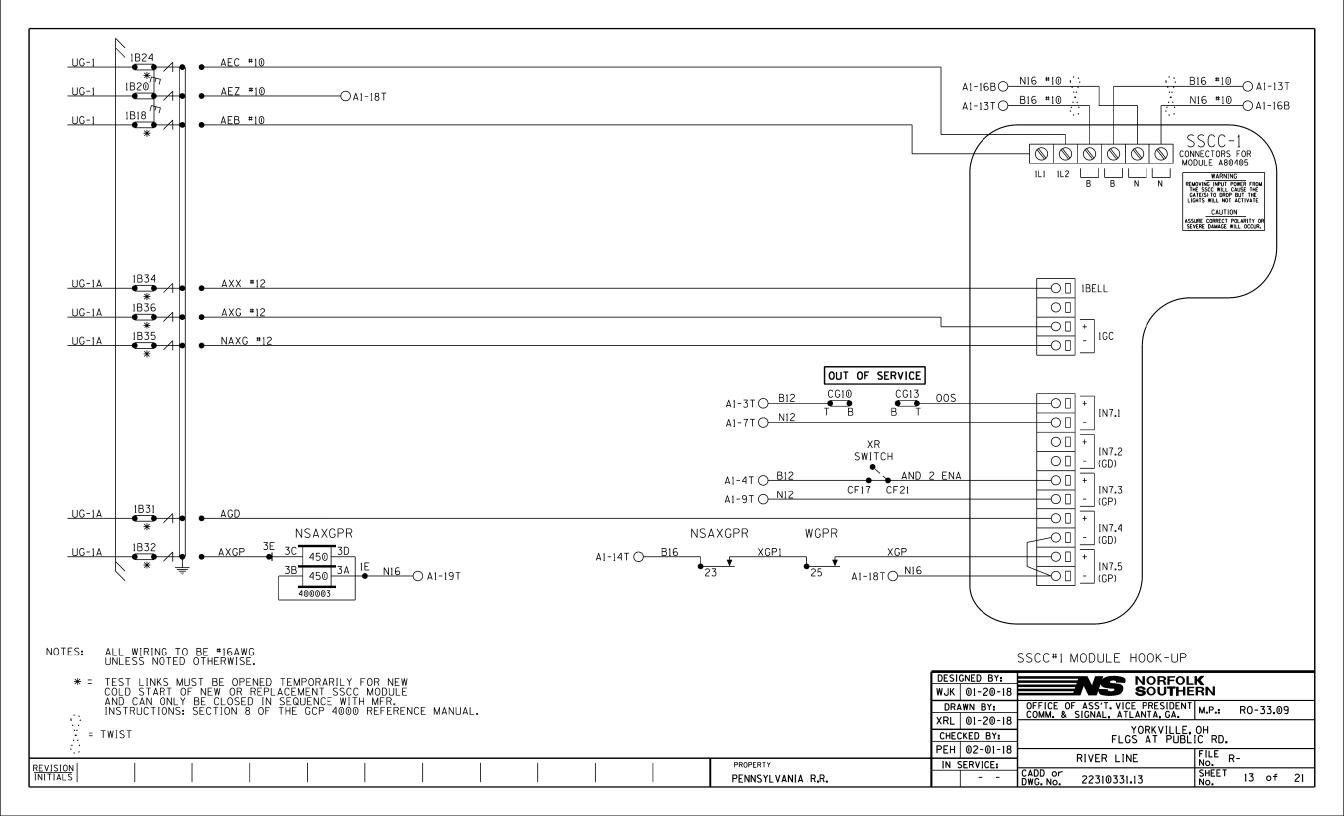


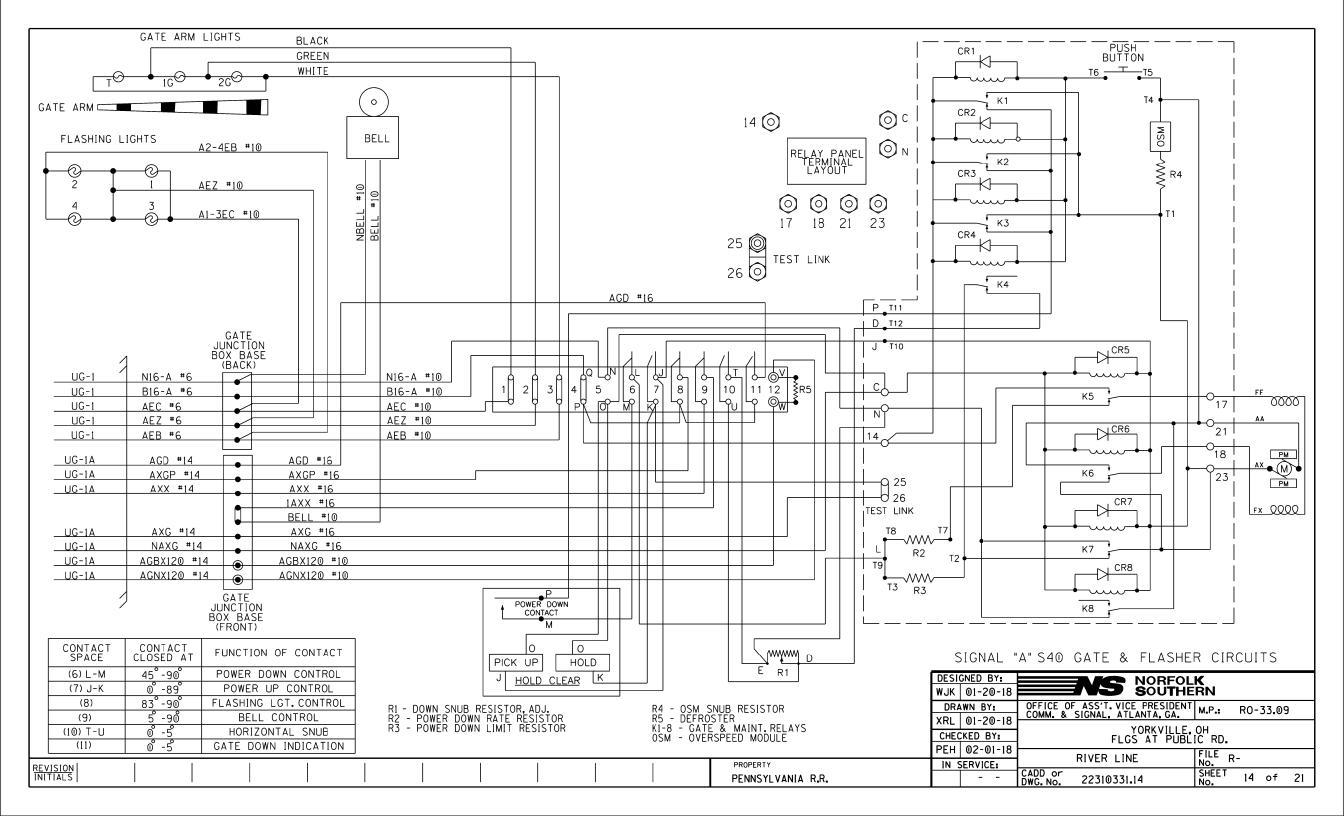



REVISION INITIALS

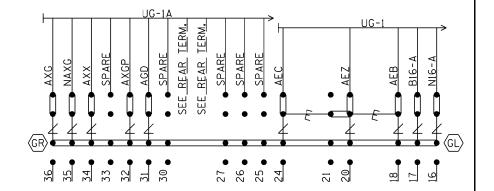

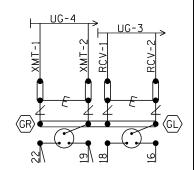


NOTE: INSTALL TEST LINKS ON ALL TRACK WIRES AND ON ALL LOW VOLTAGE UNDERGROUND CABLE TERMINATIONS.

SEE FARADAY SHIELD DETAILS - 1A & 1B FOR HOW THIS PORTION OF THE FARADAY SHIELD IS PREDRILLED. ONLY INSTALL AND USE THE TERMINALS NEEDED.

— = Heavy Duty Equalizer (022700-1X)

Clearview

Z = Lightning Arrester
(022585-1X)

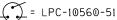

PROPERTY

PENNSYLVANIA R.R.



= TERMINALS GROUNDED TO SHIELD. 4 POST BLOCKS USE EITHER -GR - SERMMI PART NO. 61278 GL - SERMMI PART NO. 61278-1. BACKBOARD 1A & 1B

DACKDOAND IA & ID										
DESIGNED BY: WJK 01-20-18 WJK 01-20-18										
WJK 01-	20-18				OU	THE	RN			
DRAWN	BY:	OFFICE O	F ASS'T.	. VICE	PRES	IDENT	м.Р.:	RO-	33.09	9
XRL 01-	20-18	CUMM. & SIGNAL, AILANIA, GA.								
CHECKED		YORKVILLE, OH FLGS AT PUBLIC RD.								
PEH 02	-01-18		DIVED	LINE			FILE	R-		
IN SERV	ICE:	NO.		• • • • • • • • • • • • • • • • • • • •						
		CADD or DWG.No.	22310	331.15	i		SHEE1	15	of	21

REAR VIEW OF LEFT TWO ROWS TERMINAL BOARD "1B"

REVISION INITIALS SEE PREVIOUS SHEET FOR OTHER WIRES IN CABLE)

NOTE: ALL 120VAC AND ABOVE WILL BE WIRED TO THE REAR OF FARADAY BACKBOARD. INSULATED NUTS MUST BE USED ON ALL TERMINALS.

* = CLOSED DURING WINTER MONTHS


PROPERTY

PENNSYLVANIA R.R.

REAR BACKBOARD 1A & 1B

ĺ	DESI	GNED BY:	NORFOL	K		
	WJK	01-20-18	NORFOL SOUTHE	RN		
	DRA	WN BY:	OFFICE OF ASS'T. VICE PRESIDENT COMM. & SIGNAL, ATLANTA, GA.	M.P.: RO-33.09		
	XRL	01-20-18				
		KED BY:	YORKVILLE, FLGS AT PUBL	IC RD.		
	PEH	02-01-18	RIVER LINE	FILE R-		
	IN SERVICE:			SHEET 10 of 21		
		-	CADD or DWG.No. 22310331.16	No. 16 of 21		

NOTE: IF THE FARADAY SHIELD WOULD EVER NEED TO BE DRILLED IN THE FIELD, PROPER PRECAUTIONS MUST BE TAKEN TO INSURE METAL SHAVINGS DO NOT GET INTO EXISTING TERMINALS/WIRES.

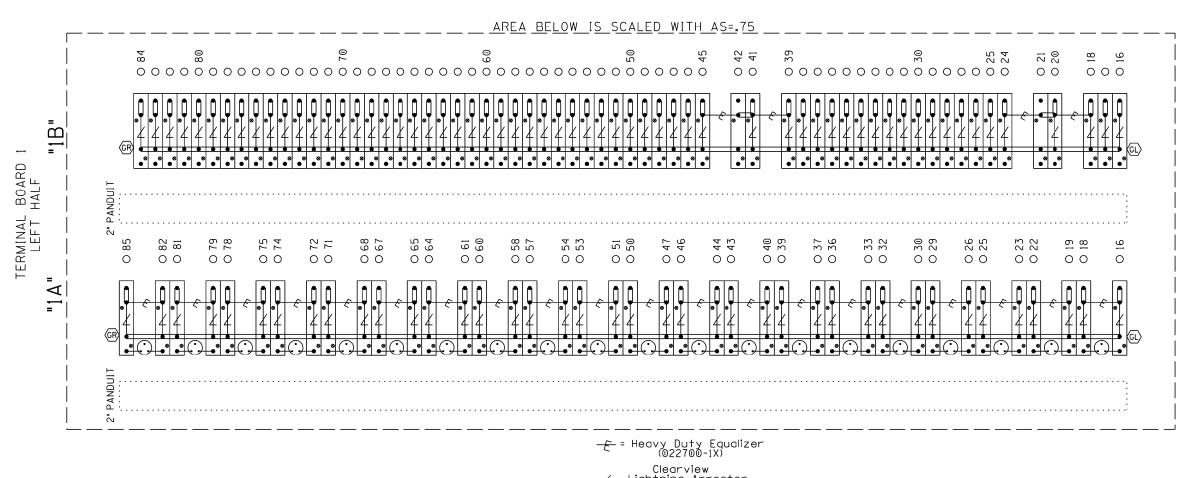

= LPC-10560-51

FARADAY SHIELD 1A & 1B

= INDICATES PLACEMENT OF PANDUIT THIS SHEET IS FOR REFERENCE ONLY, TO REFLECT HOW THE FARADAY SHIELD IS PREDRILLED. ONLY INSTALL AND USE THE TERMINALS NEEDED.



= TERMINALS GROUNDED TO SHIELD. 4 POST BLOCKS USE EITHER -GR - SERMMI PART NO. 61278 GL - SERMMI PART NO. 61278-1.


DESI	GNED BY:	NORFOLK				
WJK	01-20-18	NORFOLK SOUTHERN				
DR/	WN BY:	OFFICE OF ASS'T. VICE PRESIDENT M.P.: RO-33.09				
XRL	01-20-18	-				
CHEC	KED BY:	YORKVILLE, OH FLGS AT PUBLIC RD.				
PEH	02-01-18					
IN S	SERVICE:	RIVER LINE FILE R-				
		CADD or DWG. No. 22310331.17 SHEET 17 of 21				


PROPERTY
PENNSYLVANIA R.R.


REVISION | INITIALS

NOTE: IF THE FARADAY SHIELD WOULD EVER NEED TO BE DRILLED IN THE FIELD, PROPER PRECAUTIONS MUST BE TAKEN TO INSURE METAL SHAVINGS DO NOT GET INTO EXISTING TERMINALS/WIRES. AREA BELOW IS SCALED WITH AS=.75 TERMINAL BOARD RIGHT HALF 000 — = Heavy Duty Equalizer (022700-1X) Clearview

\(= Lightning Arrester
(022585-1X) = LPC-10560-51 FARADAY SHIELD 1C THIS SHEET IS FOR REFERENCE ONLY, DESIGNED BY: NORFOLK SOUTHERN TO REFLECT HOW THE FARADAY SHIELD WJK | 01-20-18 = TERMINALS GROUNDED TO SHIELD. = INDICATES PLACEMENT OFFICE OF ASS'T. VICE PRESIDENT COMM. & SIGNAL, ATLANTA, GA. M.P.: 4 POST BLOCKS USE EITHER -IS PREDRILLED. ONLY INSTALL AND USE DRAWN BY: RO-33.09 OF PANDUIT GR - SERMMI PART NO. 61278 XRL 01-20-18 THE TERMINALS NEEDED. YORKVILLE, OH FLGS AT PUBLIC RD. GL - SERMMI PART NO. 61278-1. CHECKED BY: PEH 02-01-18 FILE R-RIVER LINE IN SERVICE: PROPERTY REVISION INITIALS CADD or DWG. No. SHEET 18 of PENNSYLVANIA R.R. 22310331.18

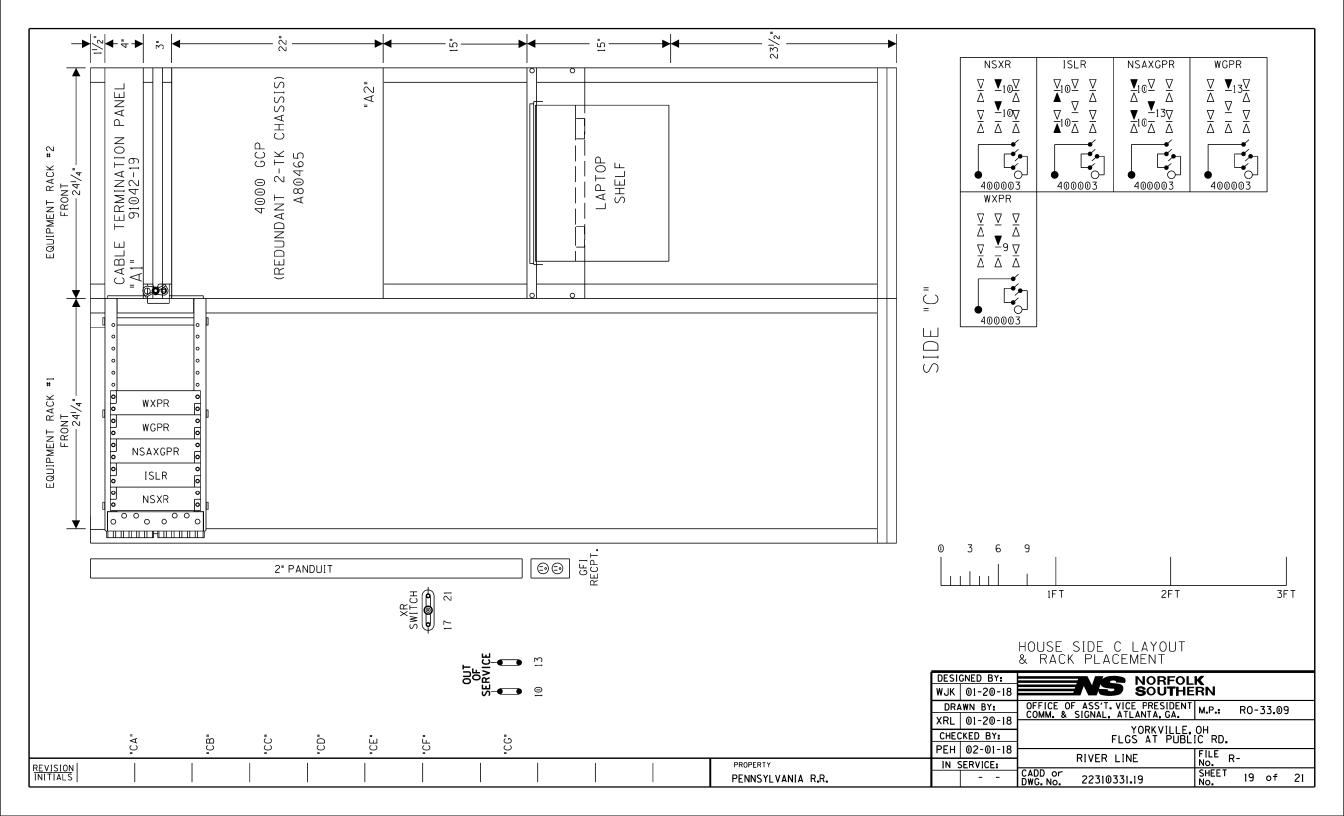

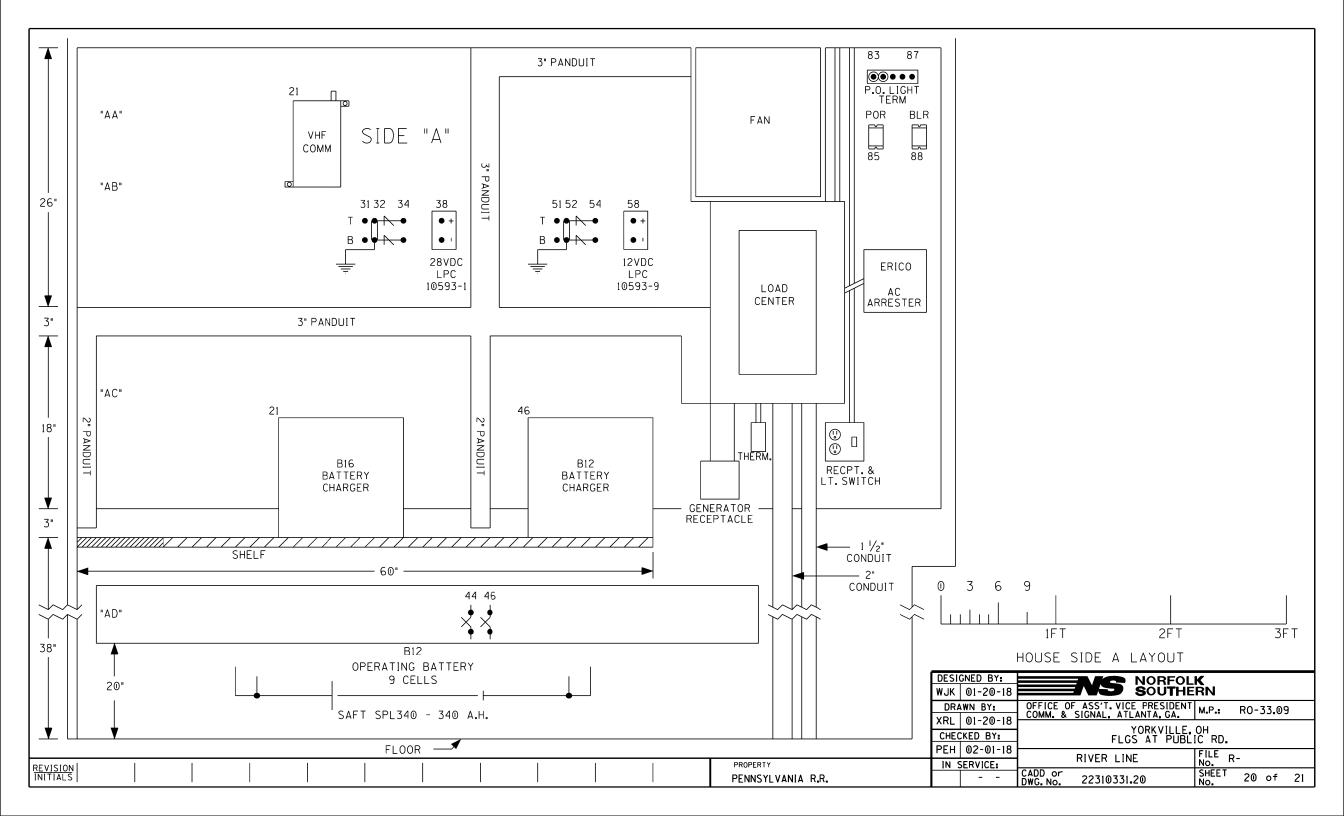

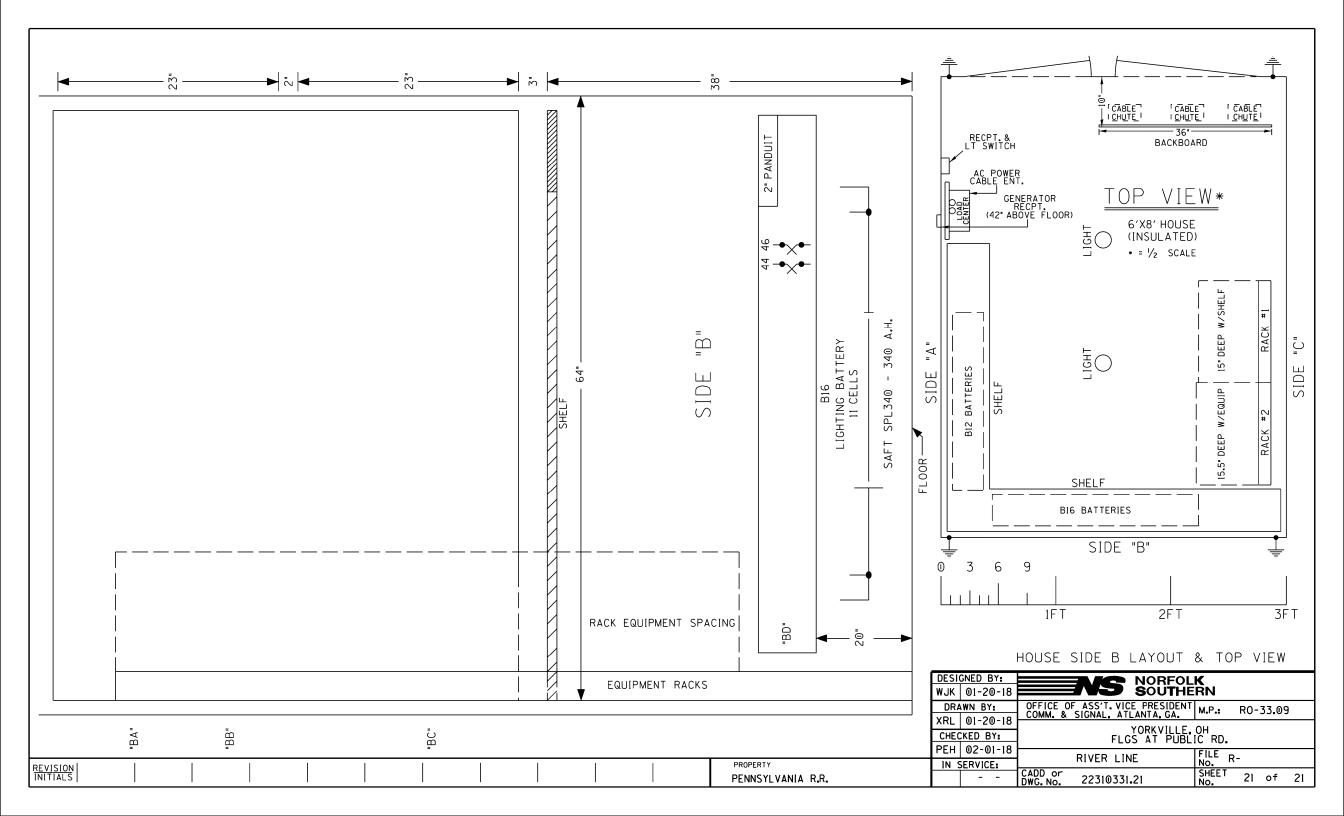

WHEELING & LAKE ERIE RAILWAY COMPANY

Tim Andrews Signal & Communication Supervisor Tel. 330-767-7255

tandrews@wlerwy.com

100 East First Street Brewster, OH 44613 Fax: 330-767-3213

February 21, 2018

Ohio Rail Development Commission Mr. Jim Tucker 1980 West Broad Street, Room 2B Columbus, OH 43223

Re: Estimate for Railroad Crossing Warning System at Public Rd. DOT 473 002U

Dear Mr. Tucker,

I am providing this estimate for the crossing package and installation at Public Rd. Award of the material package will be the result of a competitive bid; copies of the submitted quotes will be forwarded to your office when they are completed. Installation will be performed under our continuing construction agreement with CTC LLC.

Engineering Services, CTC (breakout attached)	\$181,947.64
Fill Materials, transport, hauling	\$5,500.00
Preliminary Installation Services, Crosier	\$21,735.53
Electric Service, Emery	\$3,950.00
Electric Utility fees	\$2,000.00
WLE Direct Signal & MOW Labor	\$5,500.00
Galvanized signal foundations	\$589.00
TOTAL:	\$221,222.17

Please contact me if additional details are required.

Respectfully,

Tim Andrews

Notes: Direct purchase from Fabricated Metals, 60'galvanized gate foundation, \$589.00 ea.

Wheeling & Lake Erie Railway Co. Yorkville, Ohio - Public Rd. DOT# 473 002U Project Estimate - CN16161

ENGINEERING							
Description	Qty	UOM	Unit Price	Amount			
SIGNAL DESIGNER	85	HR	32.69	\$2,778.65			
SIGNAL CHECKER, LEVEL 1	10	HR	39.66	\$396.60			
SIGNAL CHECKER, LEVEL 2/FIELD ENGINEER	5	HR	36.66	\$183.30			
SUBTOTAL				\$3,358.55			
G&A BURDEN FOR LABOR				\$6,146.15			
FIXED FEE				\$950.47			
ENGINEERING TOTAL				\$10,455.17			

PROJECT MANAGEMENT									
Description Qty UOM Unit Price Amount									
SENIOR SIGNAL ENGINEER	25	HR	\$75.48	\$1,887.00					
PROJECT MANAGER	30	HR	\$39.66	\$1,189.80					
CONSTRUCTION MANAGER	40	HR	\$39.66	\$1,586.40					
ACCOUNTING, LEVEL1	16	HR	\$39.81	\$636.96					
ADMINISTRATIVE	6	HR	\$25.48	\$152.88					
SUBTOTAL				\$5,453.04					
G&A BURDEN FOR LABOR				\$8,833.92					
FIXED FEE				\$1,428.70					
PROJECT MANAGEMENT TOTAL				<i>\$15,715.66</i>					

CONSTRUCTION LABOR									
Description Qty UOM Unit Price Amount									
SIGNAL FOREMAN	80	HR	\$29.04	\$2,323.20					
SIGNALMAN	80	HR	\$23.40	\$1,872.00					
SIGNAL HELPER	160	HR	\$19.00	\$3,040.00					
SUBTOTAL				\$7,235.20					
G&A BURDEN FOR LABOR				\$11,721.02					
FIXED FEE				\$1,895.62					
CONSTRUCTION LABOR TOTAL				\$20,851.85					

CONSTRUCTION LABOR EXPENSES									
Description Qty UOM Unit Price Amount									
EMPLOYEE MEALS (PER DIEM)	32	EA	\$30.00		\$960.00				
EMPLOYEE TRAVEL	32	EA	\$60.00		\$1,920.00				
EMPLOYEE LODGING	32	EA	\$70.00		\$2,240.00				
MOBILIZATION	2	EA	\$1,000.00		\$2,000.00				
SUBTOTAL		EA							
CONSTRUCTION LABOR EXPENSES TOTAL					\$7,120.00				

12/6/2017 1

Wheeling & Lake Erie Railway Co. Yorkville, Ohio - Public Rd. DOT# 473 002U Project Estimate - CN16161

CONSTRUCTION EQUIPMENT									
Description Qty UOM Unit Price Amount									
TRUCK, PU, 1 TON CREW CAB	80	HR	\$15.71	\$1,256.80					
TRAILER, UTILITY, 4 TIRE, 12,000lbs SC410	80	HR	\$7.55	\$604.00					
RENTAL EQUIPMENT (FORKLIFT -8K)	1	WK	\$1,400.00	\$1,400.00					
RENTAL EQUIPMENT (BACKHOE)	1	WK	\$1,200.00	\$1,200.00					
EQUIPMENT DELIVERY/PICKUP	4	LS	\$150.00	\$600.00					
SUBTOTAL				\$5,060.80					
CONSTRUCTION EQUIPMENT TOTAL				\$5,060.80					

MATERIAL						
Description	Qty	UOM	Unit Price	Amount		
HOUSE MATERIAL (SEE ATTACHED DETAIL)	1	LS		\$66,779.11		
FIELD MATERIAL (SEE ATTACHED DETAIL)	1	LS		\$25,268.72		
HOUSE AND SIGNAL WIRING	1	LS	\$8,000.00	\$8,000.00		
FILL DIRT (ROAD BASE W/ 3/4" ROCK)		TN	\$28.99	\$0.00		
CONCRETE		YD	\$500.00	\$0.00		
COVER ROCK		TN	\$26.50	\$0.00		
BORING 4"		FT	\$35.00	\$0.00		
ELECTRICAL PERMITS		EA	\$3,500.00	\$0.00		
METER POLE ASSY AND INSTALLATION		EA	\$2,500.00	\$0.00		
FREIGHT & CONTAINER PRICE	1	LS	\$6,000.00	\$6,000.00		
SUBTOTAL				\$106,047.83		
MATERIAL TOTAL				\$106,047.83		

TOTAL PROJECT ESTIMATE	\$165,251.30


12/6/2017 2

HOUSE MATERIALS								
Description	QTY	иом	Unit Price	Total Price				
Bungalow, Alum. 6 X6 w/Heater P/N 91000564 D-1, PTMW	1	EA	\$9,388.00	\$9,388.00				
Wrench, AAR terminal - 11", P/N 032619-9X, Siemens	1	EA	\$43.63	\$43.63				
Label, Brady, Thermal, 2"x0.645" (1000), P/N PS3752WT2, Reynolds	250	EA	\$0.82	\$205.00				
Sensor, Hermetic Door Switch, P/N 70168986, Allied Electric	1	EA	\$4.99	\$4.99				
Actuator, Hermetic Door Switch, P/N 70168991, Allied Electronics		EA	\$1.99	\$1.99				
Sign, Emergency Notification, 30"X30", P/N MUTCD 30x30, Eagle Traffic		EA	\$112.00	\$112.00				
Sign, Emergency Notification, 15"X9" Blue w/Brackets, P/N MUTCD 15x9, Eagle Traffic		EA	\$38.00	\$76.00				
Wire, Case, #16AWG Blue Okonite, P/N 012092-002, GETS	1000		\$0.33	\$330.00				
Wire, Case, #10AWG, Blue Okonite, P/N 152-11-3038, GETS	1000		\$0.53	\$530.00				
Wire, Case, #6AWG THHN, Green, P/N N6GNM, Reynolds	100		\$0.35	\$35.00				
Wire, Case, #6AWG THHN, Black, P/N N6BM, Reynolds	100	_	\$0.35	\$35.00				
Wire, Case, #6AWG THHN, Red, P/N N6RD, Reynolds	100		\$0.35	\$35.00				
MDA-II With Current Sensors DTMF Radio and GFD - Complete, P/N NAS-WLE, NAS		EA EA	\$6,431.00	\$6,431.00				
MDSA-1X Surge arrestor panel, P/N 250204-100, Alstom XP4 Chassis P/N 300752-000, GE **(Populated as shown on Plans)**		EA	\$474.00 \$27,450.00	\$474.00 \$27,450.00				
Cable, XIP 8 ft (cable #1) (need 1 for XP4 Assy) P/N 075046-001, Alstom		EA	\$104.00	\$104.00				
Cable, XIP 8 ft (cable #1) (need 1 for XP4 Assy) P/N 075040-001, Alstom		EA	\$104.00	\$104.00				
XIP-20 w/ Lamp Resistor (1 per IXC-20S) (need 1 for XP4 Assy) P/N 227561-000, Alstom		EA	\$602.00	\$602.00				
Module, 44R, Input/Output, P/N 227538-000, Alstom		EA	\$2,313.00	\$2,313.00				
Module, 44R, Personality, P/N 251379-000, Alstom		EA	\$549.00	\$549.00				
Relay, 500 Ohm, 6PT, Nuetral relay, plug-in, P/N A62-0262, Alstom		EA	\$821.60	\$7,394.40				
Plugboard, Kit (1E/3E test posts) P/N 59686-019-02, Alstom		EA	\$125.00	\$1,125.00				
Wrench, 3E test tool, P/N P03-0320, Alstom		EA	\$51.10	\$51.10				
Extractor Tool, Terminal clip, P/N 032619-25, Siemens		EA	\$1.18	\$1.18				
Relay, 8-pin KRPA style, 10A/12V, P/N 70198611, Allied	4	EA	\$18.62	\$74.48				
Relay, 8-pin KRPA style, 10A/240V, P/N 70198711, Allied	1	EA	\$20.12	\$20.12				
Socket, 8-pin KRPA style, P/N 70199343, Allied	5	EA	\$5.61	\$28.05				
Spring, Hold down for KRPA style relay, P/N 70198576, Allied		EA	\$0.33	\$1.65				
Battery Charger, 40 ETC-12V, RECO 12/40		EA	\$590.00	\$1,180.00				
Battery, NiCad 340 A.H., P/N SPL-340, Saft		EA	\$310.50	\$2,794.50				
Battery, NiCad 250 A.H., P/N SPL-250, Saft		EA	\$225.00	\$2,250.00				
Terminal, Battery, 3-PT, P/N 225481-000, J&A Industries		EA	\$24.25	\$97.00				
Transformer, Chassis Mt, Gate Heater, 115-230V, P/N 038601-T11619, Siemens		EA	\$125.00	\$125.00				
Battery Tray 12'x27", Holds (3) Batteries, P/N 027002-001, J&A		EA	\$48.00	\$192.00				
Nema Plug, Locking, 15 Amp/240V, P/N L6-15P, Reynolds		EA	\$14.50	\$29.00				
Power Indicator, 2 Eye/4 Wire, Wago connector, P/N LC2-001WB-WG4, Velcorp Gems SO Cord, 14 AWG/4 Conductor, P/N SIOOW-14-4-BLK-250R, Graybar	100	EA	\$139.56	\$139.56				
Tie-wrap, 11 1/2", PKG 100, Black, P/N LTS11-0, Vantex		EA	\$0.73 \$20.21	\$73.00 \$60.63				
Tie-wrap, mounting, PKG 100, P/N TYM, Vantex		EA	\$20.21	\$27.44				
Loom, Spiral Wrap, Black 100', P/N SW38-0, Vantex		EA	\$48.54	\$48.54				
Panduit, Wire Duct, 2"X3"X6' Gray, P/N G2X3LG6, Graybar		EA	\$4.61	\$13.83				
Panduit, Cover, 6' Gray, P/N C2LG6, Graybar		EA	\$1.16	\$3.48				
Terminal, Single Row, 12 x 1 w/hardware, P/N 220-0202, Rebel Rail	1000		\$0.27	\$270.00				
Terminal, 4-post, Block Kit, w/ 14-24 AAR Hardware, P/N B2700A2C1WH, Erico	1500		\$0.53	\$795.00				
Connector, 2 3/8", strap style, P/N 220-0507, Rebel	10	EA	\$0.70	\$7.00				
Connector, 1", flat, strap style, P/N 220-0501, Rebel	100	EA	\$0.30	\$30.00				
Arrestor, Air Gap, With Cover, P/N 4000-44585-001X, Siemens	10	EA	\$43.48	\$434.83				
Equalizer, Air Gap, with Cover/Hardware, P/N 4000-44700-001X, Siemens	5	EA	\$19.77	\$98.84				
Binding Nut, P/N 13073-000, Rebel	200		\$0.18	\$36.00				
Clamp Nut, P/N 13079-000, Rebel	100	EA	\$0.14	\$14.00				
Insulated Nut, 1 3/16" , P/N 023408-1X, Safetran		EA	\$4.00	\$56.00				
Washer, P/N 013074-000, Rebel	200		\$0.07	\$14.00				
Gold Test Nut, P/N 13296-001, Rebel	100		\$0.55	\$55.00				
1' Test Link, Flat, P/N 32257-002	100		\$1.75	\$175.00				
Terminal Ring, HD, 1/4", insulated, #14 - #16 (yellow w/blk stripe), P/N NC-10HDB, Vantex	100		\$0.83	\$83.00				
Terminal, Ring, 1/4", insulated #14 - #16 (100 pk), P/N NB14, Vantex		EA	\$29.87	\$59.74				
Terminal, Ring, 1/4" insulated, #10 - #12 (100 pk), P/N NC14, Vantex		EA	\$31.24	\$62.48				
Terminal, Ring, 1/4" insulated, #6, Blue, P/N T6-14N, Vantex		EA	\$0.67	\$20.10				
Terminal, Ring, 3/8" non-insulated, #6, Battery Lug, P/N T6-38, Vantex	15	EA	\$0.97	\$14.55				

FIELD MATERIALS							
Description	QTY	<i>UOM</i>	Unit Price	Total Price			
Cable, 7/C#6, Armored, 206-11-6247, Okonite	200	FT	\$8.11	\$1,622.00			
Cable, 7C#14, Armored, 206-11-6887, Okonite	200	FT	\$2.99	\$598.00			
Cable, 12/C#14, Armored, 206-11-6892, Okonite	200	FT	\$4.86	\$972.00			
Cable, 3C#6, Armored, 206-11-6243, Okonite	150	FT	\$6.00	\$900.00			
Wire, Track, 2C/#6, Twist, Solid, 113-12-3933, Okonite	325	FT	\$1.86	\$604.50			
Tape, Marker - "Buried RR line"/"Buried electrical line"	1	ROLL	\$15.99	\$15.99			
Bootleg Kit, Crossing complete, Wood, 1 Track, CTC Inc.	2	EA	\$500.00	\$1,000.00			
Bondstrand, 3/16", Black, 500', P/N SBS8LINSUL, Erico	500	EA	\$1.22	\$610.00			
Sleeve, 3/16" - #6 solid, P/N A2363J, Erico	100	EA	\$1.29	\$129.00			
Sleeve, 3/16" - 3/16", P/N A2367J, Erico	100	EA	\$1.29	\$129.00			
Clip, Retainer - Spring Steel, P/N A248B, Erico	50	EA	\$3.22	\$161.00			
Staple, Copper, 1 1/2" x 5/16" x 0.144,	50	EA	\$0.38	\$19.00			
Electrical tape, Super 88, Black, 3M	2	EA	\$5.00	\$10.00			
Splicing tape, rubber, 3/4"X30', P/N 130C, 3M	1	EA	\$39.41	\$39.41			
Bond Wire, 7 1/2" XS Style, P/N SBS24883, Erico	100	EA	\$5.12	\$512.00			
Connector, Track, Web of Rail, P/N SBTBBU4A, Erico	100	EA	\$4.63	\$463.00			
Rail Welding Material F80, P/N SB25, Erico	100	EA	\$1.56	\$156.00			
Wheel, grinding, P/N SB22122, Erico	4	EA	\$35.87	\$143.48			
5/8" X 8' Copper Ground Rod P/N 615880. Erico	5	EA	\$9.50	\$47.50			
5/8" Ground Rod Weld, P/N SBNT1161G, Erico	5	EA	\$7.48	\$37.40			
Wire, Ground, #6AWG, Bare Copper, Graybar	100	FT	\$0.34	\$34.00			
FSS-IA, Tunable NBS. P/N 250850-000, GE	2	EA	\$847.00	\$1,694.00			
Shunt Enclosure, Orange, P/N 500-400-100-09-Orange, G&B	2	EA	\$374.00	\$748.00			
Mast, Gate, 18'X5" w/pigtail (single-sided Jct Box), P/N 715-324-2-GS, WCH	1	EA	\$578.00	\$578.00			
Jct box, Gate, 5" single hole w/24 terminals, P/N 2149-A-139, WCH	1	EA	\$492.00	\$492.00			
Gate, Model 3597, P/N 3597-131-R-H-M1 (6 contacts / 115v defroster), WCH	1	EA	\$3,762.00	\$3,762.00			
Resistor, Adjustable, 5 OHM, P/N 1110-7D, WCH	1	EA	\$24.50	\$24.50			
Crossarm Assy, 5" Mtg., 2 Way, P/N 975-0804-5, WCH	1	EA	\$697.00	\$697.00			
Crossarm Assy, 4" Mtg., 1 Way, Flasher, P/N 975-0912-4, WCH	1	EA	\$393.00	\$393.00			
Supporting Bracket & Dowel Mast Assy, 4" Pinnacle/5" Meeting, P/N 3565-267-42-5, WCH	1	EA	\$385.00	\$385.00			
Lights, 12" LED, P/N FLX 4000, Safetran	6	EA	\$247.76	\$1,486.56			
Counterweight Package, 24', P/N 070755-238G, Safetran	1	EA	\$1,356.00	\$1,356.00			
Sign, Crossbuck, No brackets/hardware, P/N 070-0065, Rebel Railway	1	EA	\$84.00	\$84.00			
5" Sign Kit, Brackets/extensions/Ubolts/hardware, P/N 070-5008, Rebel Railway	2	EA	\$56.70	\$113.40			
Wind Bracket, 36", Tusk style, P/N 2010-001-01, RDG	1	EA	\$136.00	\$136.00			
Bell, Electronic, 5" Base, P/N EB-3-360-5, GSI	1	EA	\$165.00	\$165.00			
Gate Keeper, 2-Way, w/Hardware & Buffer Spring, P/N SK-1000-2W, GSI	1	EA	\$1,100.00	\$1,100.00			
E-Z Gate 21'-42' (Vertical) A/F + LED gate lamp kit, P/N 9298-6154, Railway Equipment		EA	\$649.00	\$649.00			
Sleeve, 4' Aluminum, P/N 92958, Railway Equipment	1	EA	\$39.00	\$39.00			
Wrench, Torque (KIT), P/N 2590-K-9, WCH	1	EA	\$191.00	\$191.00			
Field cable Tag Kit, P/N FLDTGKT, CTC Inc.	1	EA	\$171.00	\$171.00			
Emergency Notification Signs, MUTCD, 15" x 9" with 5" mast mounts	1	EA	\$146.32	\$146.32			
Schedule 40 2" & 4" PVC Conduit Kit with Elbows	1	LOT	\$1,500.00	\$1,500.00			
Pull Box, Polymer concrete (30X48X36)w/cover, P/N PHA304836H, Reynolds	1	EA	\$1,100.00	\$1,100.00			
Duct seal, 1lb, P/N 31-601, Graybar	1	EA	\$9.41	\$9.41			
Duct seal, 5lb, P/N 31-605, Graybar	1	EA	\$45.25	\$45.25			
			TOTAL	\$25,268.72			

DWG. NO.	DESCRIPTION
00	INDEX
01	SITE LAYOUT
02	CROSSING SIGNAL ALIGNMENT
03	SITE LAYOUT NOTES
04	XP4/VIO CIRCUITS, TRAFFIC SIGNAL INTERCONNECT
05	CROSSING CONTROL CIRCUITS, NS ADJACENT RR INTERCONNECT
06	XP4 SETUP SHEET
07	TRACK CONNECTION CIRCUITS
08	ENTRANCE GATE CONTROL CIRCUIT
09	RECORDER
10	BCD
11	LAP-G-1
12	СТР
13	GATE #1 MECHANISM (NEAR SIDE)
14	GATE #1 LIGHTS (NEAR SIDE)
15	BATTERY CHARGER
16	AC POWER DISTRIBUTION
17	RACK FRONT VIEW
18	RACK BACK VIEW
19	SIDE "A"
20	SIDE "C"
21	

REV.	GENERAL NOTES
THE OP	ERATION OF THE CIRCUITS AND EQUIPMENT REPRESENTED HEREIN CANNOT BE FULLY CHECKED UNTIL ALL CIRCUITS
AND DEV	ICES ARE CONNECTED TO FORM A COMPLETE SYSTEM, OR AN EFFECTIVE SUBSYSTEM. SUCH SYSTEM OR SUBSYSTEM JUST BE GIVEN COMPLETE CIRCUIT AND OPERATIONAL TESTS BEFORE BEING PLACED IN REGULAR OPERATION.

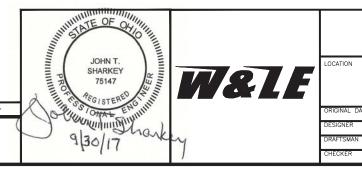


Whooling & Lako Erlo Railway

PUBLIC ROAD (CR 2) YORKVILLE, OHIO

(ORIGINAL DATE	09/07/2017	TITLE	INDEX		
	DESIGNER	CTC	SUB	RIVER	CTC NO.	CN16161
	DRAFTSMAN	CTC	RRMP	15.30	SCALE	N.T.S.
	CHECKER	CTC	DOT NO.	· 473 002U	SHEET	00 of 20

CHANGE FROM TYPICAL: Y

REVISION BLOCK

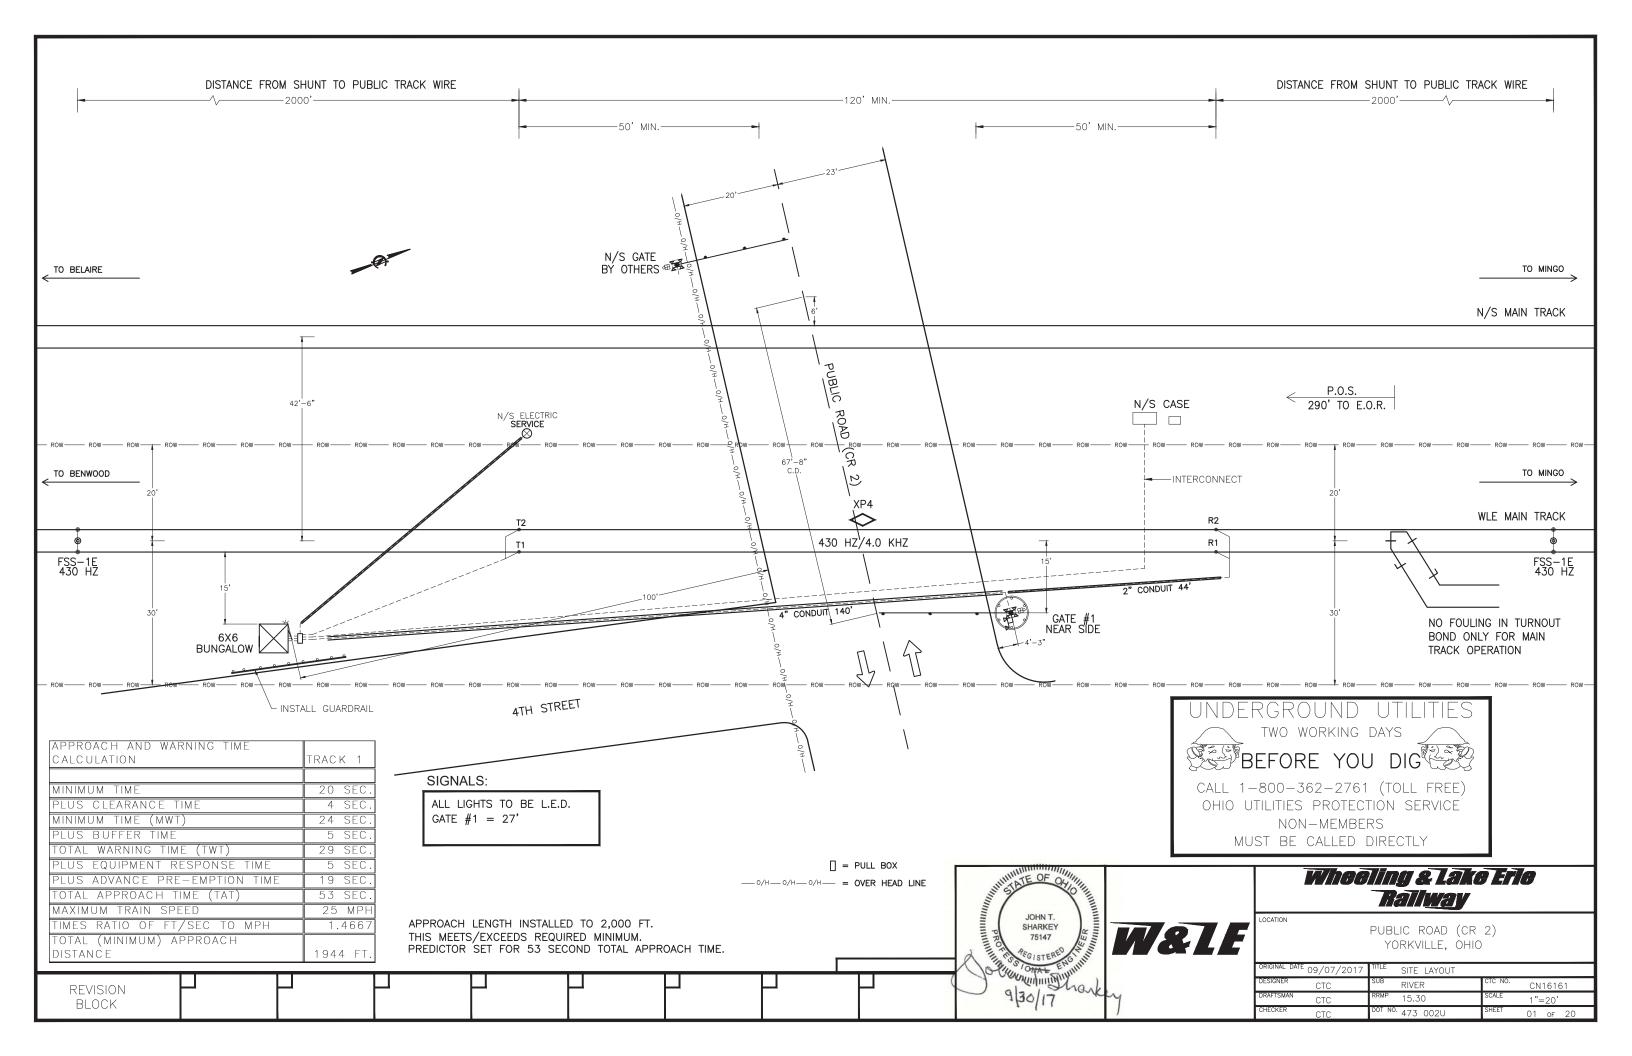

CONSTRUCTION NOTES 1.) INSTALL NEW 6' X 6' BUNGALOW IN SOUTHWEST QUADRANT. 2.) INSTALL (1) NEW FLASHING LIGHTS WITH GATES. 3.) METER POLE LOCATION SHOWN ON THE PLAN IS SUBJECT TO CHANGE WITHIN RAILROAD RIGHT-OF-WAY IF UNDERGROUND OBSTRUCTIONS PREVENT THE INSTALLATION OF THE POLE IN THE LOCATION SHOWN. 4.) BUNGALOW LOCATION SHOWN ON THE PLAN IS SUBJECT TO CHANGE WITHIN RAILROAD RIGHT-OF-WAY IF UNDERGROUND OBSTRUCTIONS PREVENT THE INSTALLATION OF THE BUNGALOW IN THE LOCATION SHOWN. 5.) COORDINATE WITH NORFOLK SOUTHERN TO TERMINATE AND TEST RAILROAD INTERCONNECT CABLE AND CIRCUITRY.

REVISION

BLOCK

ATE OF ON

JOHN T. SHARKEY

9/30/17

THE PROPERTY OF A PROPERTY OF

W&LE

Wheeling & Lake Erle

Rallway

RIVER

DOT NO. 473 002U

^{TE} 09/07/2017

PUBLIC ROAD (CR 2)

YORKVILLE, OHIO

CONSTRUCTION NOTES



REVISION

BLOCK

CROSSING SIGNAL ALIGNMENT

	LEGEND
(A)	GATE #1 FRONT MAST LIGHTS
$^{\otimes}$	GATE #1 BACK MAST LIGHTS
0	GATE #1 AUX. MAST SIDE LIGHTS

ALIGNMENT

FRONT LIGHTS
ADJUST LIGHT UNIT VERTICALLY TO ALIGN AXIS OF BEAM 5FT. 6IN. ABOVE PAVEMENT AT SELECTED ALIGNMENT DISTANCE. BOTH LAMPS SHOULD BE ALIGNED TO SAME POINT.

ADJUST LIGHT UNIT HORIZONTALLY TO ALIGN AXIS OF BEAM TO CENTER OF APPROACH LANE IN APPROACH TO SIGNAL AT SELECTED ALIGNMENT DISTANCE, MAINTAINING VERTICAL ALIGNMENT. BOTH LAMPS SHOULD BE ALIGNED TO SAME POINT.

9/30/17

BACK LIGHTS
ADJUST LIGHT UNIT VERTICALLY TO ALIGN AXIS OF BEAM 5 FT. 6 IN. ABOVE PAVEMENT AT A POINT 50 FT. IN APPROACH TO THE SIGNAL ON OPPOSITE SIDE OF TRACK.

ADJUST LIGHT UNIT HORIZONTALLY TO ALIGN AXIS OF BEAM TO A POINT 50 FT. IN APPROACH TO THE SIGNAL ON OPPOSITE SIDE OF TRACK AND IN CENTER OF APPROACH TRAVEL WAY.

Whooling & Lake Erle Rallway

W&LE

PUBLIC ROAD (CR 2) YORKVILLE, OHIO

ORIGINAL DATE 09/07/2017	TITLE CROSSING SIGNAL ALIGNMEN	١T
DESIGNER CTC	SUB RIVER CTC NO.	CN16161
DRAFTSMAN CTC	RRMP 15.30 SCALE	N.T.S.
CHECKER CTC	DOT NO. 473 002U SHEET	02 of 20


SITE LAYOUT NOTES

1.) CROSSING IS LOCATED: LATITUDE


LONGITUDE

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ELECTRONIC CROSSING BELL GSI MODEL EB-3-360-5

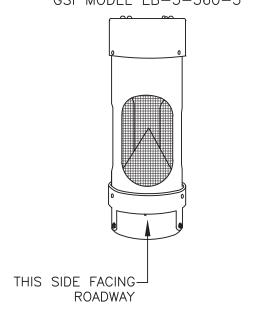


REVISION BLOCK

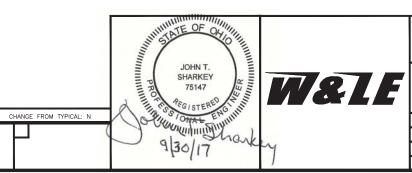


Wheeling & Lake Erle Rallway

PUBLIC ROAD (CR 2) YORKVILLE, OHIO

ORIGINAL DATE 09/07/2017	TITLE SITE LAYOUT NOTE	:S
DESIGNER CTC	SUB RIVER	CN16161
DRAFTSMAN CTC	RRMP 15.30	SCALE N.T.S.
CHECKER CTC	DOT NO. 473 002U	SHEET 03 of 20

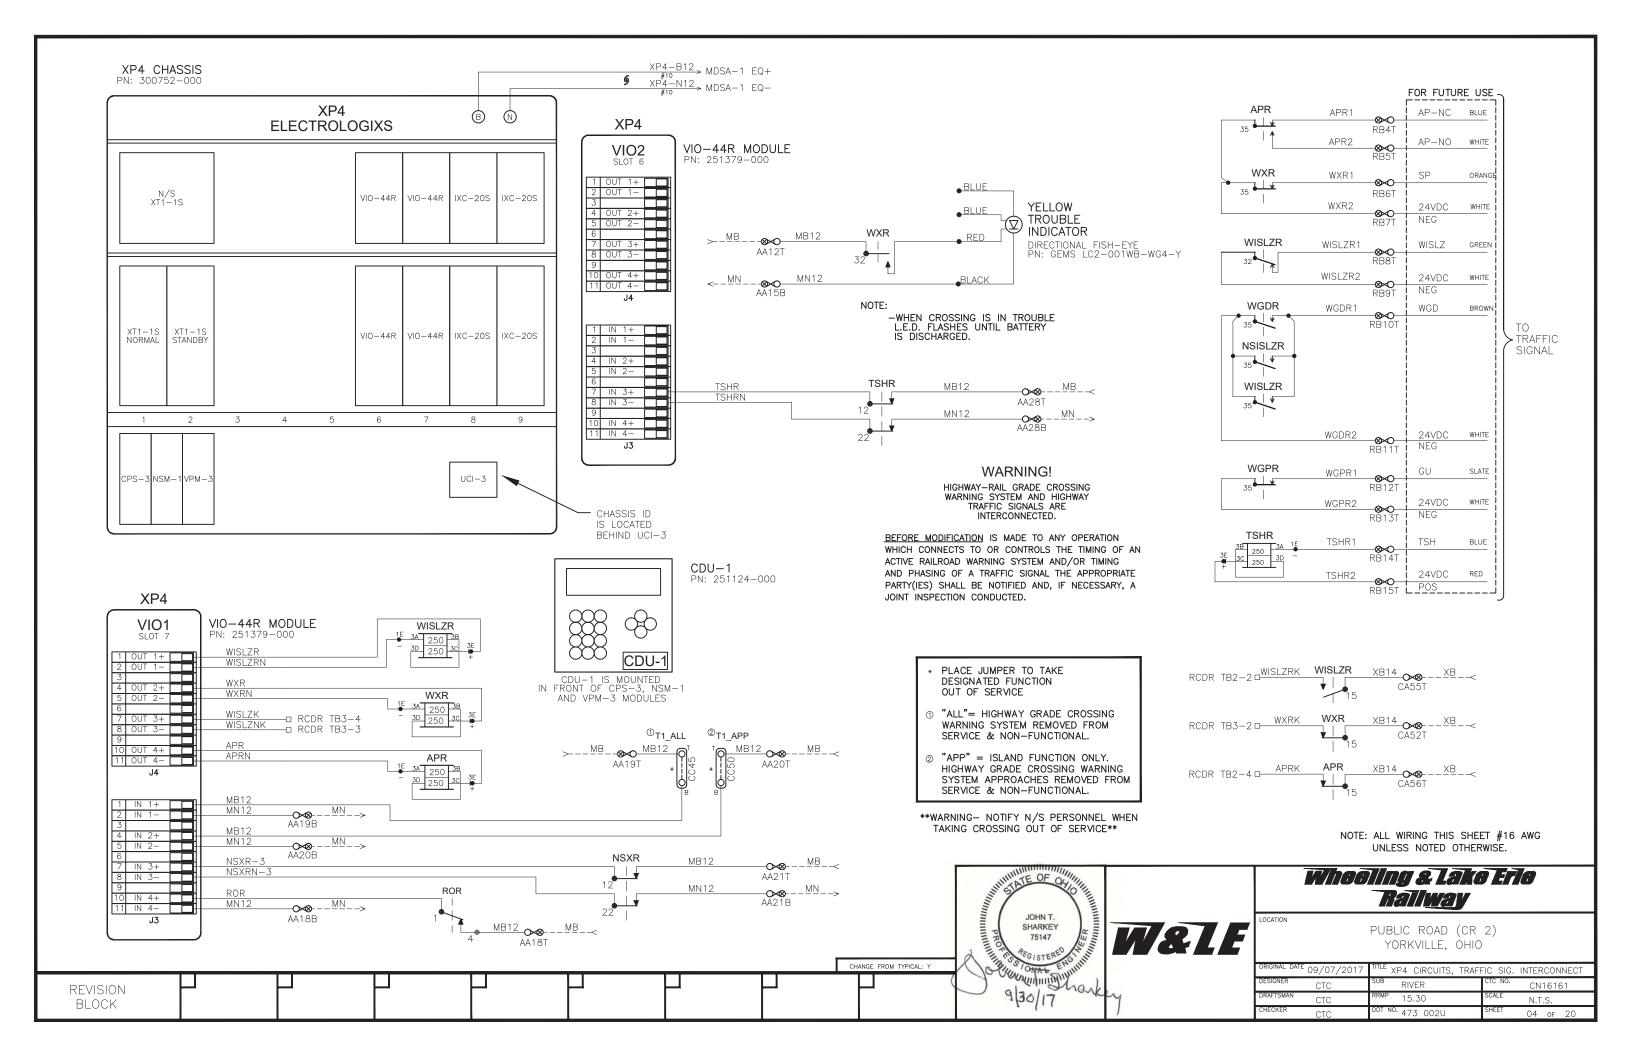

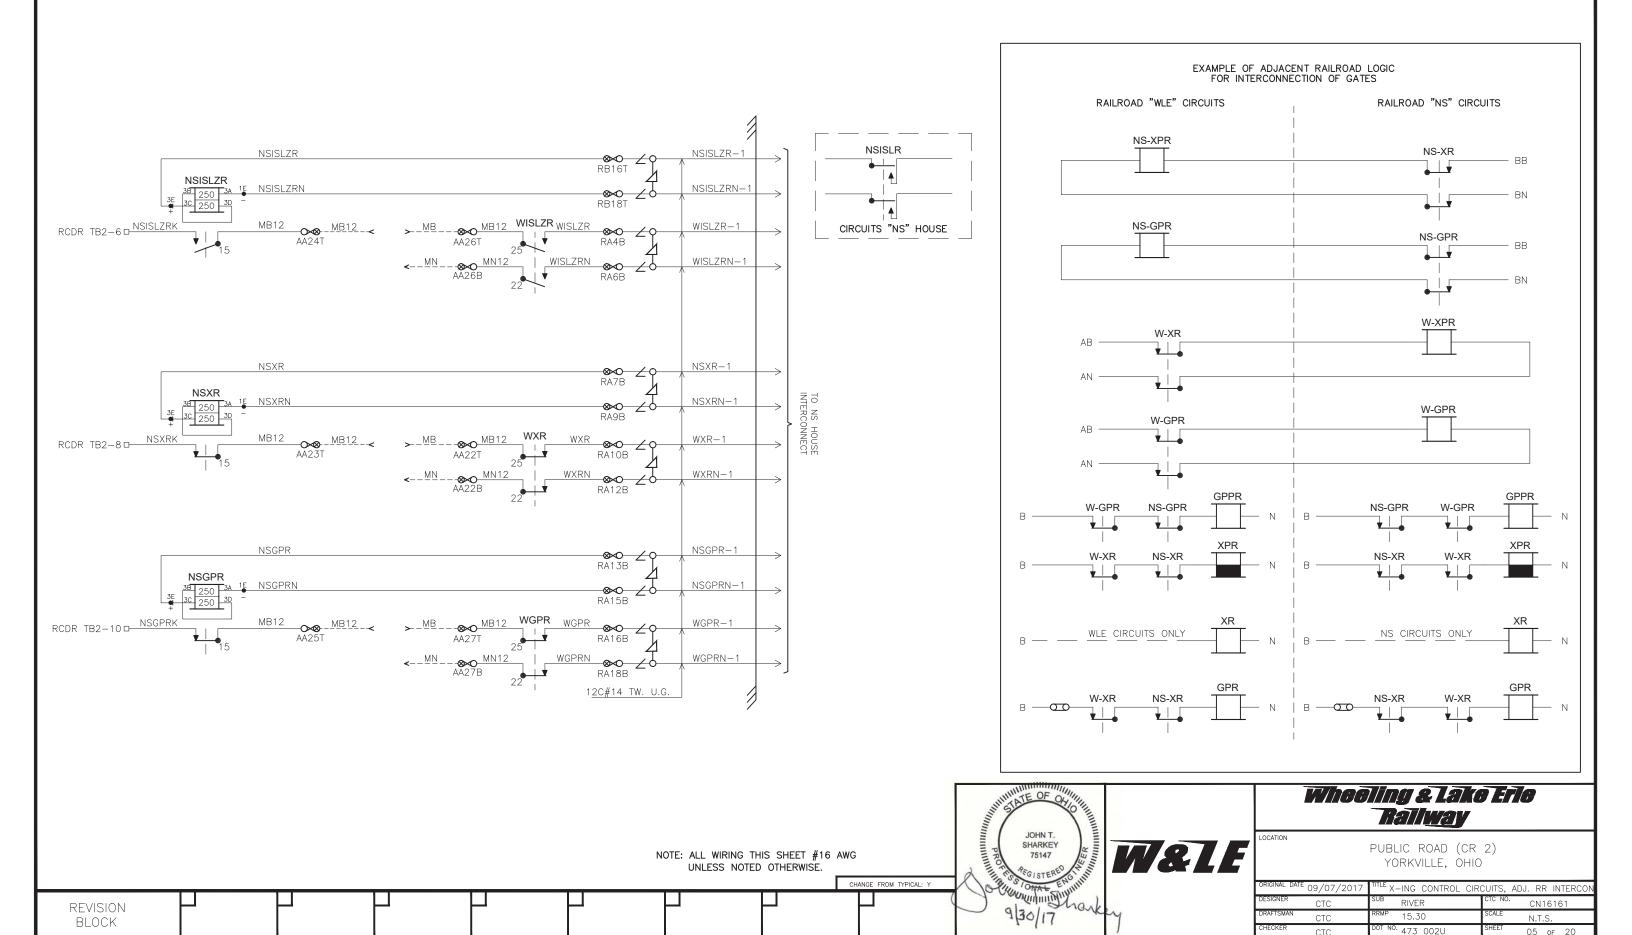

ADJUSTME	ENT NAME	MDR1	MDR1			APT			
NA	ME	HIGHWAY CRO	SSING	HIGHWAY CROSSING					
WARNIN	IG TIME	29 SEC	;	48					
CW	/MD	CW		CW					
AP	TIME	00 SEC	;		00	SEC			
CWE	-WT	00 SEC	;		00	SEC			
AUX RECOV	ERY DELAY	05 SEC	05 SEC		05 SEC				
		TK1 ////////////////////////////////////	7//3///////////////////////////////////	TK1	TK2	TK3	TK4		
TRACK A	ASSIGNED	ASSIGN		ASSIGN					
OFFSET	DISTANCE	0 FT ///////		0 FT					
MD RE	ESTART	* /////////////////////////////////////		*					
SUDDEN S	HUNT ZONE	* (////////////////////////////////////		*					
POSITIVE	PSEN	DISABLE ///////		DISABLE					
START	PSRX	NA /////////		NA					
START	PST	NA /////////		NA					
POST JOINT DETECT	PJEN	DISABLE ////////////////////////////////////		DISABLE					
	PJRX	NA ////////		NA					
	PJDT	NA ////////	///////////////////////////////////////	NA					

BASIC	TRACK SETUP
	TK1 //X////X//3////X///
FREQUENCY	430 HZ
MASTER/SLAVE	MASTER ////////////////////////////////////
RX ADJUST	100 ///////////////////////////////////
TCA	* (////////////////////////////////////
DIRECTION MODE	BI ////////////////////////////////////
LIA	* \////////////////////////////////////
ADVANCED APR. CAL	INACTIVE
NBS COMP RX	* \////////////////////////////////////
TRK ISLAND ASSIGN	ISL1 ////////////////////////////////////
APPROACH LENGTH	2000 FT /////////////////////////////////
AUTO RX	ENABLE ////////////////////////////////////

IXC SETUP						
CROSSING TEST MODE	OFF					
FLASH RATE	55FPM					
	IXC-1 // <i>XX-72</i> // <i>XX-75</i> // <i>XX-74</i>					
VOLTAGE REGULATION	ON ////////////////////////////////////					
L1 VOLTAGE	* 10.0					
L2 VOLTAGE	NA ////////////////////////////////////					
GATE 1 DELAY	3 SEC ///////////////////////////////////					
GATE 2 DELAY	NA ////////////////////////////////////					

A	DVANCED	TRACK SE	ETUP
		TK1	\/X\X\/X\\X\/X\\X\/X\\X\/X\\X\/X\\X\/X\\X\/X\\X\\
MOTION DET TIMER	MDEN	DISABLE	
WOTION BET TIMEN	MDTT	10 MIN	<i>\/////X////X////X/////</i>
	FSEN	DISABLE	
FALSE SHUNT	FSRX	NA	
	FST	NA	
	AREN	DISABLE	
APPROACH RELEASE	ARRX	NA	
	ART	NA	
LOS TIME		16 SEC	
IJ-LOS TIME	IJ-LOS TIME		
NRML_SHHTR_VRSI	HRT	NRML *	

	ISLAND SETUP
	TK1 //X/X///X/X////X/X///
ENABLE/DISABLE	ENABLE ////////////////////////////////////
FREQUENCY	4.0 KHZ
LOSS OF SHUNT	4 SEC ///////////////////////////////////
FAULT DELAY	1 \////////////////////////////////////

BLOCK

IXC SETUP						
CROSSING TEST MODE	OFF					
FLASH RATE	55FPM					
	IXC-1					
VOLTAGE REGULATION	ON ////////////////////////////////////					
L1 VOLTAGE	* 10.0					
L2 VOLTAGE	NA ////////////////////////////////////					
GATE 1 DELAY	3 SEC ///////////////////////////////////					
GATE 2 DELAY	NA ////////////////////////////////////					

SHUNT RECORDS

		T		1	NI RECURDS	I				
APPROACH 1 (EAST)		NO S	SHUNT	100% SHUNT		50% SHUNT			LIA ADDED	
		RX	PHASE	RX	PHASE		RX	PHASE	± 1 to ±9	
Track 1	Normal									
II dek	Standby									
 	Normal									
	Standby/									
	ROACH 2 WEST)									
Track 1	Normal									
Irack I	Standby									
X+30X/3///	Normal									
	Standby/									
			11	NITIAL VALUES W	HEN PLACED IN	SERVICE				

CHANGE FROM TYPICAL: Y

NOTES: * = FIELD ADJUSTMENT NA = NOT APPLICABLE REVISION

Rallway W&LE

ATE OF ON

JOHN T. SHARKEY 75147

PUBLIC ROAD (CR 2) YORKVILLE, OHIO

ORIGINAL DATE 09/07/2017	TITLE XP4 SETUP SHEET	-
DESIGNER CTC	SUB RIVER	CN16161
DRAFTSMAN CTC	RRMP 15.30	SCALE N.T.S.
CHECKER CTC	DOT NO. 473 002U	SHEET 0.6 OF 20

Wheeling & Lake Erle

APPLICATION SOFTWARE INFORMATION


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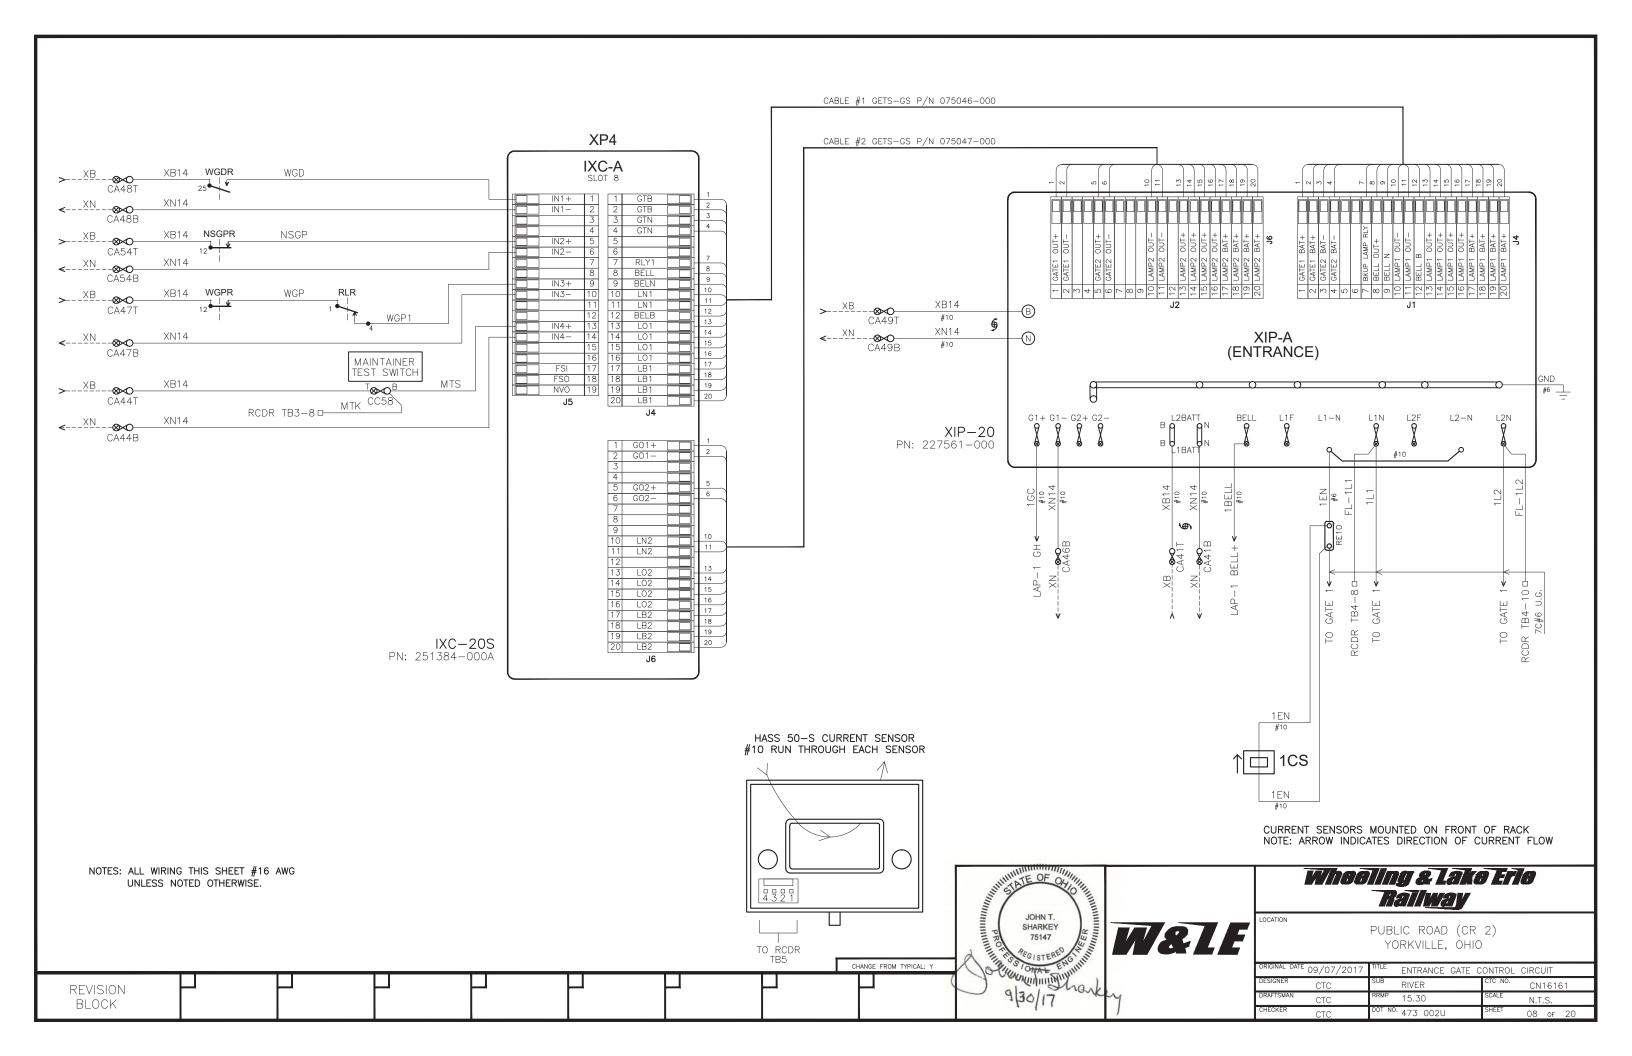
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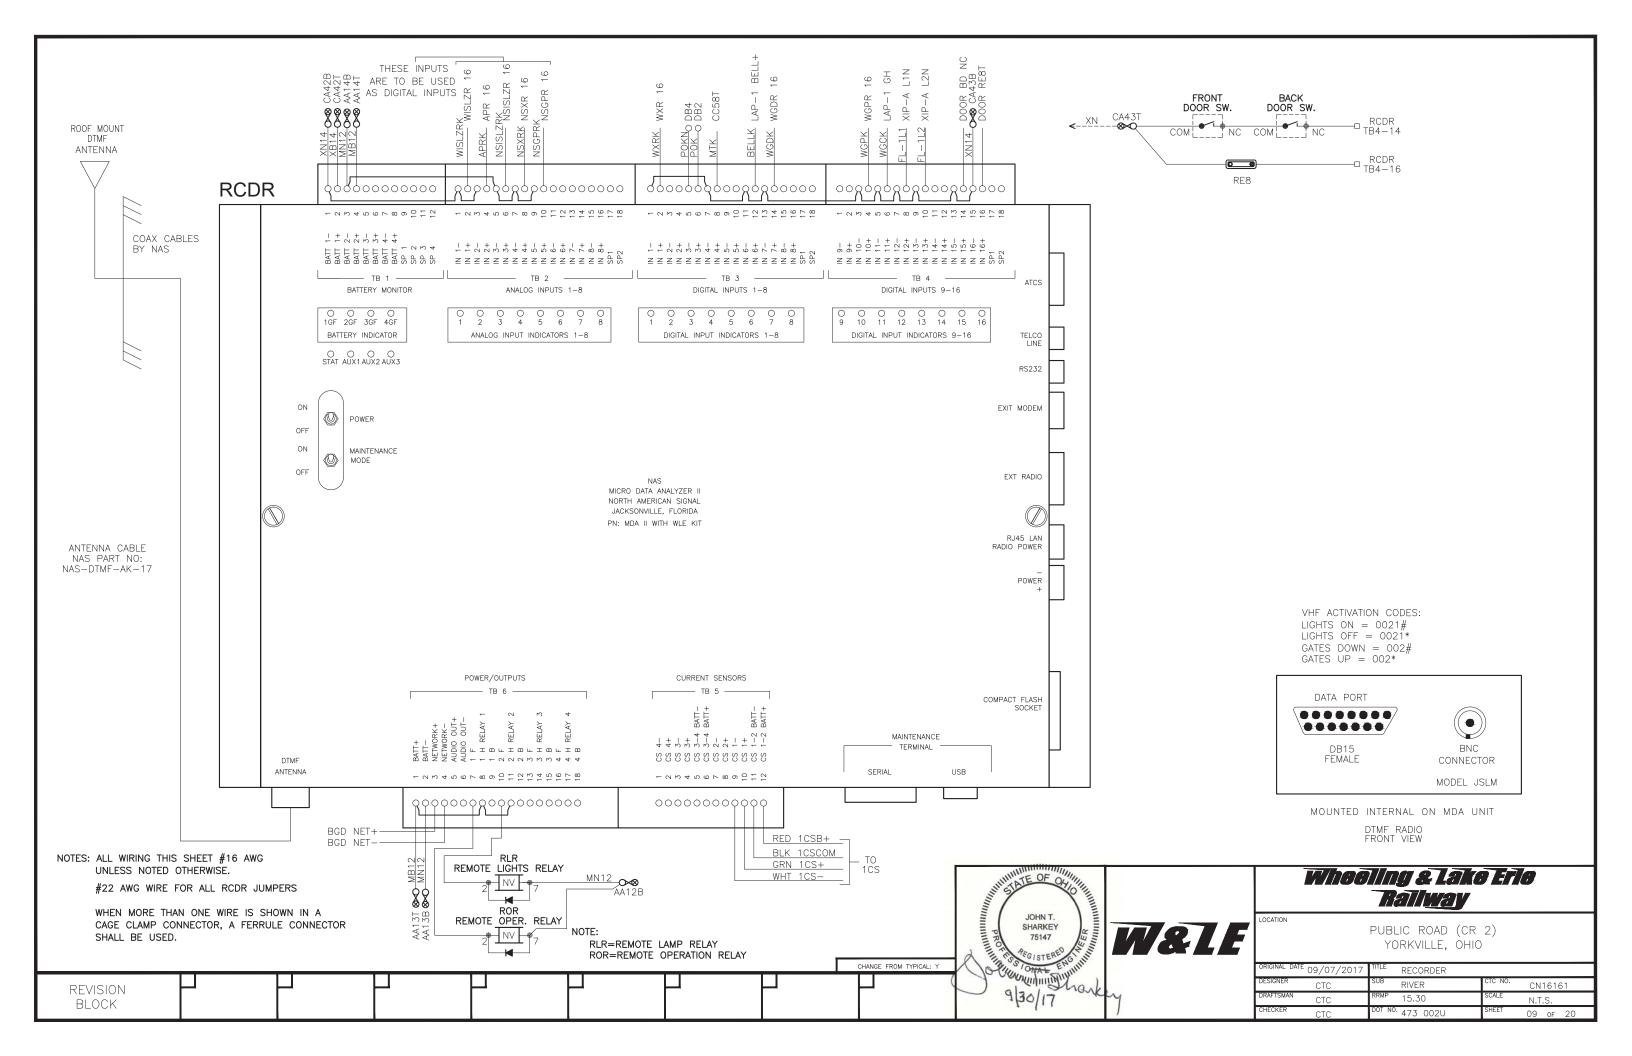
NAME REV. CHECKSUM CRC CHASSIS ID


LOCATED BEHIND UCI-3


EXECUTIVE INFORMATION VPM-3 VERSION PART NUMBER
CROSSING SOFTWARE * 083024-716







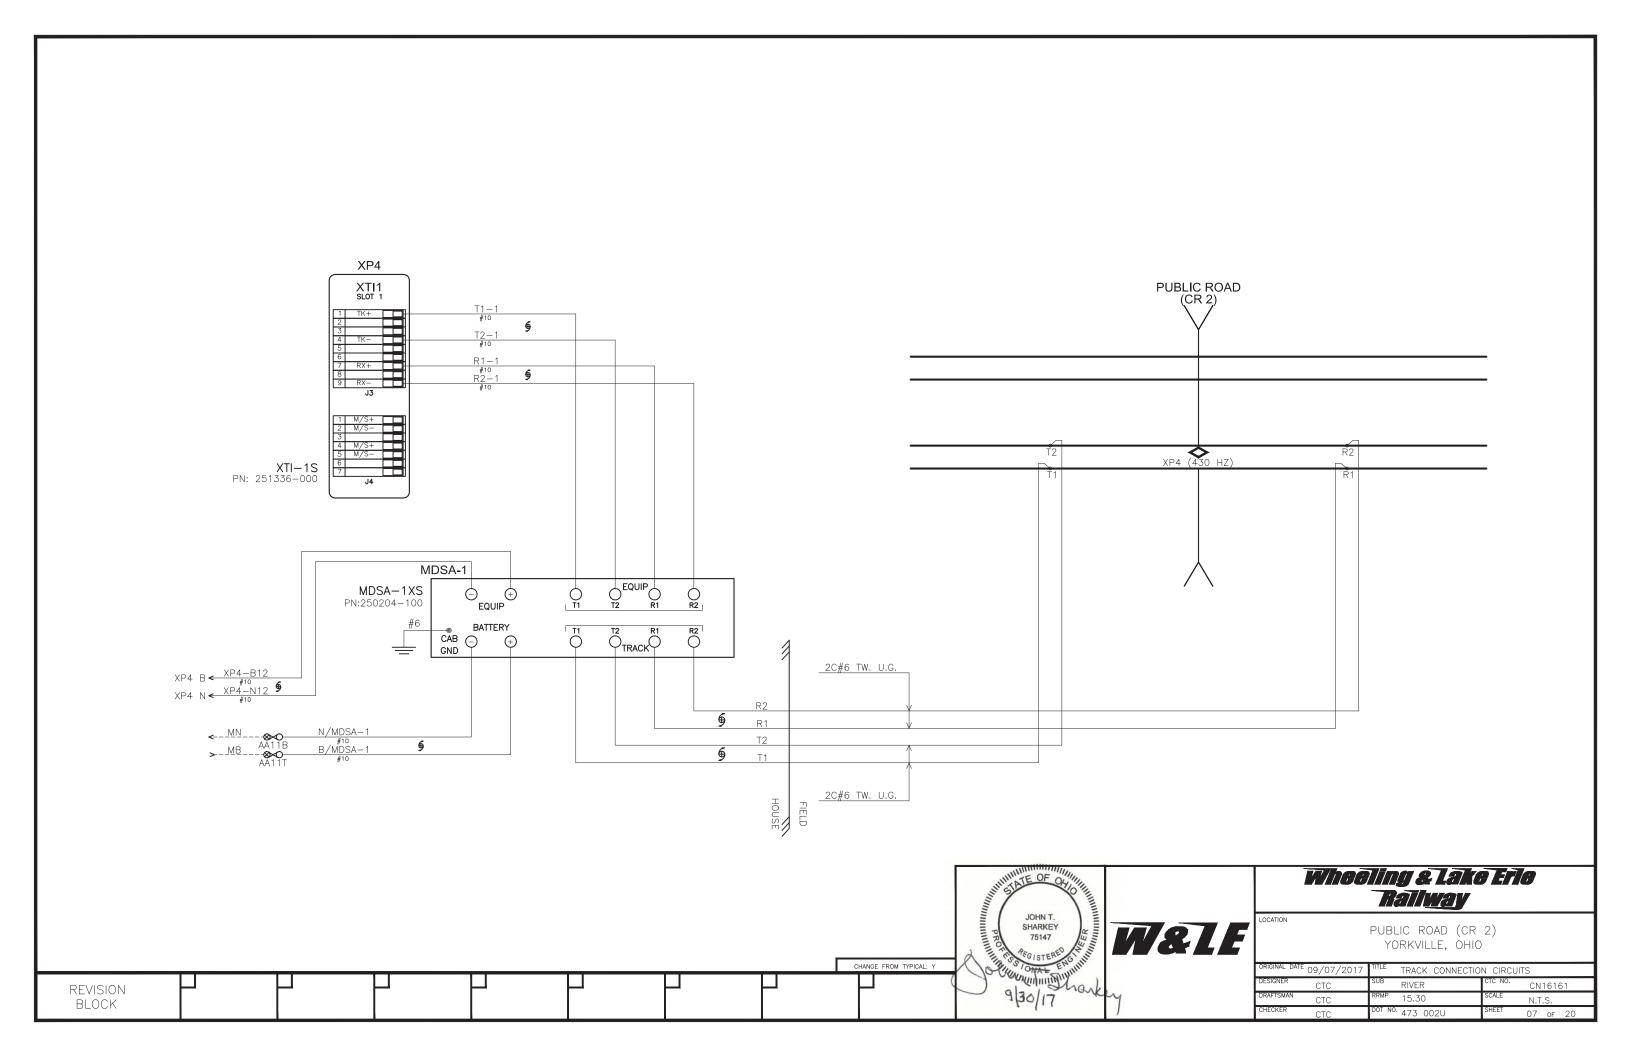


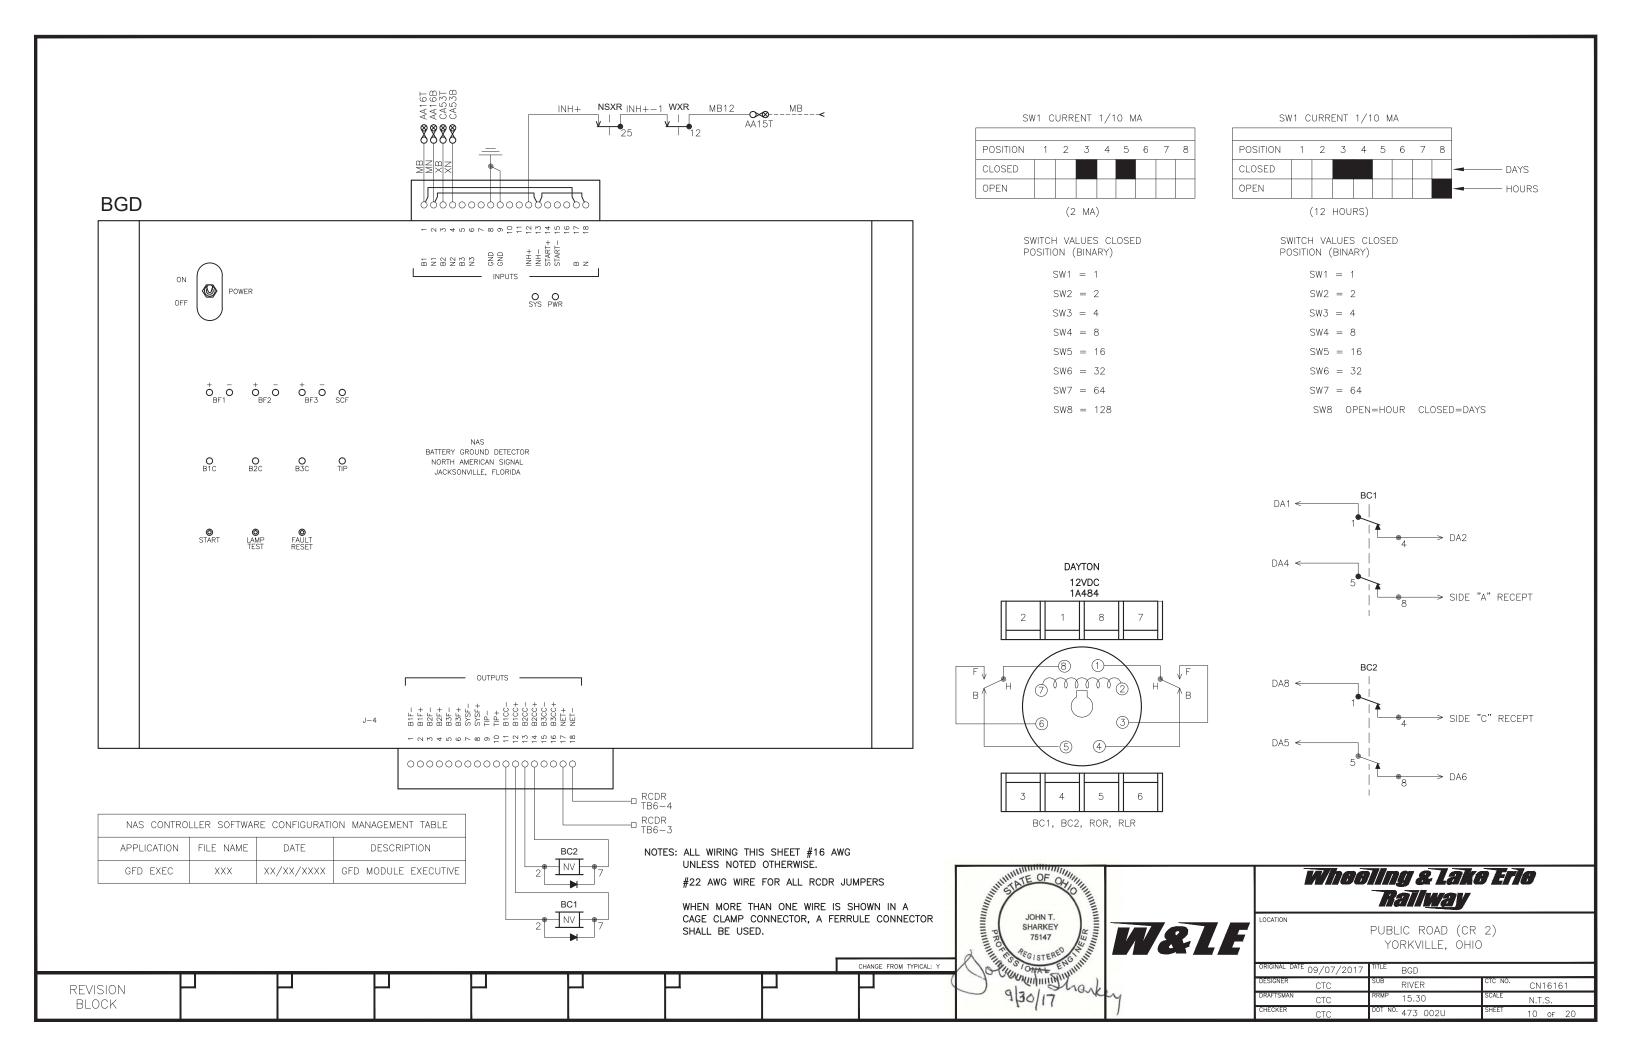


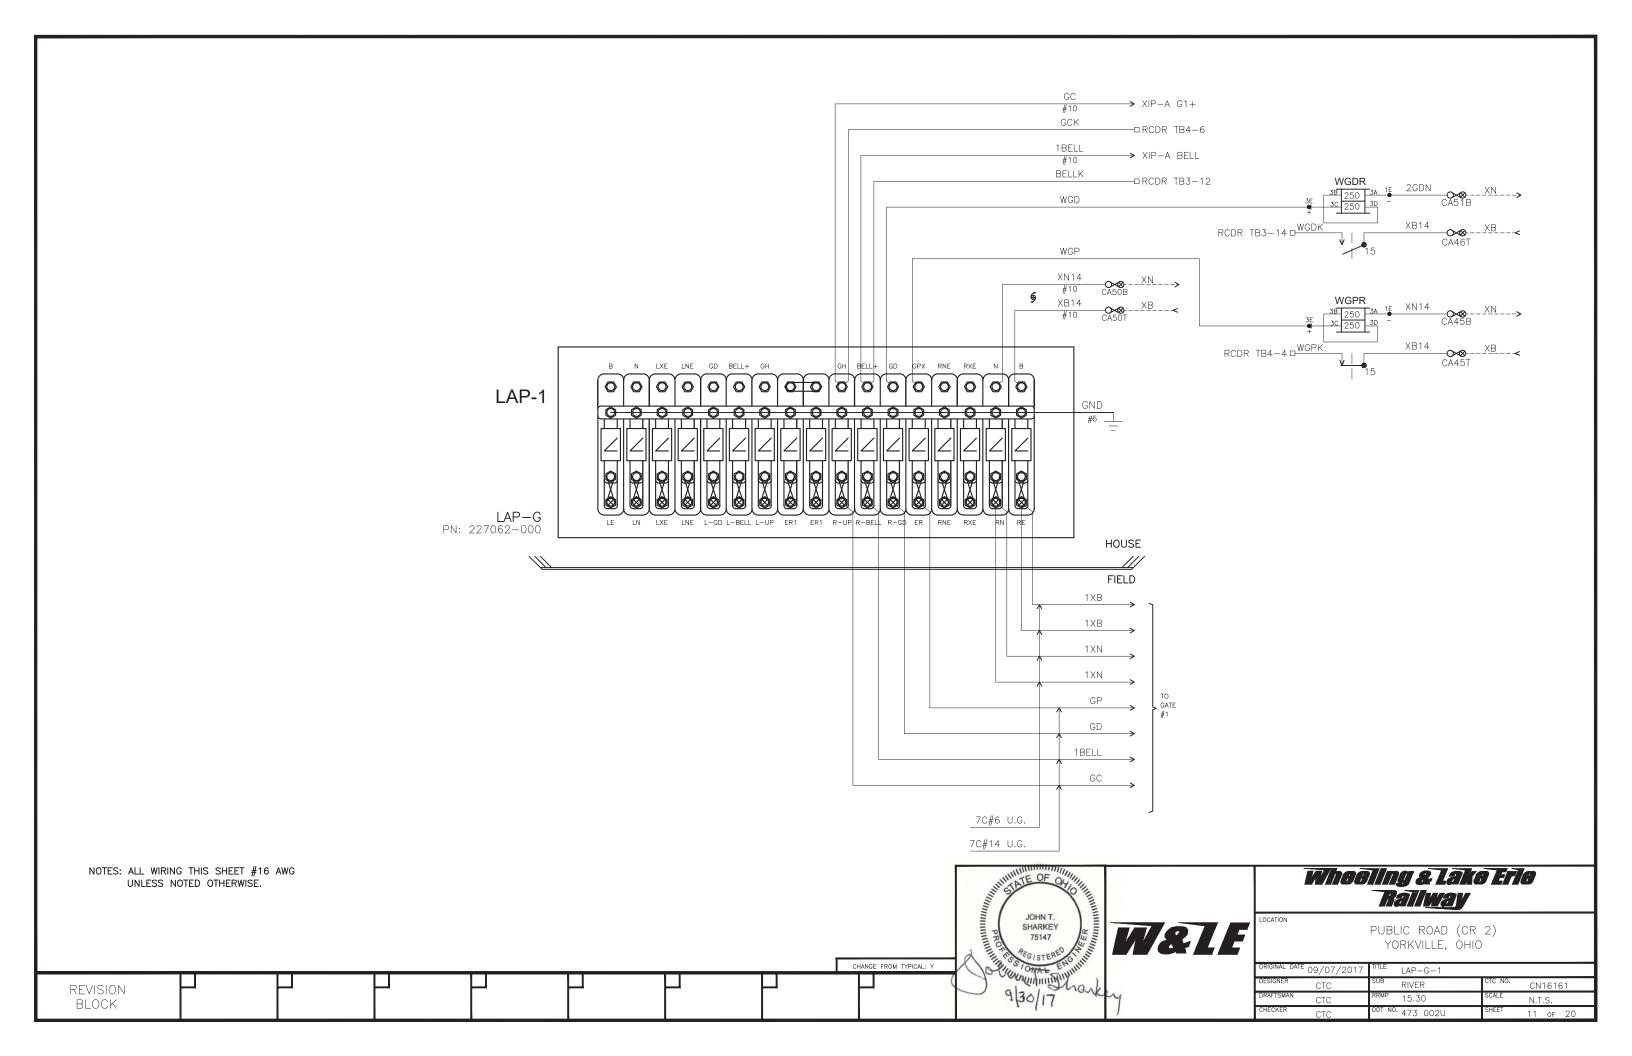


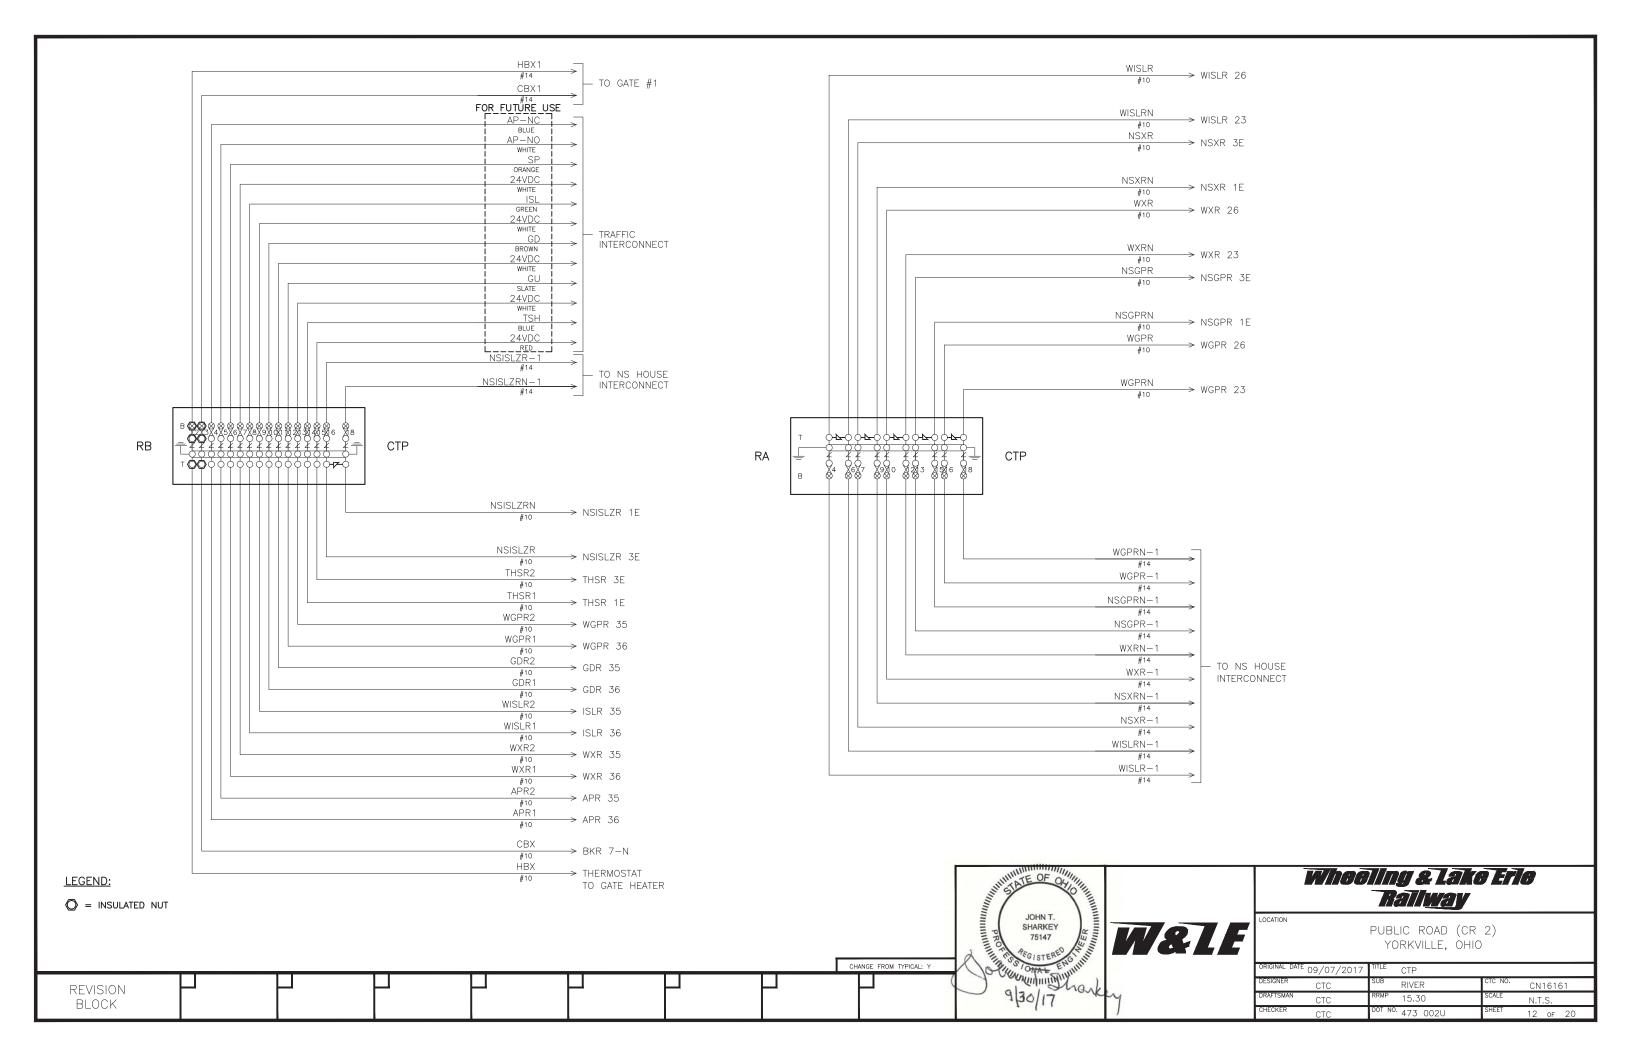


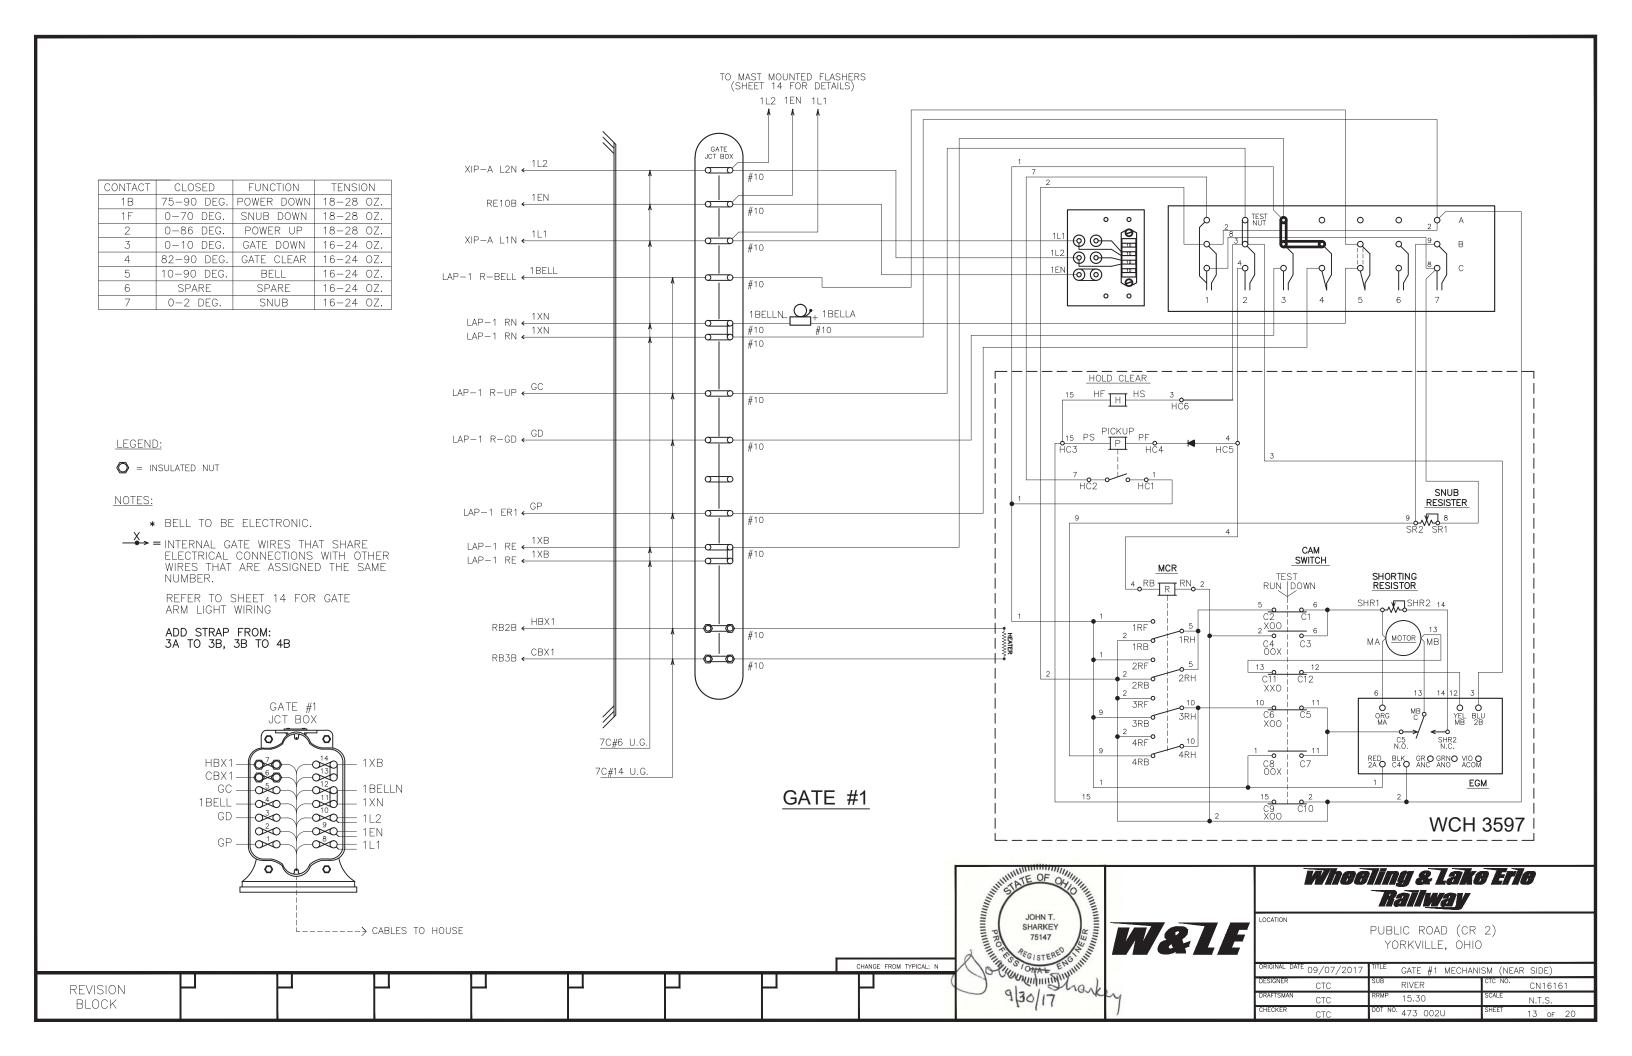


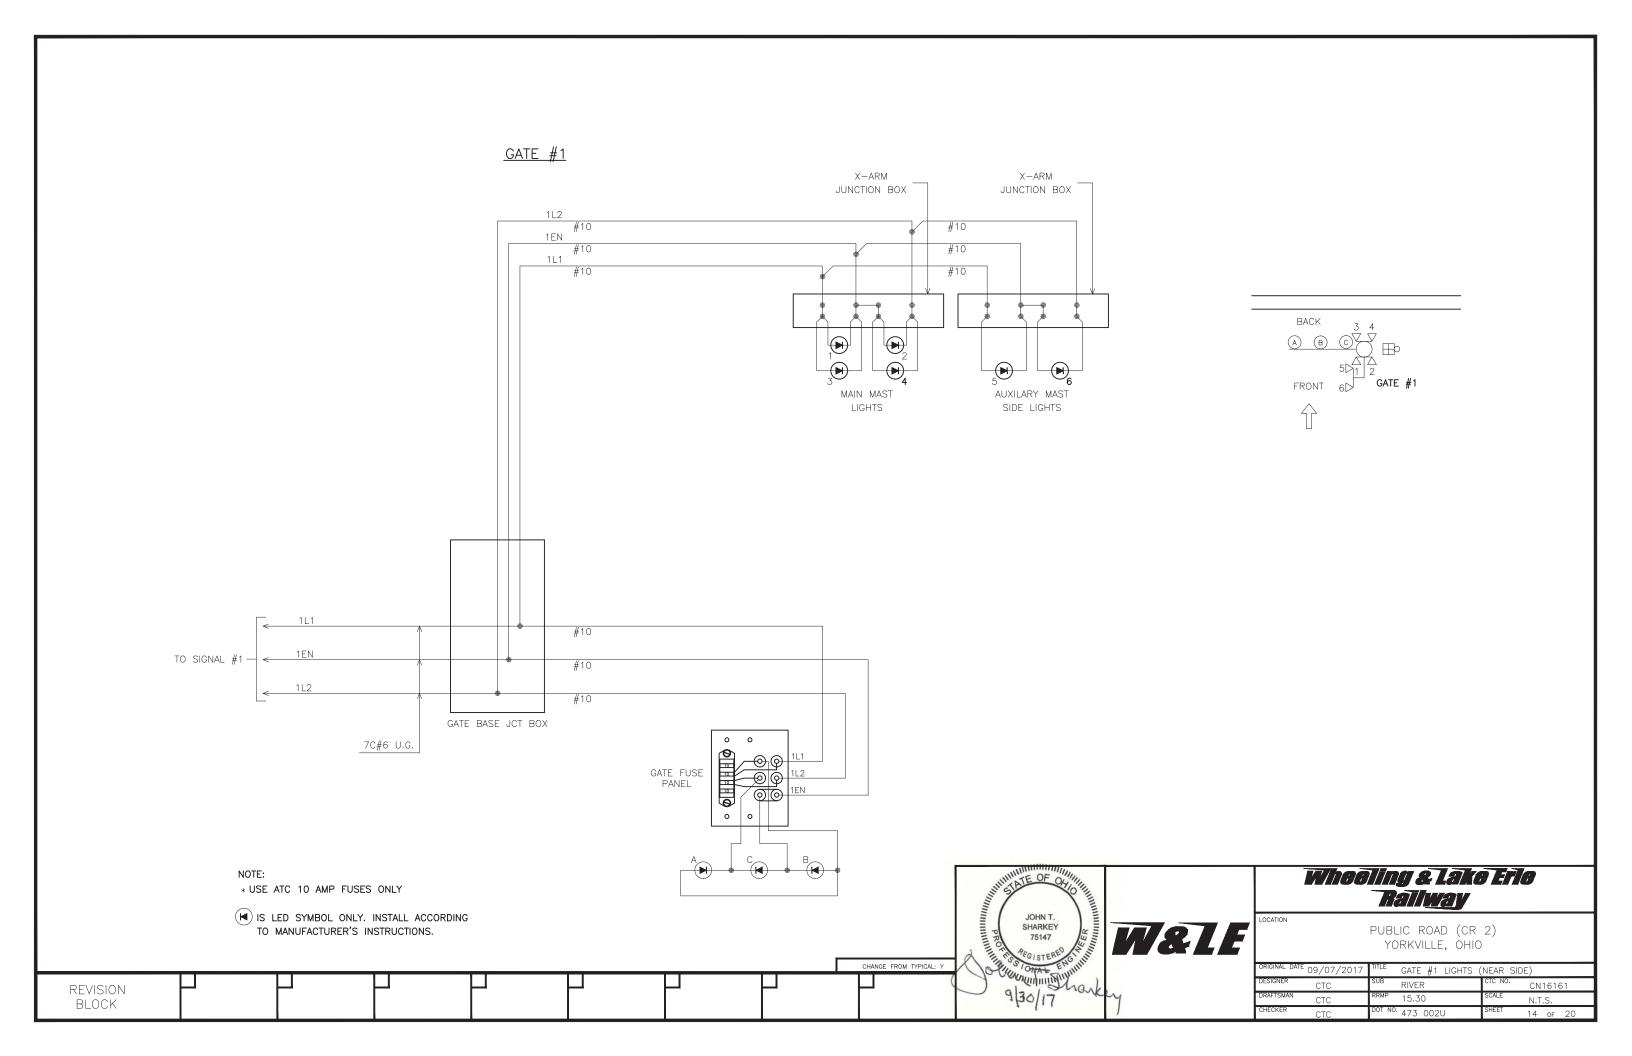


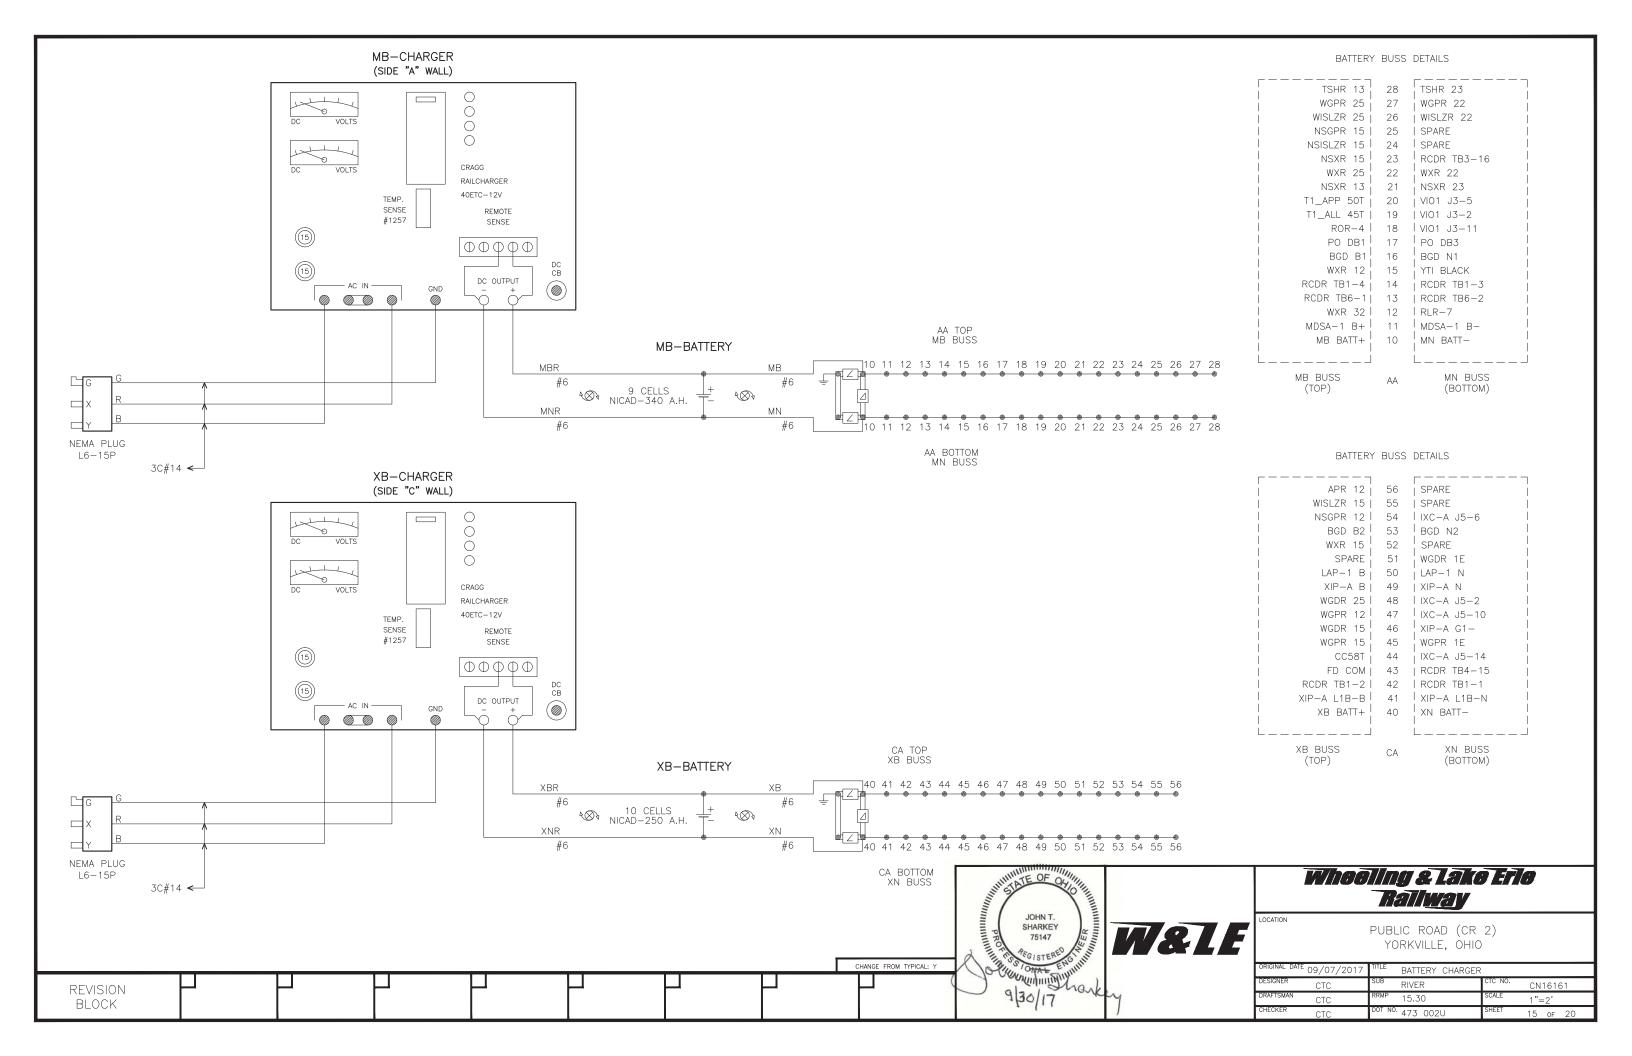


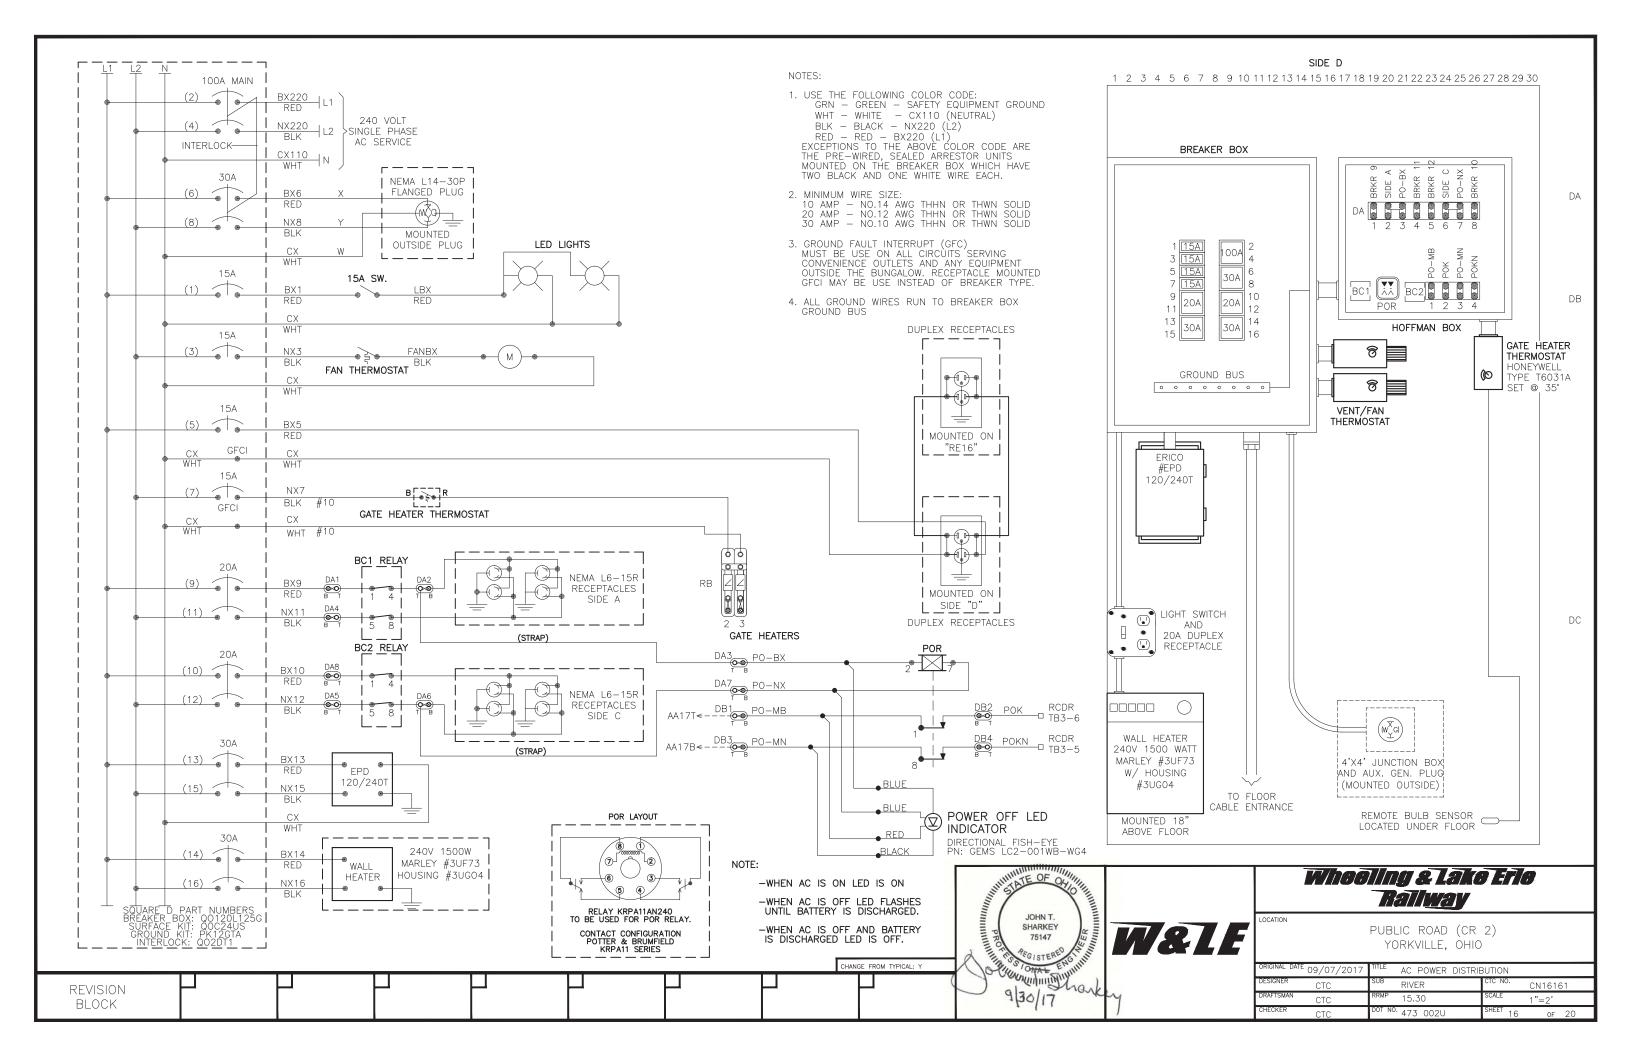


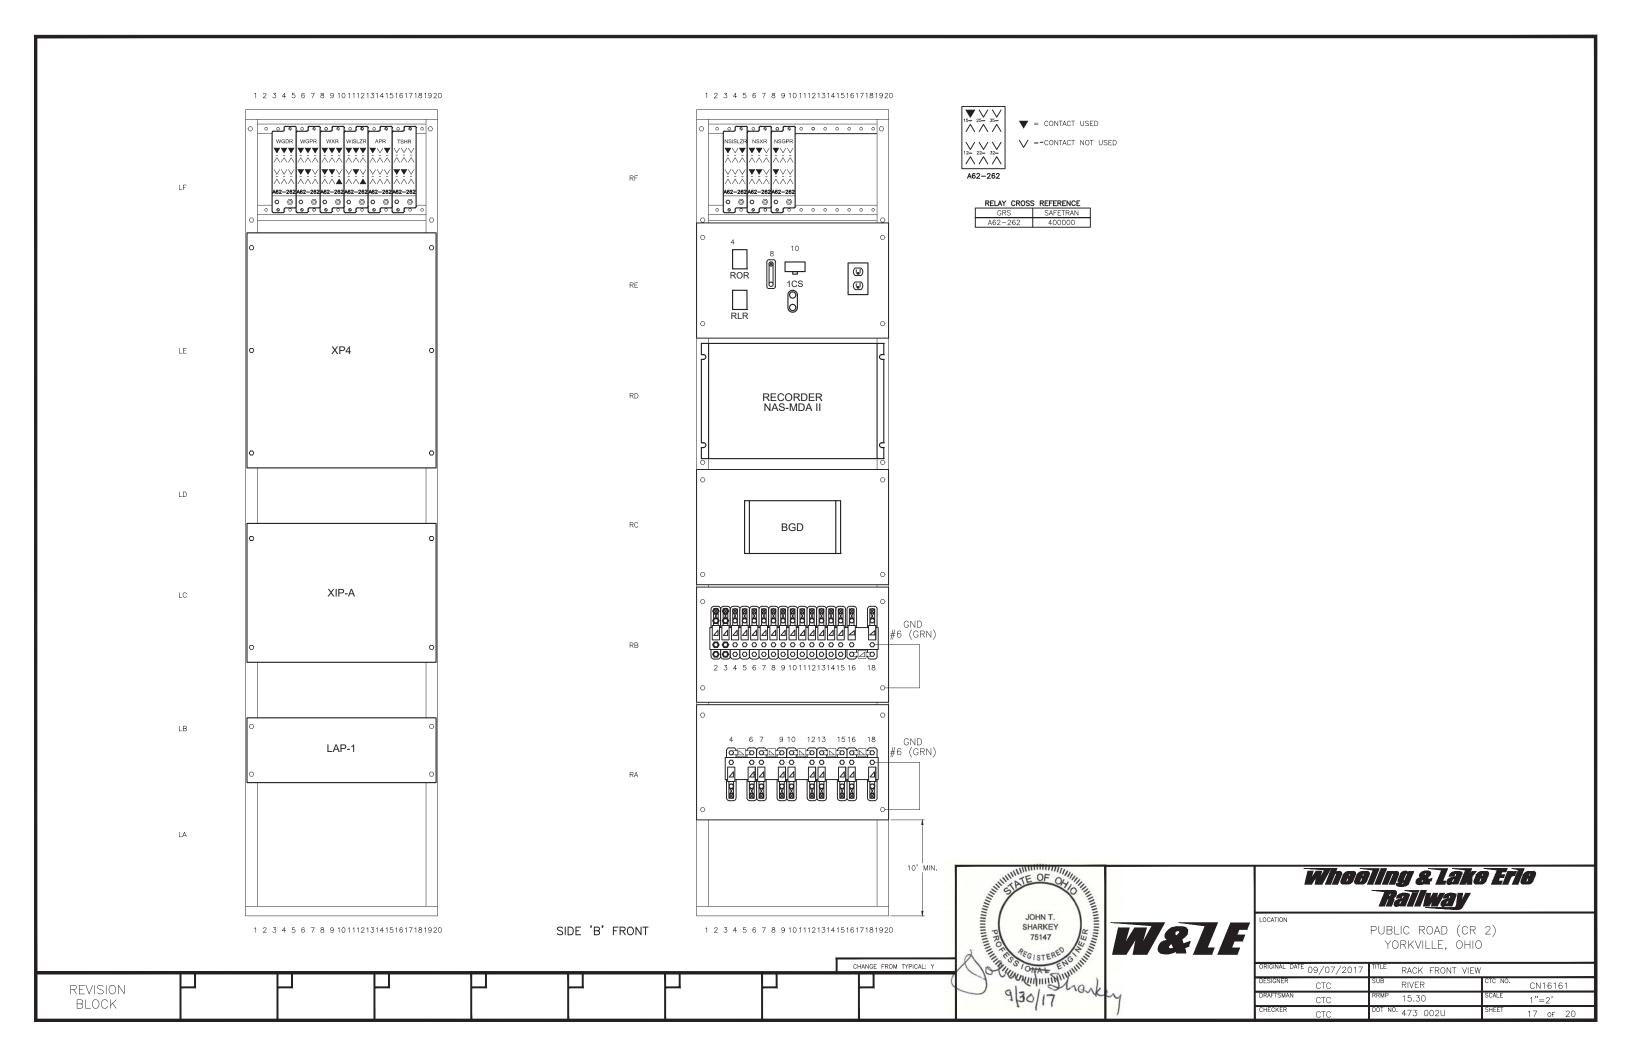

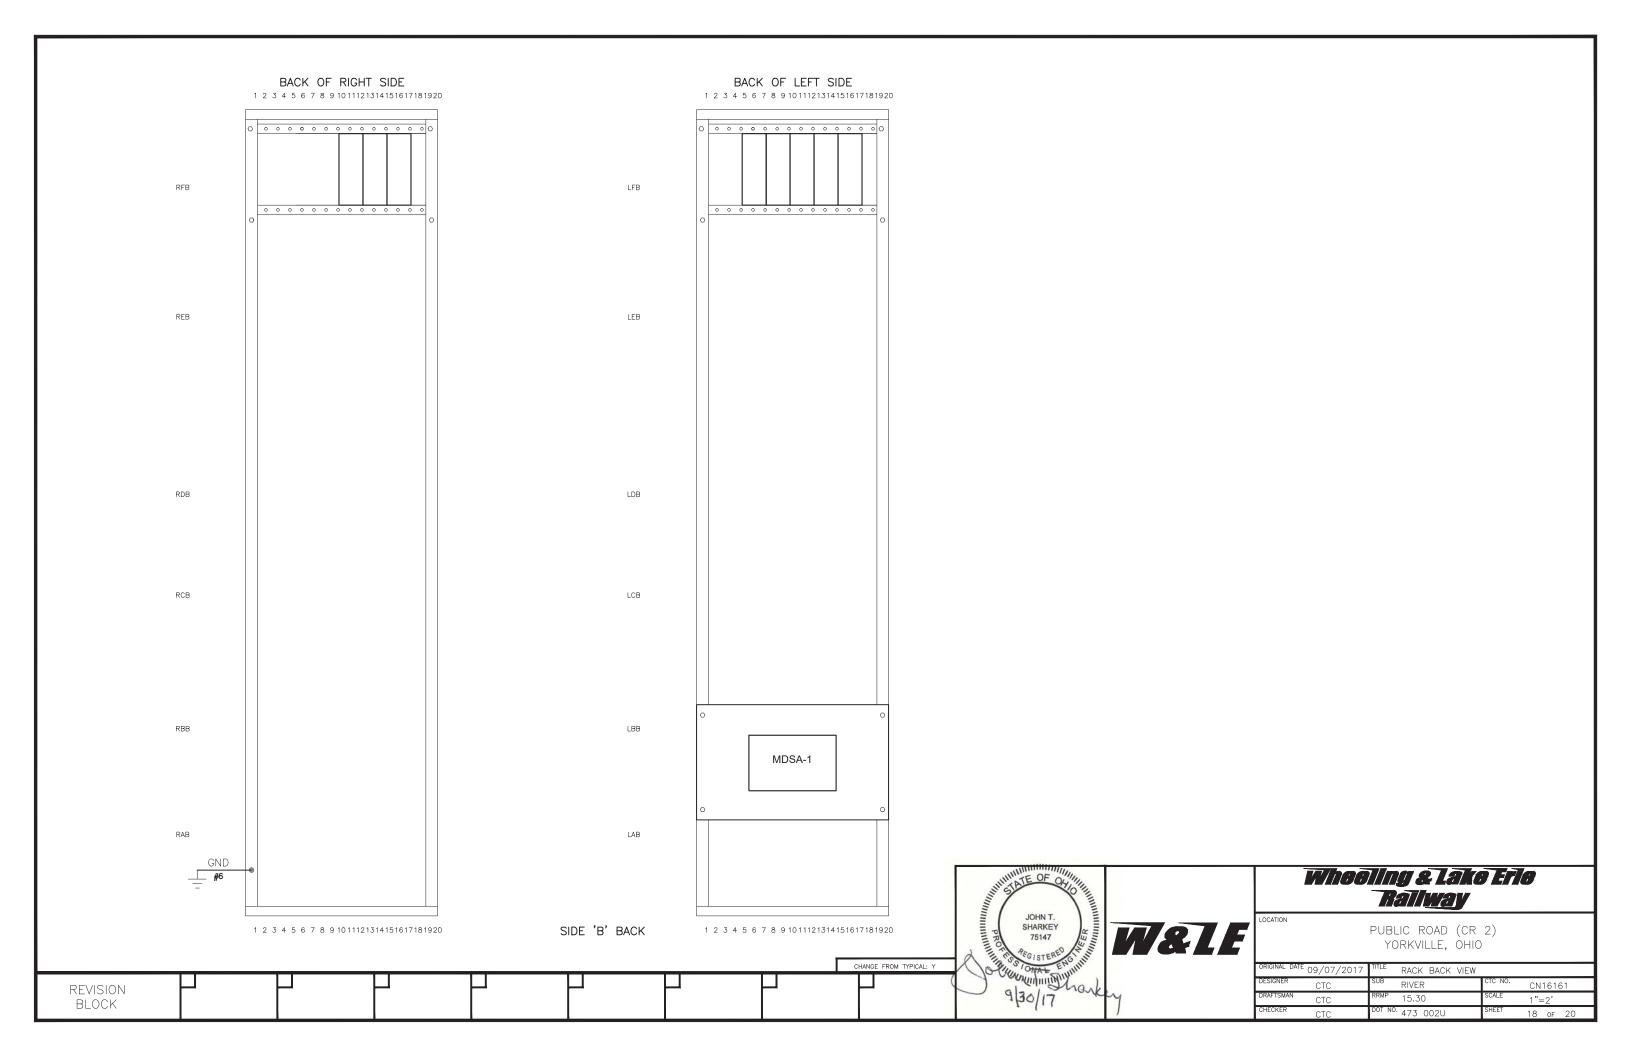

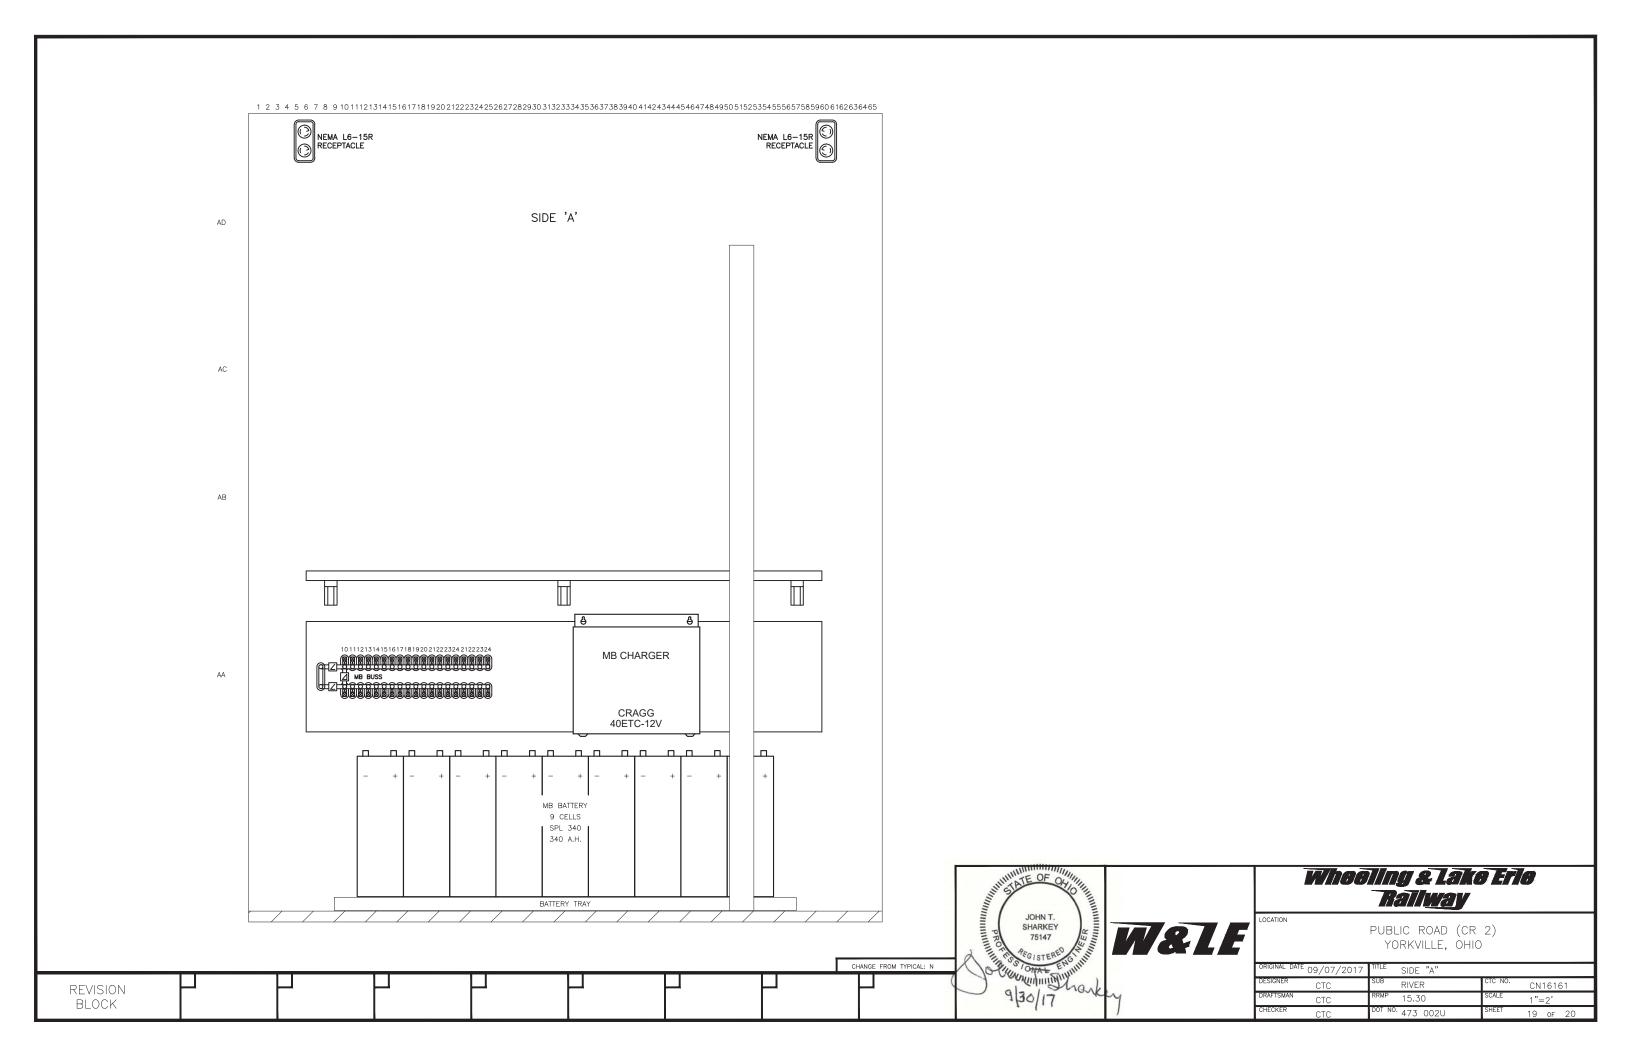

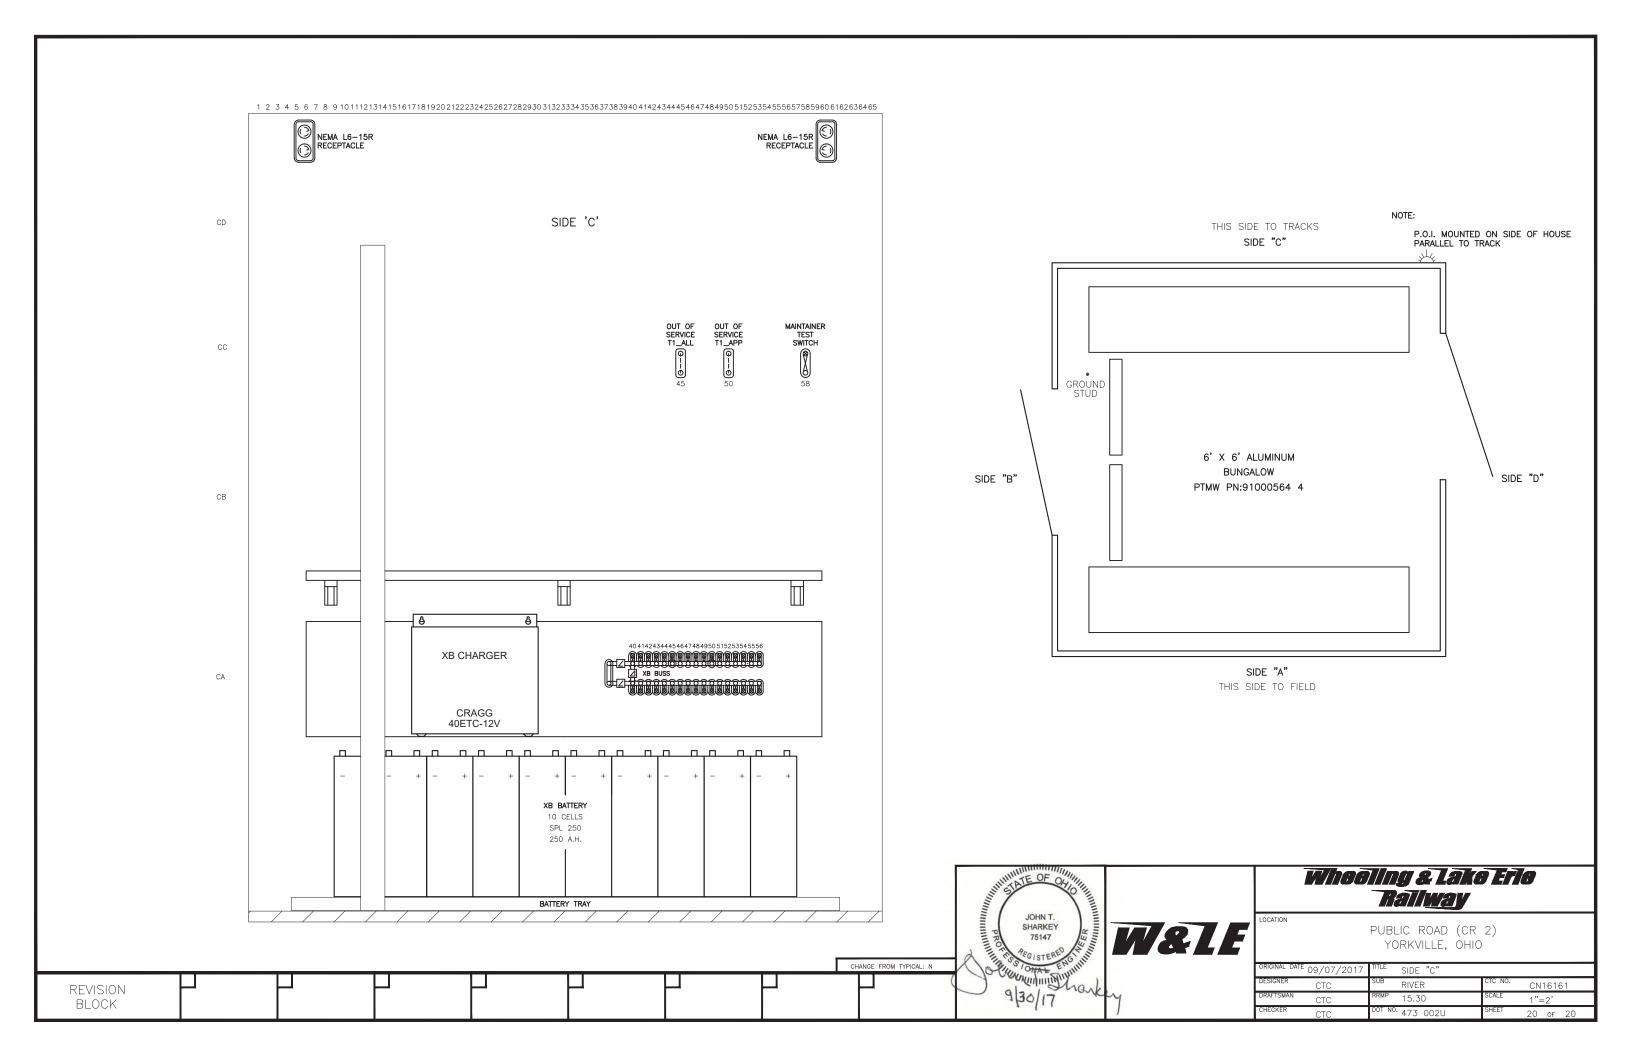

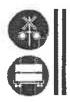

OHIO RAIL DEVELOPMENT COMMISSION

Mail Stop #3140, 1980 West Broad Street, Columbus OH 43223 John R. Kasich, Governor • Mark Policinski, ORDC Chairman

July 25, 2016

Mr. Tim Andrews Wheeling & Lake Erie 100 East First St. Brewster Oh, 44613

473 002 U

RE: Jefferson County, CR 2/Public Rd, DOT# 502-246N_BID# 103324

Dear Mr. Andrews:

A diagnostic review was held at the above grade crossing on April 19 2016. The crossing has been recommended for the installation of lights and gates.

Wheeling & Lake Erie (WE) is authorized to proceed with the site plans and cost estimates (PE) or bid package for this project. This authorization is made with the stipulation and understanding that any field work needs prior approval before work begins. This authorization is made with the stipulation and understanding that an approved estimate may contain entries for items or activities that may be cited and found to be ineligible for federal participation during the project audit.

The diagnostic review form is attached. Please note any recommendations (page 5), if any, made by the team with regard to requirements for this location. Any minor roadway work necessary for MUTCD compliance should be incorporated into the PE and such costs will flow through the railroad reimbursement process.

The Project Manager for this project is James Tucker. James can be reached at (614) 398-6897, or james.tucker@dot.ohio.gov, if you have any questions.

Sincerely.

Project Manager --

C: Randall Schumacher, Supervisor, Rail Division, PUCO George Martin, Grade Crossing Planner, PUCO Susan Arduini, ORDC ORDC (file)

Attachment: 1 (diagnostic review form)



www.rail.ohio.gov phone: 614.644.0306

IMPROVING RAIL TODAY FOR TOMORROW'S ECONOMY



OHIO RAIL DEVELOPMENT COMMISSION

Mail Stop #3140, 1980 West Broad Street, Columbus OH 43223 John R. Kasich, Governor • Mark Policinski, ORDC Chairman

July 25, 2016

Mr. Stephen J. Klinger Norfolk Southern Administrator Grade Crossing Program 1200 Peachtree Street NE, Box 123 Atlanta, Ga. 30324

RE: County Rd 2/Public Rd. DOT# 503-246N, Jefferson County PID# 103324

Dear Mr. Klinger:

A diagnostic review was held at the above grade crossing on April 19, 2016. The crossing has been recommended for the installation of lights and gates.

Norfolk Southern (NS) is authorized to proceed with the site plans and cost estimates (PE) or bid package for this project. This authorization is made with the stipulation and understanding that any field work needs prior approval before work begins. This authorization is made with the stipulation and understanding that an approved estimate may contain entries for items or activities that may be cited and found to be ineligible for federal participation during the project audit.

The diagnostic review form is attached. Please note any recommendations (page 5), if any, made by the team with regard to requirements for this location. Any minor roadway work necessary for MUTCD compliance should be incorporated into the PE and such costs will flow through the railroad reimbursement process.

The Project Manager for this project is James Tucker. James can be reached at (614) 398-6897, or james.tucker@dot.ohio.gov, if you have any questions.

Sincerely,

Project Manager

C: Randall Schumacher, Supervisor, Rail Division, PUCO

George Martin, Grade Crossing Planner, PUCO

Susan Arduini, ORDC

ORDC (file)

Attachment:

1 (diagnostic review form)



www.rail.ohio.gov phone: 614.644.0306

IMPROVING RAIL TODAY FOR TOMORROW'S ECONOMY

OHIO RAIL DEVELOPMENT COMMISSION

Diagnostic Review Team Survey

Reason for Survey: (e.g. formula, accident, constituent, etc.)	Formula Spring Pick		Date: 4/19/2016	t			
Location Data							
Street or Road Name: Public Road							
Route/Road Number (i.e. Twp., Co., SR or US) CR 2	, despe		US DOT No.: 503246N				
County: JEF Township:		City: (In or Near)	Village of Yorkville				
Railroad Name: Norfolk Southern	Railroad Division: Pittsburgh		Branch/Line Name:	River I.T.			
Nearest RR Timetable Station: Yorkville			RR Milepost: 33.09				
On-Site Review Team							
(Include: Name - Organization - Phone Number	– Email)						
1. James Ticker OR	OC 614-398-6	897 Ja	mes. Tucker@dot	OH10.90V			
2 GEORGE MATTIN PL	100 614-152.		EURGE. MARTIN @				
3. Tim Andrews WL	E 530-417.		TANDREWSOW				
	1 : 0						
DEL	11 This king at	859-137	mother of two e co	- AREMY			
5. KON EMIERSON	11 11 11 11 - 18	1089121	13 LEXUS MABE				
6. John Morelli Chier	YorkuilletD. 740 8	121517	Yorkville Police &	Hotmail.com			
7. DAVE MCIATYRE AG	S NS RR. 330.	221-6811	DAVID METHTYR	E EMS COLP. COM			
8. Justin Donley NS Main	tainer 740-491-	0176	justin. donler 2 rapad	COM			
9. Warne KMarilo	/ 700 0 - 1		, / ^'	Ve Nscorp. Com			
3. COHYBE DIREXIAD	7 236-804	1041 1	Y HAUSE'T HET MITTER	A CHARCOLL COM			
Existing Traffic Control Devices							
Type of Warning Devices	Installed	?	Quantity/Co	omments			
Advance Warning Signs (condition?)		X No		O. Paper			
'Stop' Signs		74No	0,100				
'Stop Ahead' Signs		X No					
Pavement Markings (condition?)	☐ Yes	No.					
Crossbucks	[X]Yes [No					
Number of Tracks Signs	∑ Yes [No					
Inventory Tags	∑ Yes [No					
interconnected Highway Traffic Signal	☐ Yes	X No					
Mast-Mounted Flashing Lights	⊠ Yes [No					
Cantilever Flashing Lights	☐ Yes	X.No	Number:	Length:			
Side Lights	X Yes	No	1 fourth S	+. WILE MAST			
Automatic Gates	☐ Yes	X.No	Number:	Length:			
Bells	 ✓ Yes	No	Number: Z				
Sidewalk Gate Arms		Z No					
'No Turn' Signs		No ·		-			
Illumination	K) Yes [No					
Is crossing flagged by train crew?		X No					
Other	Yes	No					

Number & dates of crashes	0 (7/	16/97)	
In previous 5 years	, , , , , , , , , , , , , , , , , , ,	-	
Hazard Ranking	1428	Date Run: 3/30/2016	3(063 6121)
Railroad Data			
Railroad Characteri	stics	Initial Information (from database)	Revised
Total trains per day		7	1) 7 hweek
< per day			TIMES VARY PER F
Day thru trains		12 1	
Night thru trains		\$	
Daytime switching movem Nighttime switching move		2	
Total number of tracks	illeits	2	
Number of main tracks		2	
Number of other tracks			0
Maximum train speed		25	
Typical train speed		25	
Amtrak		<u> </u>	
If multiple tracks, can two train Can one train block the moto Can one or more tracks be el Are there other track(s) cross	ins occupy orists' view of iminated the sing this san	ance adequate in all quadrants? (See Table I) crossing at the same time? Yes No of another train at crossing? Yes (Explain be rough the crossing? Yes No ne roadway within 100 ft of this crossing?	elow) 🔲 No
If multiple tracks, can two train Can one train block the moto Can one or more tracks be el	ins occupy orists' view of this san this san different)	rossing at the same time? X Yes No of another train at crossing? X Yes (Explain be rough the crossing? Yes X No	elow) [] No Yes [X]No
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If multiple tracks, can two trait Can one train block the motor Can one or more tracks be ele Are there other track(s) cross If yes, Crossing DOT #(if of If yes, distance Roadway Data Local Highway Authority: Roadway Character	ins occupy orists' view of iminated the sing this san different) (take m	rossing at the same time? Yes No of another train at crossing? Yes (Explain be rough the crossing? Yes No ne roadway within 100 ft of this crossing? reasurement between track centerlines at close Village of Yorkville Initial Information (from database)	elow)
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If multiple tracks, can two trail Can one train block the moto Can one or more tracks be el Are there other track(s) cross If yes, Crossing DOT #(if of the first	ins occupy orists' view of iminated the sing this san different)(take make make the sing this san different)(take make make the sing this san different)(take make the single sin	rossing at the same time? X Yes No of another train at crossing? X Yes (Explain be rough the crossing? Yes No ne roadway within 100 ft of this crossing? reasurement between track centerlines at close Village of Yorkville Initial Information (from database) 2994 (2011) X Yes No el Concrete Other 2 Rural	Possible Increase
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If multiple tracks, can two trail Can one train block the moto Can one or more tracks be el Are there other track(s) cross If yes, Crossing DOT #(if or If yes, distance Roadway Data Local Highway Authority: Roadway Character Average daily traffic Highway paved Roadway Surface: Blackto Roadway width:ft. Number of highway lanes Urban or Rural Vehicle Speed:MPH School Bus Operation:N	ins occupy or orists' view of iminated the sing this san different) (take many of the san different) (take many of take many	rossing at the same time? Yes No of another train at crossing? Yes (Explain be rough the crossing? Yes No ne roadway within 100 ft of this crossing? reasurement between track centerlines at close Village of Yorkville Initial Information (from database) 2994 (2011) X Yes No el Concrete Other 2 Rural 2 Rural 2 Amount 12 546	Possible Increase

Quadrant Curb and Gutter:	Quadrant Curb and Gutter:
Functional (Curb height = 4" or more)	☐ Functional (Curb height = 4" or more)
Non-functional (Curb height = Less than 4")	Non-functional (Curb height = Less than 4")
None	None None
Pedestrians: No A.Yes	
Is sidewalk present? No CYes	
Is there a nearby intersection that could cause queuing over the ci	rossing? No XYes
If yes, Distance 15	
Is this intersection signalized? No	
Are the signals currently interconnected with the existing crossi	ng warning devices? 🔀 No 🔲 Yes
Is there a 'Do not Stop on Track' sign? X. No Yes	•
Is a roadway Improvement project (e.g. widening, turn lanes, neart	by new or upgraded traffic signal, sidewalk) planned at or near this
location in the foreseeable future? No Yes	
Improvement type Lead Agency	Timeline/completion -
Is it the consensus of the Diagnostic Review Team that this is a po	tential closure project: X No Yes
Explain reasons:	
•	
Type of Development	
Open Space Institutional Location of nearby	
☐ Industrial	HORAM Tiltonsville
Residential	
Utility Information	
Is commercial power available? No	
Utility Provider (Company Name) AEP	Phone Number
Nearest Available Power Source	
What other utilities are present? Gas Cable	Telephone
(add locations to sketch) Petroleum Water Other	Sanitary Sewer
Is(are) there potential utility conflict(s) Yes No	Unknown
Comments:	

Potential Red Flags / Project Challenges
Traffic Signal Preemption (include traffic signal intersection name and LHA with jurisdiction over traffic signal, if known):
LHA STATES That Traffic does not queu over the
Tracks
Crossing Consolidation or Closure:
NIA
Real Estate or ROW:
Limited Row. for placement of
BUNSALOW
Culverts / Drainage / Ballast Conditions:
NIA
Roadway and/or Sidewalks:
SW Quad Sidewalk might be impacted
Circuitry (e.g. reaches out to other crossings, specific needs, etc.):
WILE AND N.S. Share crossing
Wice Alla 10.5. State Crossing
Environmental:
NIA
Other:
Power lines will need to be raised in S.W. Quad.

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	Field Sketch				
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	Crossing Angle 0-29° 30-59°	☑ 60-90° Measured in	n Quadra	ant?	
-	Sketch by:				
F					

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Diagnostic Team Recommendations	
	Quadrants Needed
Install/upgrade active devices	Quadrants receded
Automatic Flashing Lights (AFLS)	
AFLS /Cants	·
	(SU/NS) + NE FOR Wheeling
AFLS / Gates / Cants	(30/N) NE TOR WYZZING
▼ Bells / number	2
Upgrade circuitry / type	
N Sidelights	I for foorth + I for Alley
C Guardrail Needed	NE Quid wheeling
☐ Install/Replace curb	(CURD SU QUAR NS) (CURD NE Wheeling)
Bungalow placement & offset from rail & highway	(COSO 20 days by) (COSO INS DIVERTING)
Other (define)	
Comments: MS 4000 OR MS 2000 for	a NS Cicanitas
	2 03 (11 201 127
XP4 for wheeling.	
Install/upgrade traffic signal preemption	·
No improvements needed	
Other (define)	
Acknowledgement of Recommendations (each entity represented	at the diagnostic must have at least one signature
acknowledgement):	
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23 Roadway	
- ' Parkway	
American Services	
5 Sidewalk	
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27 -: -:

TABLE I

Clearing Sight Distances

Maximum Authorized Train Speed	Distance (dT) Along Railroad from Crossing (ft)
1 - 10	240
15	360
20	480
25	600
30	720
35	840
40	960
45	1080
50	1200
55	1320
60	1440
65	1560
70	1680
75	1800
80 .	1920
, 85	2040
90	2160

Source: R-H Grade Crossing Handbook Table 36 (pp. 132-133)

Notes:

All calculated distances are rounded up to the next higher 5-foot increment.

Distances indicated are for 65-ft double bottom semi-tractor trailers and level single track 90 degree crossings; and may need to be adjusted for multiple tracks, skewed crossings or approaches on grades.

Clearing Sight Distance is to be measured in each vehicle travel direction at <u>non-gated crossings</u> as viewed from a point 25 feet from centerline of nearest track in the center of whichever travel lane is nearest the direction along track being measured.

Table 2

Stopping Sight Distances

Highway Vehicle Speed	Distance (dH) Along Roadway from Crossing (ft)	
0	n/a	
5	50	
10	70	
[5	105	
20	-135	
25	180	
30	225	
35	280	
40	340	
45	410	
50	490	
55	570	
60	660	
65	760	
70	865	

Source: R-H Grade Crossing Handbook Table 36 (pp. 132-133)

Notes

All calculated distances are rounded up to the next higher 5foot increment.

Distances indicated are for 65-ft double bottom semi-tractor trailers on dry level pavements.

Stopping Sight Distance is to be measured on each roadway approach to crossing from stop bar.

This foregoing document was electronically filed with the Public Utilities

Commission of Ohio Docketing Information System on

7/20/2018 1:02:05 PM

in

Case No(s). 18-1135-RR-FED

Summary: Application In the Matter of a Request for the Installation of Active Warning Devices at the Norfolk Southern Railway & Wheeling & Lake Erie Railway Crossings, on Public Road DOT#503-246N & DOT#473-002U in Jefferson County, Ohio. electronically filed by Mrs. Jill A Henry on behalf of PUCO/Rail Division