ACCESS ROAD (AR-11), WETLAND #17. WETLAND #18, <u>& WETLAND #19</u> SCALE: 1" = 100"

- 1. REFER TO DETAIL SHEET 3 FOR "TB/P" DETAIL ADDITIONAL TRENCH BREAKERS SHALL BE USED IF NEEDED.

  2. REFER TO DETAIL SHEET 3 FOR "WC" DETAIL.

  3. PLACE SEDIMENT BARRIER/SIGNAGE AROUND PERIMETER OF WETLAND PRIOR TO ANY EARTHWORK. IF THE CONTRACTOR IS NOT SURE WHERE THE WETLAND "LIMIT" IS, HE SHALL CONTACT THE OWNER TO HAVE THE WETLAND REMARKED.

  4. THE CONTRACTOR SHALL PLACE LOG WATS TO CROSS THE WETLAND AREA. ALL APPUICABLE WETLAND FAREA WHITH THE UINTS OF CONSTRUCTION/DISTURBANCE SHALL BE COVERED. THE CONTRACTOR SHALL BE RESPONSIBLE FOR ANY FINES AND/OR REPAIRS REQUIRED AS A RESULT OF DAMAGE TO WETLANDS AND WATERCOURSES AT NO COST TO THE FACULTY OWNER.

  5. REFER TO DETAIL SHEET 6 FOR "MT" DETAIL:

  a) WETLAND #7, #18 & #19 USE BLANKET TYPE 575 OR APPROVED EQUIAL, STAPLE PATTERN "C".

  6. REFER TO DETAIL SHEET 5 FOR "RC" DETAIL.

  7. REFER TO DETAIL SHEET 5 FOR "RC" DETAIL.

  8. REFER TO DETAIL SHEET 5 FOR "RC" DETAIL.

  9. REFER TO DETAIL SHEET 5 FOR "RC" DETAIL.

  9. REFER TO DETAIL SHEET 5 FOR "RC" DETAIL.

# GRAPHIC SCALE

THIS DOCUMENT IS THE PROPERTY OF HANOVER ENGINEERING ASSOCIATES, INC. AN OF THIS DOCUMENT THAT DOES NOT CONTAIN AN ORIGINAL SEAL AND SIGNATURE IS PROHIBITED. THIS DOCUMENT IS NOT PUBLISHED AND ALL RICHTS ARE RESERVED BE ENGINEERING ASSOCIATES, INC. THIS PLAN HAS BEEN SEALED WITH EITHER A RED CRIMP SEAL. IF NEITHER APPEARS ON THIS PLAN, POSSIBLE REPRODUCTIONS OR AI HAYE BEEN MADE WITHOUT THE APPROVAL OR KNOWLEDGE OF THE SIGNATION.

( IN FEET )

NY USE OF A COPY S STRICTLY BY HANOVER INK SEAL OR A	
ALTERATIONS MAY	

NO.	REVISIONS	DATE	AVON LAKE GAS ADDITIC	N PRO
			CARLISLE. EATON & LAGRANGE TOWNSHIPS	DRAWN BY: AEJ
			AVON, AVON LAKE, ELYRIA &	CHECKED BY: SJC
			NODELL DIDOCULLE OFFICE	3

NORTH RIDGEVILLE CITIES LORAIN COUNTY

> 3355 Route 611, Suite 1 570.688.9550 Fax 570.688.9768

**GENERAL NOTES:** 

SEE DETAIL SHEET 1 FOR SCHEDULE FOR PIPES/BRIDGES.
 STREAM BUFFER IS 25 FEET FROM THE ORDINARY HIGH WATER MARK AND WETLAND BUFFER IS 25 FT. FROM WETLAND BOUNDARY.

E&SPC SITE DETAIL ROJECT PROJECT NO. NRG-1007 SHEET NO. 12.15.14 61 of 88 OHIO Hanover Bartonsville, PA 18321-7822 Engineering Associates Inc

LIMIT OF CONSTRUCTION AND LIMIT OF DISTURBANCE - 235 AC.

<u>LEGEND</u> INDEX CONTOUR CONTOUR PROPERTY LINE
TEMP. CONSTRUCTION
EASEMENT/LIMIT OF
DISTURBANCE PERMANENT PIPELINE R.O.W. CENTERLINE PIPELINE R.O.W. ---- ABOVE GROUND PIPE

CONVENTIONAL BORE

OVERHEAD/UTILITY POLE FLOW PERENNIAL STREAM FLOW EPHEMERAL/INTERMITTENT

STREAM

SOIL TYPE & BOUNDARY

SILTSOXX OR EQUIV.

SILTSOXX OR EQUIV. 24" HEIGHT

SILTSOXX OR EQUIV. 32" HEIGHT

ROCK CONSTRUCTION ENTRANCE

STREAMBANK RESTORATION

ROCK FILTER BERM

WETLAND CROSSING SEDIMENT SILT SOXX PROTECTION AT WATER BAR

ACCESS ROAD

HIGHWAY CUT ACCESS RD. X-ING (PAVED ROAD) ACCESS RD. w/CULVERT UTILITY LINE STREAM X-ING WITH DAM AND PUMPING OR WITH PIPE FLUME

TRENCH BREAKER/PLUG LONGITUDINAL DIVERSION GRADING

EROSION CONTROL MATTING

FENCE

WETLANDS

WOODS LINE ... EDGE WOODS

ORD. HIGH WATER MARK ORD. HIGH WATER MARK LINE

LM LOG MAT

PEM/PSS PFO

(SS12)\*

(SS24)

SS32)\*\*


RCE


(MT)

SBR

RFB BR

(B/P)

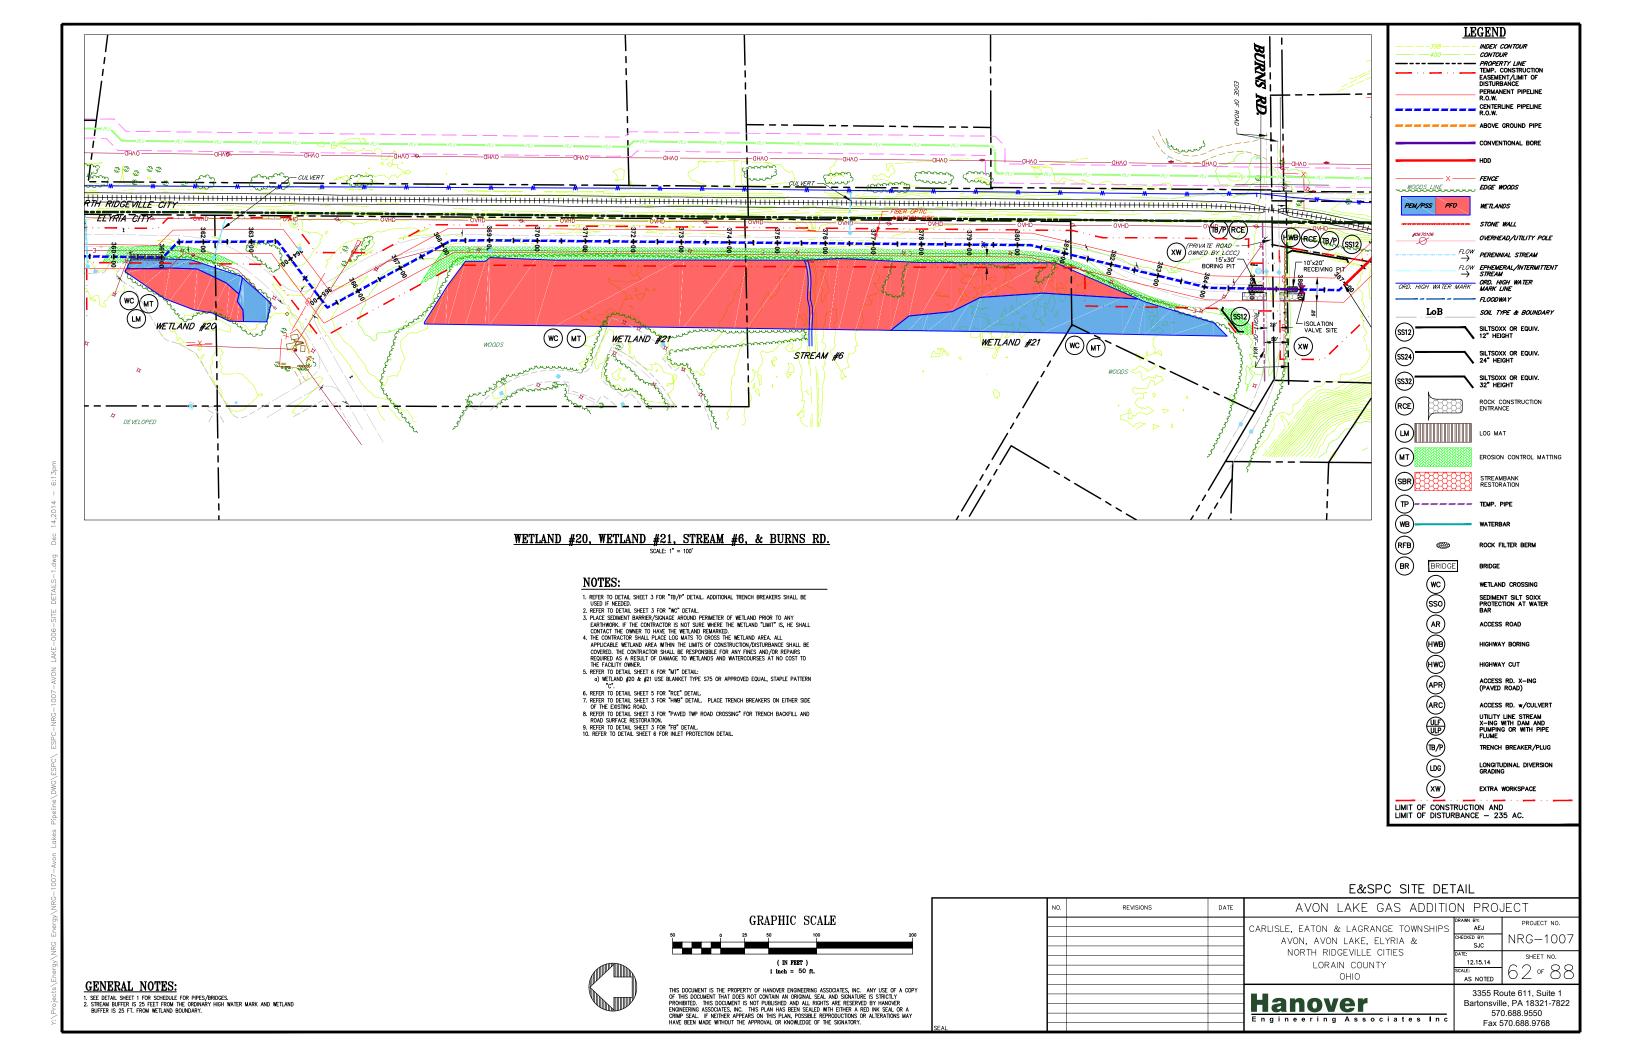

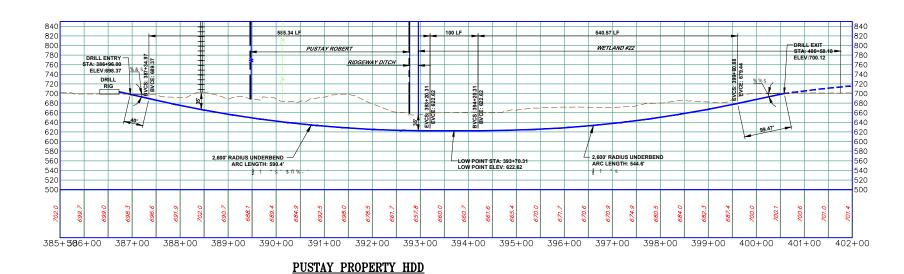

# RIDGEWAY DITCH & WETLAND #22

## NOTES:

- RIDGEWAY DITCH AND WETLAND #22 TO BE BORED.
   REFER TO DETAIL, SHEET 3 FOR "TByP" DETAIL, ADDITIONAL TRENCH BREAKERS SHALL BE USED IF NEEDED.
   PLACE SEDIMENT BARRERY/SIGNAGE AROUND PERMETER OF WETLAND PRIOR TO ANY EARTHWORK. IF THE CONTRACTOR IS NOT SUBE WHERE THE WETLAND THAT SHE WETLAND THE WETLAND THAT SHE WETLAND THE WETLAND THAT SHE WETLAND THAT SHEET SHE WETLAND THAT SHE WETLAND

E&SPC SITE DETAIL

LIMIT OF CONSTRUCTION AND LIMIT OF DISTURBANCE - 235 AC.

<u>LEGEND</u> INDEX CONTOUR CONTOUR PROPERTY LINE
TEMP. CONSTRUCTION
EASEMENT/LIMIT OF
DISTURBANCE PERMANENT PIPELINE R.O.W. CENTERLINE PIPELINE R.O.W. ABOVE GROUND PIPE

CONVENTIONAL BORE

OVERHEAD/UTILITY POLE FLOW PERENNIAL STREAM FLOW EPHEMERAL/INTERMITTENT

STREAM

SOIL TYPE & BOUNDARY

SILTSOXX OR EQUIV.

SILTSOXX OR EQUIV. 24" HEIGHT

SILTSOXX OR EQUIV. 32" HEIGHT

ROCK CONSTRUCTION ENTRANCE

STREAMBANK RESTORATION

ROCK FILTER BERM

WETLAND CROSSING

ACCESS ROAD

HIGHWAY CUT

ACCESS RD. X-ING (PAVED ROAD) ACCESS RD. w/CULVERT UTILITY LINE STREAM X-ING WITH DAM AND PUMPING OR WITH PIPE FLUME

TRENCH BREAKER/PLUG

LONGITUDINAL DIVERSION GRADING

SEDIMENT SILT SOXX PROTECTION AT WATER BAR

EROSION CONTROL MATTING

FENCE

WETLANDS

WOODS LINE .... EDGE WOODS

ORD. HIGH WATER MARK ORD. HIGH WATER MARK LINE

LM LOG MAT

BRIDGE

\(\text{\tin\text{

PEM/PSS PFO

(SS12)\*

(SS24)

SS32

RCE

(MT)

SBR

(TP)

)(RFB)(BR)

# HDD PROFILE

(ON 22x34 SHEET) HORIZONTAL & VERTICAL


GRAPHIC SCALE





THIS DOCUMENT IS THE PROPERTY OF HANOVER ENGINEERING ASSOCIATES, INC. ANY USE OF A COPY OF THIS DOCUMENT THAT DOES NOT CONTAIN AN ORIGINAL SEAL AND SIGNATURE IS STRICTLY PROHIBITED. THIS DOCUMENT IS NOT PUBLISHED AND ALL RICHARD ARE RESERVED BY HANOVER ENGINEERING ASSOCIATES, INC. THIS PLAN HAS BEEN SEALED WITH EITHER A PEED INK SEAL OR A CRIMP SEAL. IF NEITHER APPEARS ON THIS PLAN, POSSIBLE REPRODUCTIONS OR ALTERATIONS MAY HAVE BEEN MADE WITHOUT THE APPROVAL OR NONDIEDGE OF THE SIGNATORY.

	NO.	REVISIONS	DATE	AVON LAKE GAS ADDITIC	N PRO	JECT
				CARLISLE, EATON & LAGRANGE TOWNSHIPS  AVON, AVON LAKE, ELYRIA &  NORTH RIDGEVILLE CITIES  I ORAIN COUNTY	DRAWN BY: AEJ CHECKED BY: SJC DATE: 12.15.14 SCALE: AS NOTED	PROJECT NO.  NRG—100  SHEET NO.  6 3 OF 8 8
				Hanover Engineering Associates Inc	Bartonsvill 570	oute 611, Suite 1 le, PA 18321-7822 0.688.9550 570.688.9768



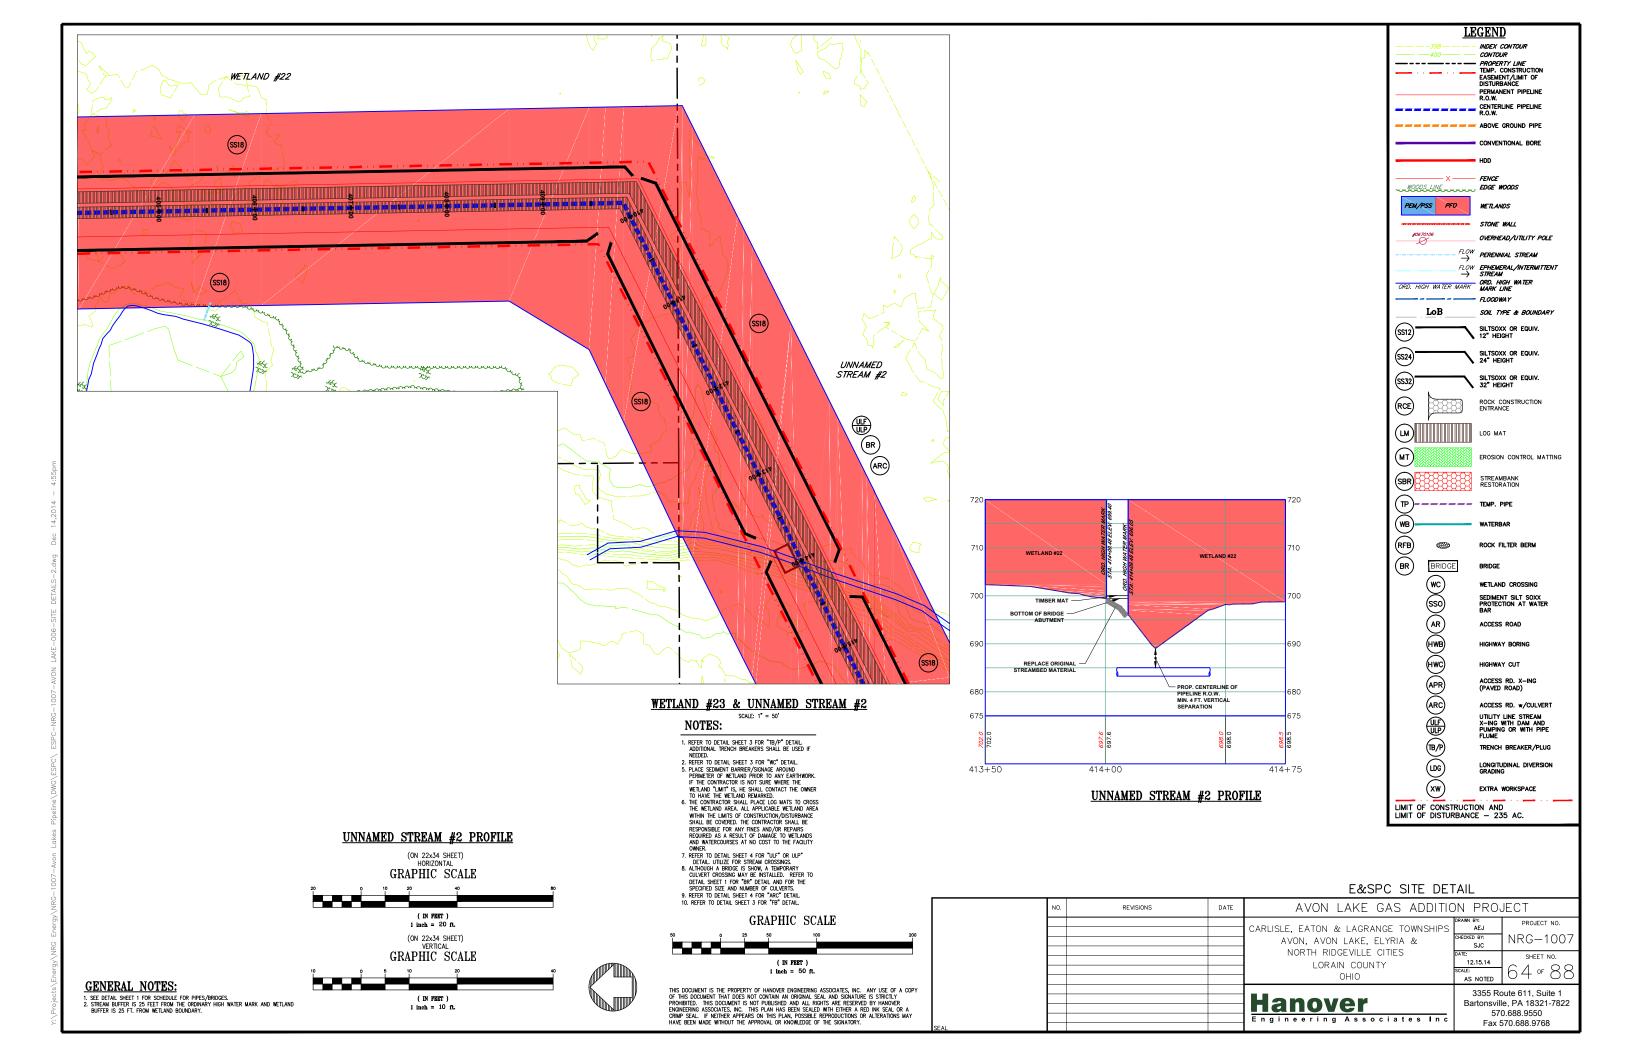

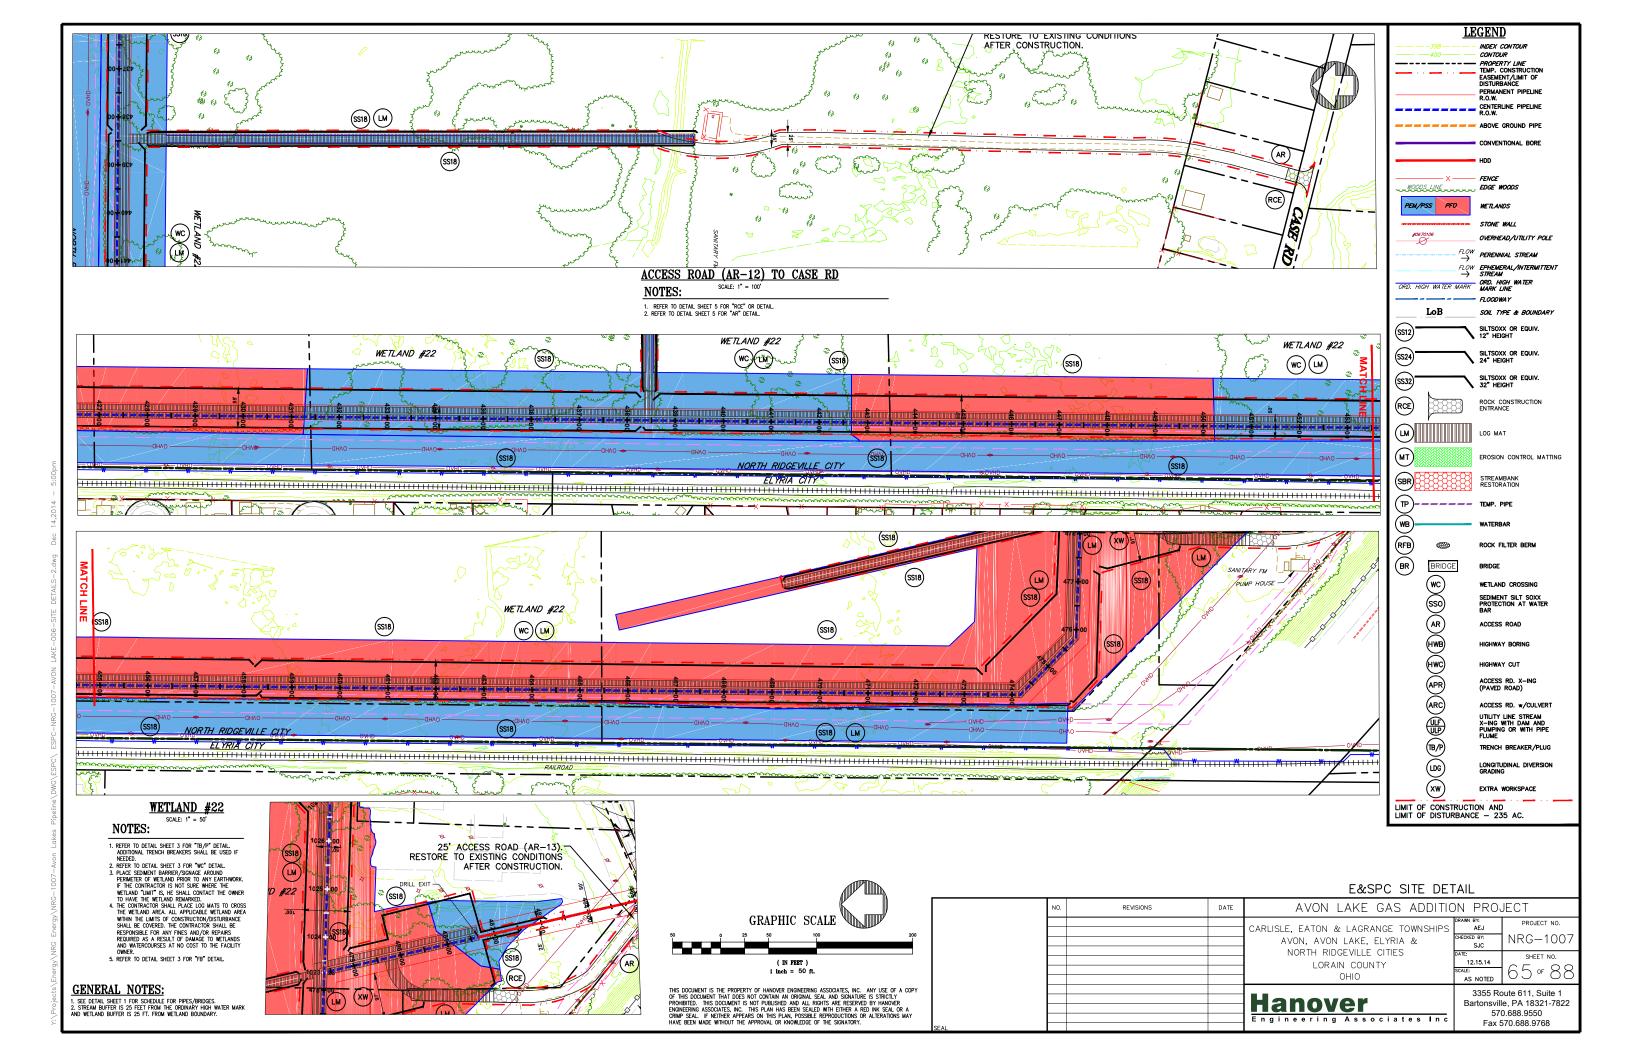

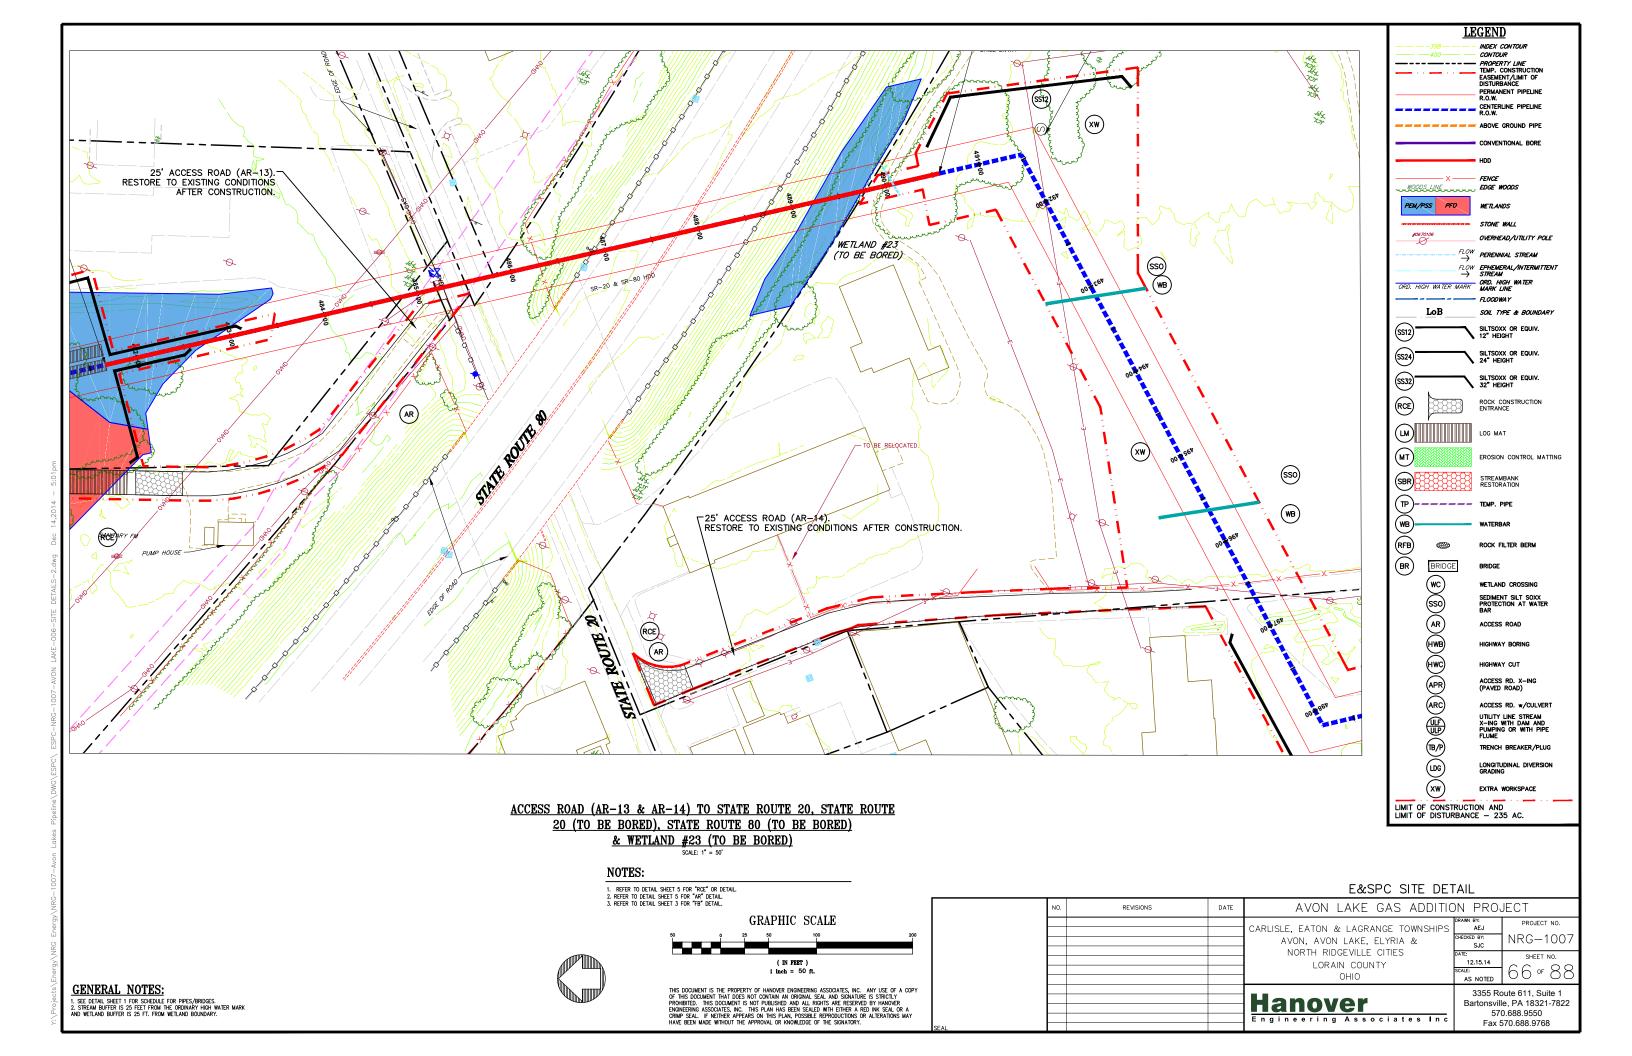

- 1. REFER TO DETAIL SHEET 3 FOR "IB/P" DETAIL. ADDITIONAL TRENCH BREAKERS SHALL BE USED IF NEEDED.

  2. REFER TO DETAIL SHEET 3 FOR "WC" DETAIL.

  3. PLACE SEDIMENT BARRIER/SIGNAGE AROUND PERIMETER OF WETLAND PRIOR TO ANY EARTHWORK. IF THE CONTRACTOR IS NOT SURE WHERE THE WETLAND "LIMIT" IS, HE SHALL CONTACT THE OWNER TO HAVE THE WETLAND BEDAMKED.

  4. THE CONTRACTOR SHALL PLACE LOG MATS TO CROSS THE WETLAND AREA. ALL APPUCABLE WETLAND AREA MIND THE MINTS OF CONSTRUCTION/DISTURBANCE SHALL BE COVERED. THE CONTRACTOR SHALL BE RESPONSIBLE FOR ANY FINES AND/OR REPAIRS REQUIRED AS A RESULT O PAMAGE TO WETLANDS AND WATERCOURSES AT NO COST TO THE FACULTY OWNER.

  5. REFER TO DETAIL SHEET 6 FOR "MI" DETAIL.

  6. REFER TO DETAIL SHEET 6 FOR "MI" DETAIL.

  6. REFER TO DETAIL SHEET 5 FOR "MI" DETAIL.

  7. REFER TO DETAIL SHEET 5 FOR "MI" DETAIL.

  8. REFER TO DETAIL SHEET 5 FOR "MI" DETAIL.

  9. WETLAND J2S USE BLANKET TYPE S75 OR APPROVED EQUAL, STAPLE PATTERN "C".

  9. REFER TO DETAIL SHEET 5 FOR "MI" DETAIL.

  9. REFER TO DETAIL SHEET 5 FOR "MI" DETAIL.

  9. REFER TO DETAIL SHEET 5 FOR "FI" OR DETAIL.

  9. REFER TO DETAIL SHEET 5 FOR "FI" DETAIL.

  9. REFER TO DETAIL SHEET 5 FOR "RE" OR DETAIL.

  9. REFER TO DETAIL SHEET 5 FOR "NE" DETAIL.

  9. REFER TO DETAIL SHEET 5 FOR "RE" OR DETAIL.

  9. REFER TO DETAIL SHEET 5 FOR "FI" OR DETAIL.

  9. REFER TO DETAIL SHEET 5 FOR "FI" DETAIL.

  9. REFER TO DETAIL SHEET 5 FOR "FI" DETAIL.

  9. REFER TO DETAIL SHEET 5 FOR "FI" DETAIL.

  9. REFER TO DETAIL SHEET 5 FOR "FI" DETAIL.

  9. REFER TO DETAIL SHEET 5 FOR "FI" DETAIL.

  9. REFER TO DETAIL SHEET 5 FOR "FI" DETAIL.

  9. REFER TO DETAIL SHEET 5 FOR "FI" DETAIL.

- 8. REFER TO DETAIL SHEET 3 FOR "FB" DETAIL.

  9. REFER TO DETAIL SHEET 6 FOR INLET PROTECTION DETAIL.

#### E&SPC SITE DETAIL

<u>LEGEND</u> INDEX CONTOUR PROPERTY LINE
TEMP. CONSTRUCTION
EASEMENT/LIMIT OF
DISTURBANCE PERMANENT PIPELINE R.O.W. CENTERLINE PIPELINE R.O.W. ABOVE GROUND PIPE

CONVENTIONAL BORE

FENCE

WETLANDS

STONE WALL OVERHEAD/UTILITY POLE FLOW PERENNIAL STREAM FLOW EPHEMERAL/INTERMITTENT

STREAM

SOIL TYPE & BOUNDARY

SILTSOXX OR EQUIV. 12" HEIGHT

SILTSOXX OR EQUIV. 24" HEIGHT

SILTSOXX OR EQUIV. 32" HEIGHT

STREAMBANK RESTORATION

ROCK FILTER BERM

WETLAND CROSSING SEDIMENT SILT SOXX PROTECTION AT WATER BAR ACCESS ROAD

HIGHWAY BORING

HIGHWAY CUT

ACCESS RD. X-ING (PAVED ROAD) ACCESS RD. w/CULVERT UTILITY LINE STREAM X-ING WITH DAM AND PUMPING OR WITH PIPE FLUME TRENCH BREAKER/PLUG LONGITUDINAL DIVERSION GRADING

ROCK CONSTRUCTION ENTRANCE

EROSION CONTROL MATTING

WOODS LINE WOODS

ORD. HIGH WATER MARK ORD. HIGH WATER MARK LINE

LM LOG MAT

BRIDGE

\(\text{\te\tin\text{\text{\text{\text{\text{\text{\text{\text{\text{\texi}\text{\text{\texi}\text{\text{\texi}\text{\text{\text{\texi}\tex{\text{\texi}\text{\texit{\text{\texi}\text{\texi}\text{\texit{\t

LIMIT OF CONSTRUCTION AND LIMIT OF DISTURBANCE - 235 AC.

PEM/PSS PFO

SS12)\*

(SS24)

SS32

RCE


(MT)

SBR

(TP)


)(RFB)(BR)



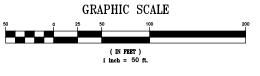

THIS DOCUMENT IS THE PROPERTY OF HANOVER ENGINEERING ASSOCIATES, INC. ANY USE OF A COPY OF THIS DOCUMENT THAT DOES NOT CONTAIN AN ORIGINAL SEAL AND SIGNATURE IS STRICTLY PROHIBITED. THIS DOCUMENT IS NOT PUBLISHED AND ALL RICHARD ARE RESERVED BY HANOVER ENGINEERING ASSOCIATES, INC. THIS PLAN HAS BEEN SEALED WITH EITHER A PEED INK SEAL OR A CRIMP SEAL. IF NEITHER APPEARS ON THIS PLAN, POSSIBLE REPRODUCTIONS OR ALTERATIONS MAY HAVE BEEN MADE WITHOUT THE APPROVAL OR NONDIEDGE OF THE SIGNATORY.


	NO.	REVISIONS	DATE	AVON LAKE GAS ADDITIC	ON PRO	JECT
				CARLISLE, EATON & LAGRANGE TOWNSHIPS AVON, AVON LAKE, ELYRIA & NORTH RIDGEVILLE CITIES LORAIN COUNTY	DRAWN BY: AEJ CHECKED BY: SJC DATE: 12.15.14 SCALE: AS NOTED	PROJECT NO.  NRG—1007  SHEET NO.  6 7 OF 88
SEAL				Hanover Engineering Associates Inc	Bartonsvill 57	oute 611, Suite 1 le, PA 18321-7822 0.688.9550 570.688.9768

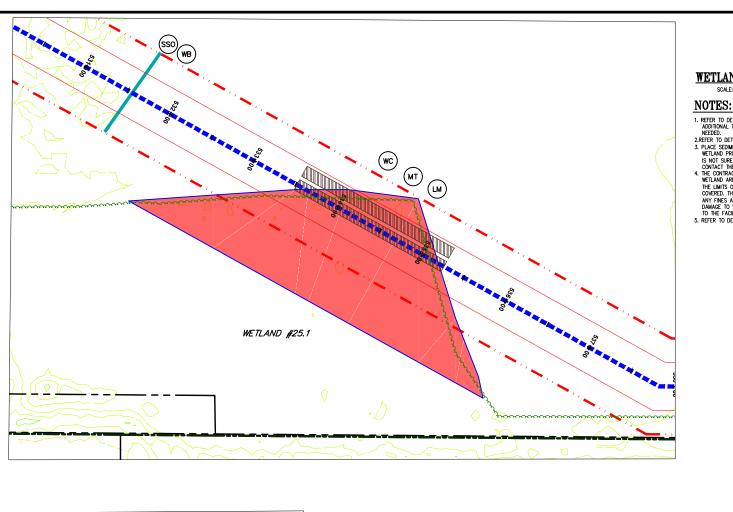

## WETLAND #25.1

I. REFER TO DETAIL SHEET 3 FOR "IB/P" DETAIL.
ADDITIONAL TRENCH BREAKERS SHALL BE USED IF
NEEDED.
2.REFER TO DETAIL SHEET 3 FOR "NC" DETAIL.
3. PLACE SEMINETI BARRIER, SCIANGE, AROUND PERMETER OF
WETLAND PRIDE TO ANY EARTHWORK, IF THE CONTRACTOR
IS NOT SURE WHEEP THE WETLAND "MIMITS, SHE SHALL
CONTACT THE OWNER TO HAVE THE WETLAND REMARKED.
4. THE CONTRACTOR SHALL PLACE LOG MATS TO GROSS THE
WETLAND AREA. ALL APPLICABLE WETLAND AREA WITHIN
THE JINITE OF CONSTRUCTION JUSTIFICABLES SHALL RE WELLAND AREA. ALL APPLICABLE, WELLAND AREA. WHIRIN THE LIMITS OF CONSTRUCTION/DISTURBANCE SHALL BE COVERED. THE CONTRACTOR SHALL BE RESPONSIBLE FOR ANY FIRES. AND/OR REPAIRS REQUIRED. AS A RESULT OF DAMAGE TO WETLANDS AND WATERCOURSES AT NO COST TO THE FACILITY OWNER.


5. REFER TO DETAIL SHEET 3 FOR "FB" DETAIL.

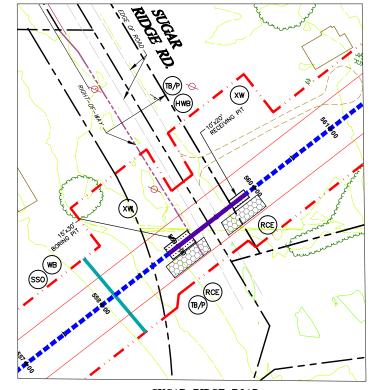

#### SUGAR RIDGE ROAD SCALE: 1" = 50"

#### NOTES:

1.. REFER TO DETAIL SHEET 5 FOR "RCE" OR DETAIL.
2. REFER TO DETAIL SHEET 3 FOR "HWB" DETAIL PLACE TRENCH BREAKERS ON EITHER SIDE OF THE EXISTING ROAD.
3. REFER TO DETAIL SHEET 3 FOR "STONE/DIRT TWP ROAD CROSSING DETAIL" OR "PAVED TWP ROAD CROSSING" FOR TERRICH BACKFILL AND ROAD SURFACE RESTORATION.
4. REFER TO DETAIL SHEET 3 FOR "FB" DETAIL

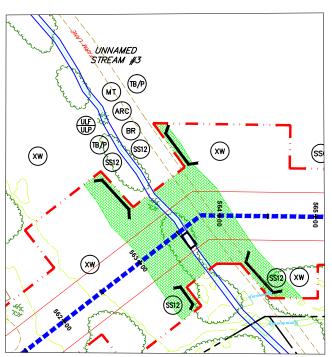


#### UNNAMED STREAM #3 SCALE: 1" = 50'

## NOTES:

- 1. REFER TO DETAIL SHEET 3 FOR "TB/P" DETAIL. ADDITIONAL TRENCH BREAKERS SHALL BE USED IF NEEDED.
  2. REFER TO DETAIL SHEET 6 FOR "MI" DETAIL:
  3. STREAM #12 USE BLANKET TYPE 575 OR APPROVED EQUAL STAPLE PATTERN "B".
  3. REFER TO DETAIL SHEET 4 FOR "ULF" OR ULF" DETAIL UTILIZE FOR STREAM CROSSINGS.
  4. ALPHOUGH A BRIDGE IS STOWN, A TEMPORARY CULVERT CROSSING MAY BE INSTALLED.
  REFER TO DETAIL SHEET 1 FOR "BR" DETAIL AND FOR THE SPECIFIED SIZE AND NUMBER
  SHEET OF THE STREAM OF THE SPECIFIED SIZE AND NUMBER.
- 5. REFER TO DETAIL SHEET 4 FOR "ARC" DETAIL.
  6. REFER TO DETAIL SHEET 3 FOR "FB" DETAIL.
- **GENERAL NOTES:**

SEE DETAIL SHEET 1 FOR SCHEDULE FOR PIPES/BRIDGES.
 STREAM BUFFER IS 25 FEET FROM THE ORDINARY HIGH WATER MARK AND WETLAND BUFFER IS 25 FT. FROM WETLAND BOUNDARY.

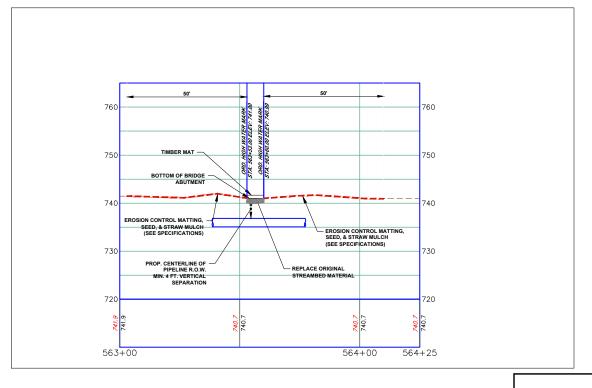

# UNNAMED STREAM #3 PROFILE (ON 22x34 SHEET) HORIZONTAL GRAPHIC SCALE 1 inch = 20 ft. (ON 22x34 SHEET) VERTICAL GRAPHIC SCALE ( IN FEET )

<u>LEGEND</u> INDEX CONTOUR CONTOUR PROPERTY LINE
TEMP. CONSTRUCTION
EASEMENT/LIMIT OF
DISTURBANCE

ABOVE GROUND PIPE

WOODS LINE ... EDGE WOODS

ORD. HIGH WATER MARK ORD. HIGH WATER MARK LINE

LOG MAT

PEM/PSS PFO

(SS12)

(SS24)

(SS32)<sup>®</sup>

RCE

(MT)

SBR

(TP)

RFB BR

SSO

TB/P

(LDG)

LIMIT OF CONSTRUCTION AND LIMIT OF DISTURBANCE - 235 AC.

PERMANENT PIPELINE R.O.W. CENTERLINE PIPELINE R.O.W.

CONVENTIONAL BORE

FENCE

WETLANDS STONE WALL OVERHEAD/UTILITY POLE

FLOW PERENNIAL STREAM FLOW EPHEMERAL/INTERMITTENT

STREAM

SOIL TYPE & BOUNDARY

SILTSOXX OR EQUIV.

SILTSOXX OR EQUIV. 24" HEIGHT

SILTSOXX OR EQUIV. 32" HEIGHT

ROCK CONSTRUCTION ENTRANCE

STREAMBANK RESTORATION

ROCK FILTER BERM

WETLAND CROSSING

SEDIMENT SILT SOXX PROTECTION AT WATER BAR

ACCESS RD. w/CULVERT UTILITY LINE STREAM X-ING WITH DAM AND PUMPING OR WITH PIPE FLUME

TRENCH BREAKER/PLUG


LONGITUDINAL DIVERSION GRADING

ACCESS ROAD

HIGHWAY CUT ACCESS RD. X-ING (PAVED ROAD)

EROSION CONTROL MATTING




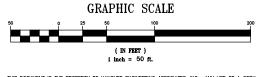


THIS DOCUMENT IS THE PROPERTY OF HANOVER ENGINEERING ASSOCIATES, INC. ANY USE OF A COPY OF THIS DOCUMENT THAT DOES NOT CONTAIN AN ORIGINAL SEAL AND SIGNATURE IS STRICTLY PROHIBITED. THIS DOCUMENT IS NOT PUBLISHED AND ALL RIGHTS ARE RESERVED BY HANOVER ENONEERING ASSOCIATES, INC. THIS PLAN HAS BEEN SEALED WITH EITHER A FED INK SEAL OR A CRIMP SEAL. IF NEITHER APPEARS ON THIS PLAN, POSSIBLE REPRODUCTIONS OR ALTERATIONS MAY HAVE BEEN MADE WITHOUT THE APPEROVAL OR KNOWLEDGE OF THE SIGNATORY.

NO.	REVISIONS	DATE	AVON LAKE GAS ADDITIC		JECT
			CARLISLE, EATON & LAGRANGE TOWNSHIPS AVON, AVON LAKE, ELYRIA &	DRAWN BY: AEJ CHECKED BY: SJC	PROJECT NO. NRG-1007
			LORAIN COUNTY	DATE: 12.15.14 SCALE: AS NOTED	SHEET NO. 68 OF 88
			Hanover Engineering Associates Inc	Bartonsvill 570	oute 611, Suite 1 e, PA 18321-7822 0.688.9550 670.688.9768

E&SPC SITE DETAIL

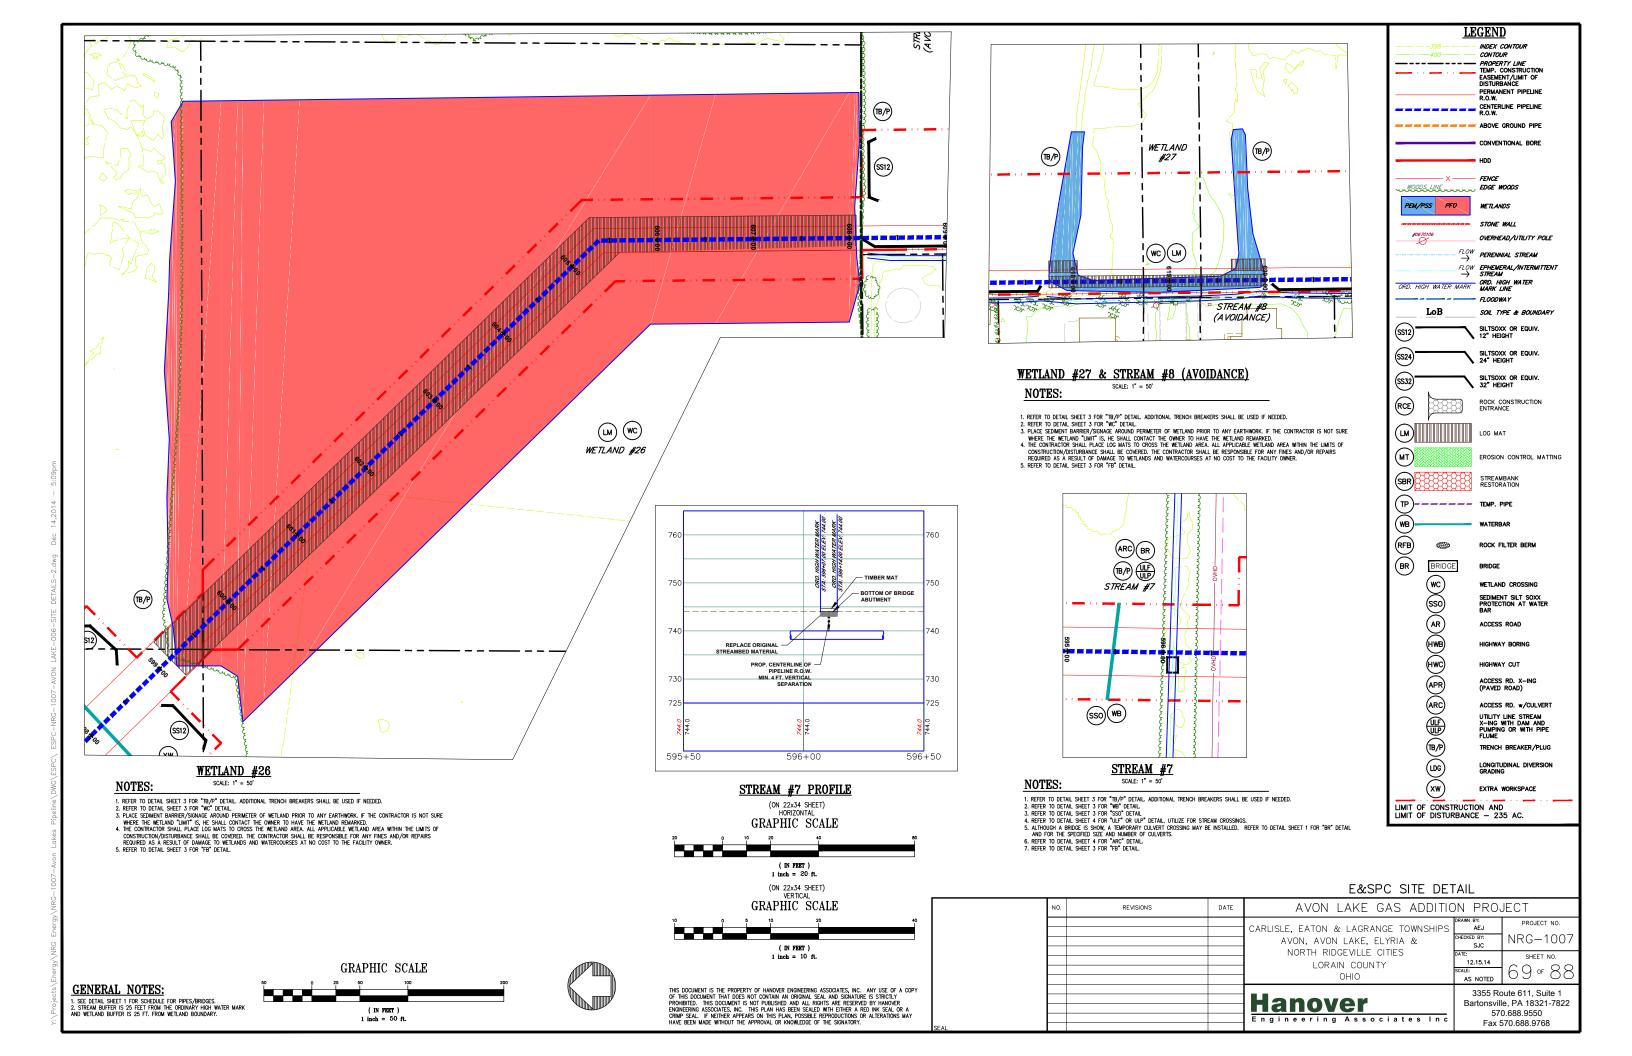

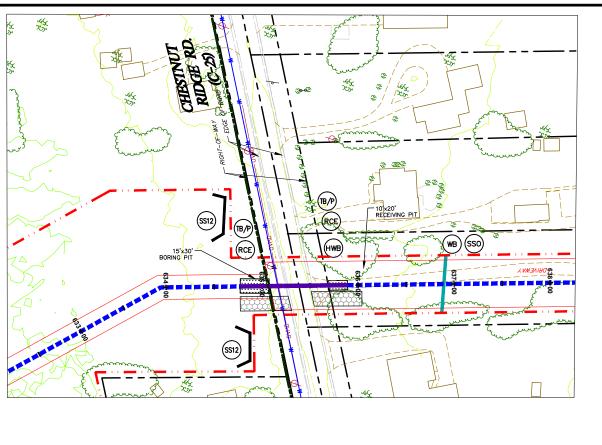

#### CHESTNUT RIDGE ROAD (C-25)

#### NOTES:

- I. REFER TO DETAIL SHEET 3 FOR "TB/P" DETAIL. ADDITIONAL TRENCH BREAKERS SHALL BE USED IF NEEDED.

  2. REFER TO DETAIL SHEET 3 FOR "MB" DETAIL.

  3. REFER TO DETAIL SHEET 3 FOR "SSO" DETAIL.


  4. REFER TO DETAIL SHEET 3 FOR "SSO" DETAIL.

  5. REFER TO DETAIL SHEET 5 FOR "RE" DETAIL.

  6. REFER TO DETAIL SHEET 5 FOR "HBM" DETAIL. PLACE TRENCH BREAKERS ON EITHER SUB-OF THE EXISTING ROAD.

  6. REFER TO DETAIL SHEET 3 FOR "STONE/DIRT TMP ROAD CROSSING DETAIL" OR "PAVED TMP ROAD CROSSING" FOR TRENCH BACKFILL AND ROAD SURFACE RESTORATION.


  7. REFER TO DETAIL SHEET 3 FOR "FB" DETAIL.

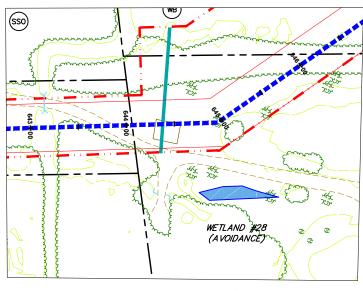

## WETLAND #28 (AVOIDANCE)

#### NOTES:

REFER TO DETAIL SHEET 6 FOR "MI" DETAIL:
 O) WE'TLAND #29 USE BLANKET TYPE 575 OR APPROVED EQUAL, STAPLE PATTERN "C".
 REFER TO DETAIL SHEET 3 FOR "FB" DETAIL.

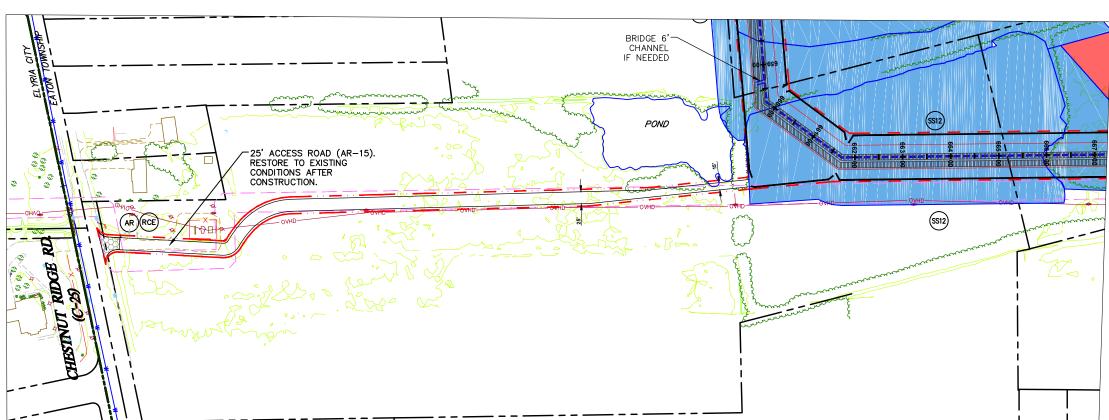

EACDO CITE DETAIL

<u>LEGEND</u>

ABOVE GROUND PIPE

WOODS LINE .... EDGE WOODS

ORD. HIGH WATER MARK ORD. HIGH WATER MARK LINE

LOG MAT

BRIDGE

SSO

TB/P

LDG

LIMIT OF CONSTRUCTION AND LIMIT OF DISTURBANCE - 235 AC.

PEM/PSS PFO

(SS12)\*

(SS24)

SS32

RCE

(MT)

SBR

RFB BR

INDEX CONTOUR CONTOUR PROPERTY LINE
TEMP. CONSTRUCTION
EASEMENT/LIMIT OF
DISTURBANCE

PERMANENT PIPELINE R.O.W. CENTERLINE PIPELINE R.O.W.

CONVENTIONAL BORE

FENCE

WETLANDS STONE WALL OVERHEAD/UTILITY POLE FLOW PERENNIAL STREAM

FLOW EPHEMERAL/INTERMITTENT

STREAM

SILTSOXX OR EQUIV.

SILTSOXX OR EQUIV. 24" HEIGHT

SILTSOXX OR EQUIV. 32" HEIGHT

STREAMBANK RESTORATION

ROCK FILTER BERM

WETLAND CROSSING

ACCESS ROAD

HIGHWAY CUT

ACCESS RD. X-ING (PAVED ROAD) ACCESS RD. w/CULVERT

UTILITY LINE STREAM X-ING WITH DAM AND PUMPING OR WITH PIPE FLUME

TRENCH BREAKER/PLUG

LONGITUDINAL DIVERSION GRADING

SEDIMENT SILT SOXX PROTECTION AT WATER BAR

ROCK CONSTRUCTION ENTRANCE

EROSION CONTROL MATTING

SOIL TYPE & BOUNDARY

# NOTES:

REFER TO DETAIL SHEET 5 FOR "RCE" DETAIL
 REFER TO DETAIL SHEET 5 FOR "AR" DETAIL
 REFER TO DETAIL SHEET 3 FOR "FB" DETAIL.

ACCESS ROAD (AR-15) TO CHESTNUT RIDGE ROAD (C-25)


( IN FERT )

THIS DOCUMENT IS THE PROPERTY OF HANOVER ENGINEERING ASSOCIATES, INC. ANY USE OF A COPY OF THIS DOCUMENT THAT DOES NOT CONTAIN AN ORIGINAL SEAL AND SIGNATURE IS STRICTLY PROHIBITED. THIS DOCUMENT IS NOT PUBLISHED AND ALL RIGHTS ARE RESERVED BY HANOVER ENONEERING ASSOCIATES, INC. THIS PLAN HAS BEEN SEALED WITH EITHER A FED INK SEAL OR A CRIMP SEAL. IF NEITHER APPEARS ON THIS PLAN, POSSIBLE REPRODUCTIONS OR ALTERATIONS MAY HAVE BEEN MADE WITHOUT THE APPEROVAL OR KNOWLEDGE OF THE SIGNATORY.

GRAPHIC SCALE

				E&SPC SHE DET	AIL		
	NO.	REVISIONS	DATE	AVON LAKE GAS ADDITIC	S ADDITION PROJECT		
				CARLISLE, EATON & LAGRANGE TOWNSHIPS AVON, AVON LAKE, ELYRIA & NORTH RIDGEVILLE CITIES LORAIN COUNTY	DRAWN BY: AEJ CHECKED BY: SJC DATE: 12.15.14 SCALE: AS NOTED	PROJECT NO.  NRG-1007  SHEET NO.  7 0 of 88	
SEAL				Hanover Engineering Associates Inc	Bartonsvill 570	oute 611, Suite 1 e, PA 18321-7822 0.688.9550 670.688.9768	

**GENERAL NOTES:** 

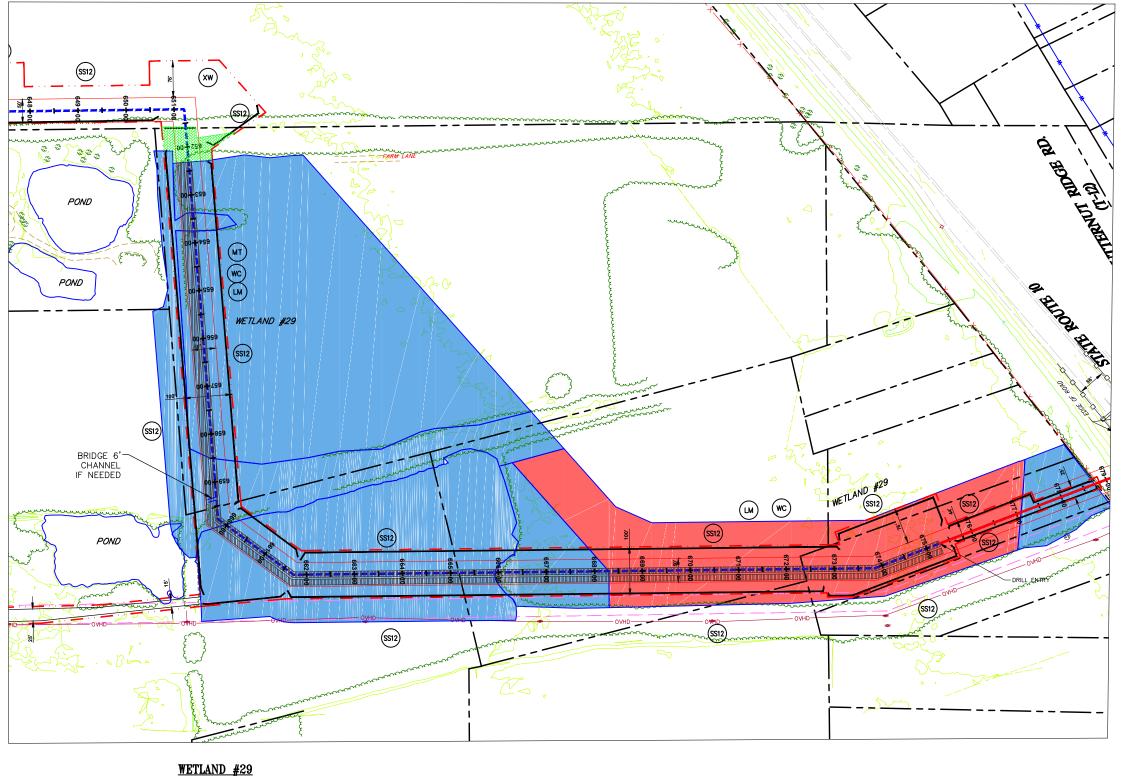

#### NOTES:

- 1. REFER TO DETAIL SHEET 3 FOR "TB/P" DETAIL. ADDITIONAL TRENCH BREAKERS SHALL BE USED IF NEEDED.

  2. REFER TO DETAIL SHEET 3 FOR "NO" DETAIL.

  3. REFER TO DETAIL SHEET 3 FOR "SO" DETAIL.

  4. REFER TO DETAIL SHEET 3 FOR "NO" DETAIL.

  5. PLACE SEDIMENT BRARIER/SIGNAGE AROUND PERIMETER OF WETLAND PRIOR TO ANY EARTHWORK. IF THE CONTRACTOR IS NOT SURE WHERE THE WETLAND "MIMIT" IS, HE SHALL CONTRACT THE OWNER TO HAVE THE WETLAND REMARKED.

  6. THE CONTRACTOR SHALL PLACE LOG MATS TO CROSS THE WETLAND AREA. ALL APPLICABLE WETLAND AREA WITHIN THE LIMITS OF CONSTRUCTION/DISTURBANCE SHALL BOY COMED. THE CONTRACTOR SHALL BE RESPONDIBLE FOR ANY FIRES AND/OR REPAIRS REQUIRED AS A RESULT OF DAMAGE TO WETLANDS AND WATERCOURSES AT NO COST TO THE FACILITY OWNER.

  7. REFER TO DETAIL SHEET 3 FOR "MI" DETAIL:

  a) WETLAND 29 USE BLANKET TYPE S75 OR APPROVED EQUAL, STAPLE PATTERN "C".

  8. REFER TO DETAIL SHEET 3 FOR "FB" DETAIL.



GRAPHIC SCALE ( IN FERT )

THIS DOCUMENT IS THE PROPERTY OF HANOVER ENGINEERING ASSOCIATES, INC. ANY USE OF A COPY OF THIS DOCUMENT THAT DOES NOT CONTAIN AN ORIGINAL SEAL AND SIGNATURE IS STRICTLY PROHIBITED. THIS DOCUMENT IS NOT PUBLISHED AND ALL RIGHTS ARE RESERVED BY HANOVER ENONEERING ASSOCIATES, INC. THIS PLAN HAS BEEN SEALED WITH EITHER A FED INK SEAL OR A CRIMP SEAL. IF NEITHER APPEARS ON THIS PLAN, POSSIBLE REPRODUCTIONS OR ALTERATIONS MAY HAVE BEEN MADE WITHOUT THE APPEROVAL OR KNOWLEDGE OF THE SIGNATORY.

	NO.	REVISIONS	DATE	AVON LAKE GAS ADDITIC	N PROJ	JECT
				CARLISLE, EATON & LAGRANGE TOWNSHIPS  AVON, AVON LAKE, ELYRIA &	DRAWN BY: AEJ CHECKED BY: SJC DATE: 12.15.14	PROJECT NO.  NRG-1007  SHEET NO.
SEAL				Hanover Engineering Associates Inc	Bartonsvill 570	or o

<u>LEGEND</u> INDEX CONTOUR PROPERTY LINE
TEMP. CONSTRUCTION
EASEMENT/LIMIT OF
DISTURBANCE PERMANENT PIPELINE R.O.W. CENTERLINE PIPELINE R.O.W. --- ABOVE GROUND PIPE CONVENTIONAL BORE

FENCE

WETLANDS

FLOW PERENNIAL STREAM FLOW EPHEMERAL/INTERMITTENT

STREAM

OVERHEAD/UTILITY POLE

SOIL TYPE & BOUNDARY SILTSOXX OR EQUIV.

SILTSOXX OR EQUIV. 24" HEIGHT

SILTSOXX OR EQUIV. 32" HEIGHT

STREAMBANK RESTORATION

ROCK FILTER BERM

WETLAND CROSSING

SEDIMENT SILT SOXX PROTECTION AT WATER BAR ACCESS ROAD HIGHWAY BORING HIGHWAY CUT ACCESS RD. X-ING (PAVED ROAD)

ACCESS RD. w/CULVERT UTILITY LINE STREAM X-ING WITH DAM AND PUMPING OR WITH PIPE FLUME TRENCH BREAKER/PLUG LONGITUDINAL DIVERSION GRADING

ROCK CONSTRUCTION ENTRANCE

EROSION CONTROL MATTING

WOODS LINE ... EDGE WOODS

ORD. HIGH WATER MARK ORD. HIGH WATER MARK LINE

LM LOG MAT

BRIDGE

\(\text{\tin\text{

LIMIT OF CONSTRUCTION AND LIMIT OF DISTURBANCE - 235 AC.

E&SPC SITE DETAIL

PEM/PSS PFO

(SS12)\*

(SS24)

(SS32)<sup>®</sup>

RCE

(MT)


SBR

RFB BR

# **GENERAL NOTES:**

<u>LEGEND</u>

# WETLAND #32 (AVOIDANCE)

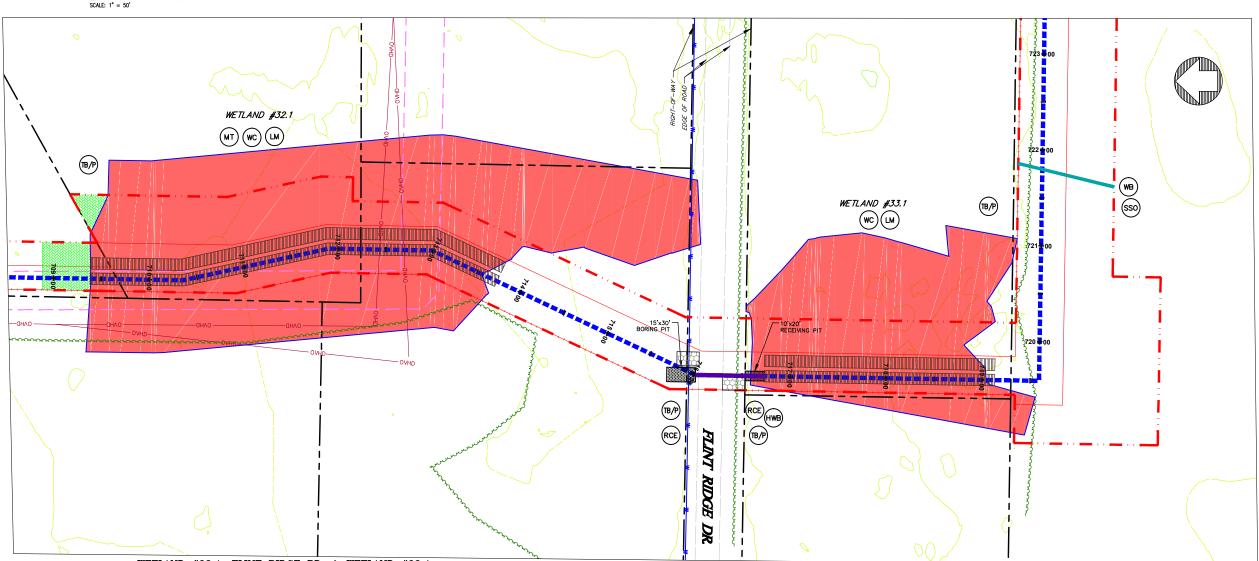

# WETLAND #32.1, FLINT RIDGE RD, & WETLAND #33.1

- 1. REFER TO DETAIL SHEET 3 FOR "TB/P" DETAIL. ADDITIONAL TRENCH BREAKERS SHALL BE USED IF NEEDED.

  2. REFER TO DETAIL SHEET 3 FOR "WC" DETAIL.

  3. PLACE SEDIMENT BARRIER/SIGNAGE AROUND PERIMETER OF WETLAND PRIOR TO ANY EARTHWORK. IF THE CONTRACTOR IS NOT SURE WHERE THE WETLAND "LIMIT" IS, HE SHALL CONTACT THE OWNER TO HAVE THE WETLAND FEMARED.

  4. THE CONTRACTOR SHALL PLACE LOG MATS TO CROSS THE WETLAND AREA ALL APPLICABLE WETLAND AREA WITHIN THE LIMITS OF CONSTRUCTION/DISTURBANCE SHALL BE COVERED. THE CONTRACTOR SHALL BE RESPONSIBLE FOR ANY FINES AND/OR REPAIRS REQUIRED AS A RESULT OF DAMAGE TO WETLANDS AND WATERCOURSES AT NO COST TO THE FACILITY OWNER.

  5. REFER TO DETAIL SHEET 5 FOR "MC" DETAIL.

  6. REFER TO DETAIL SHEET 5 FOR "C" OR DETAIL.

  7. REFER TO DETAIL SHEET 3 FOR "MB" DETAIL.

  8. REFER TO DETAIL SHEET 3 FOR "MB" DETAIL.

  8. REFER TO DETAIL SHEET 3 FOR "MB" DETAIL.

  9. REFER TO DETAIL SHEET 3 FOR "MB" DETAIL.

  9. REFER TO DETAIL SHEET 3 FOR "MB" DETAIL.

# GRAPHIC SCALE ( IN FEET )

THIS DOCUMENT IS THE PROPERTY OF HANOVER ENGINEERING ASSOCIATES, INC. ANY USE OF A COPY OF THIS DOCUMENT THAT DOES NOT CONTAIN AN ORIGINAL SEAL AND SIGNATURE IS STRICTLY PROHIBITED. THIS DOCUMENT IS NOT PUBLISHED AND ALL RIGHTS ARE RESERVED BY HANOVER ENONEERING ASSOCIATES, INC. THIS PLAN HAS BEEN SEALED WITH EITHER A FED INK SEAL OR A CRIMP SEAL. IF NEITHER APPEARS ON THIS PLAN, POSSIBLE REPRODUCTIONS OR ALTERATIONS MAY HAVE BEEN MADE WITHOUT THE APPEROVAL OR KNOWLEDGE OF THE SIGNATORY.

NO.	REVISIONS	DATE	AVON LAKE GAS ADDITIC		JECT
			CARLISLE, EATON & LAGRANGE TOWNSHIPS AVON, AVON LAKE, ELYRIA & NORTH RIDGEVILLE CITIES I ORAIN COUNTY	DRAWN BY:  AEJ  CHECKED BY:  SJC  DATE:  12.15.14  SCALE:  AS NOTED	PROJECT NO.  NRG-1007  SHEET NO.  7 3 OF 88
			Hanover Engineering Associates Inc	Bartonsvill 570	oute 611, Suite 1 e, PA 18321-7822 0.688.9550 670.688.9768

<u>LEGEND</u> INDEX CONTOUR CONTOUR PROPERTY LINE
TEMP. CONSTRUCTION
EASEMENT/LIMIT OF
DISTURBANCE PERMANENT PIPELINE R.O.W.

CENTERLINE PIPELINE R.O.W. ABOVE GROUND PIPE

WOODS LINE WOODS

ORD. HIGH WATER MARK ORD. HIGH WATER MARK LINE

LOG MAT

BRIDGE

SSO

(B/P)

(DE)

E&SPC SITE DETAIL

LIMIT OF CONSTRUCTION AND LIMIT OF DISTURBANCE - 235 AC.

PEM/PSS PFO

(SS12)\*

SS24)

SS32

RCE

(MT)

SBR

(TP)

RFB BR

CONVENTIONAL BORE

SOIL TYPE & BOUNDARY

SILTSOXX OR EQUIV.

SILTSOXX OR EQUIV. 24" HEIGHT

SILTSOXX OR EQUIV. 32" HEIGHT

ROCK CONSTRUCTION ENTRANCE

EROSION CONTROL MATTING

STREAMBANK RESTORATION

ROCK FILTER BERM

WETLAND CROSSING SEDIMENT SILT SOXX PROTECTION AT WATER BAR

ACCESS RD. w/CULVERT UTILITY LINE STREAM X-ING WITH DAM AND PUMPING OR WITH PIPE FLUME

TRENCH BREAKER/PLUG

LONGITUDINAL DIVERSION GRADING

ACCESS ROAD HIGHWAY BORING HIGHWAY CUT ACCESS RD. X-ING (PAVED ROAD)

BRIDGE

FENCE

WETLANDS STONE WALL OVERHEAD/UTILITY POLE FLOW PERENNIAL STREAM FLOW EPHEMERAL/INTERMITTENT

STREAM

SEE DETAIL SHEET 1 FOR SCHEDULE FOR PIPES/BRIDGES.
 STREAM BUFFER IS 25 FEET FROM THE ORDINARY HIGH WATER MARK AND WETLAND BUFFER IS 25 FT. FROM WETLAND BOUNDARY.


**GENERAL NOTES:** 

ROAD.

8. REFER TO DETAIL SHEET 3 FOR "WB" DETAIL.

9. REFER TO DETAIL SHEET 3 FOR "SSO" DETAIL.

10. REFER TO DETAIL SHEET 3 FOR "FB" DETAIL.

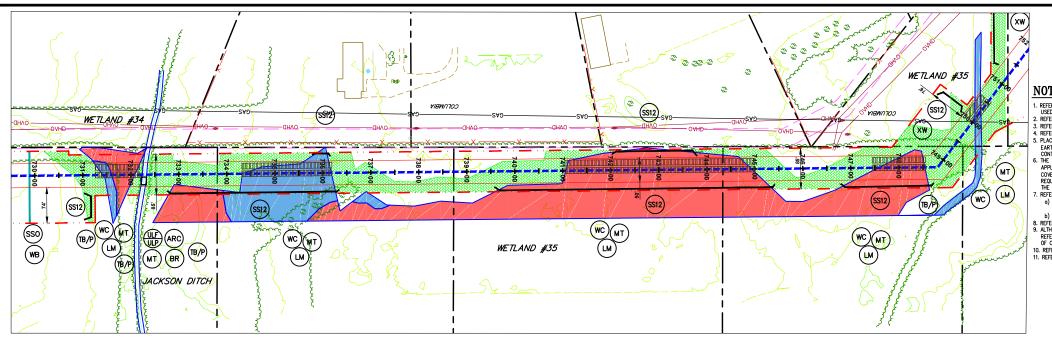

#### WETLAND #34, JACKSON DITCH, & WETLAND #35

SCALE: 1" = 100'

- 1. REFER TO DETAIL SHEET 3 FOR "MB" DETAIL. ADDITIONAL TRENCH BREAKERS SHALL BE USED IF NEEDED.

  2. REFER TO DETAIL SHEET 3 FOR "MB" DETAIL.

  3. REFER TO DETAIL SHEET 3 FOR "SSO" DETAIL.

  4. REFER TO DETAIL SHEET 3 FOR "SSO" DETAIL.

  4. REFER TO DETAIL SHEET 3 FOR "MC" DETAIL.

  5. PLACE SEDMENT BARRIERS/SORAGE AROUND PRIMETER OF WETLAND PRIOR TO ANY EARTHWORK. IF THE CONTRACTOR IS NOT SURE WHERE THE WETLAND "LIMIT" IS, HE SHALL CONTACT THE OWNER TO HAVE THE WETLAND PRIMARED.

  6. THE CONTRACTOR SHALL PLACE LOG MATS TO GROSS THE WETLAND AREA. ALL APPLICABLE WETLAND AREA ALL SECONDED. THE CONTRACTOR SHALL BE RESPONSIBLE FOR ANY FINES AND/OR REPAIRS REQUIRED AS A RESULT OF DAMAGE TO WETLANDS AND WATERCOURSES AT NO COST TO THE FACULTY OWNER.

  7. REFER TO DETAIL SHEET 6 FOR "MT" DETAIL.

  9. WETLAND 454 & 253 USE BLANKET TYPE S75 OR APPROVED EQUAL, STAPLE PATTERN "C".


  19. JACKSON DITCH USE BLANKET TYPE S75 OR APPROVED EQUAL, STAPLE PATTERN "C".
- PATTERN "C".

  ) AJCKSON DITCH USE BLANKET TYPE 575 OR APPROVED EQUAL, STAPLE PATTERN "B".

  8. REFER TO DETAIL SHEET 4 FOR "ULF" OR ULF" DETAIL UTUZE FOR STREAM RORSSNOS.

  9. ALTHOUGH A BRIDGE IS SHOW, A TEMPORARY QULVERT CROSSING MAY BE INSTALLED.
  REFER TO DETAIL SHEET 1 FOR "BR" DETAIL AND FOR THE SPECIFIED SIZE AND NUMBER
  OF QULVERTS.
- 10. REFER TO DETAIL SHEET 4 FOR "ARC" DETAIL.

  11. REFER TO DETAIL SHEET 3 FOR "FB" DETAIL.

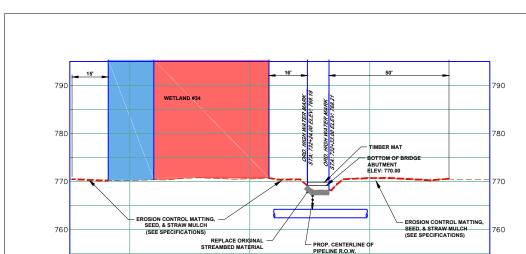

# JACKSON DITCH PROFILE (ON 22x34 SHEET) HORIZONTAL GRAPHIC SCALE ( IN FEET ) 1 inch = 20 ft. (ON 22x34 SHEET) GRAPHIC SCALE ( IN FRET )

NO.

REVISIONS

## JACKSON DITCH

732+00

## E&SPC SITE DETAIL AVON LAKE GAS ADDITION PROJECT

<u>LEGEND</u> INDEX CONTOUR CONTOUR

CENTERLINE PIPELINE R.O.W.

FENCE

WETLANDS

FLOW PERENNIAL STREAM FLOW EPHEMERAL/INTERMITTENT

STREAM

---- ABOVE GROUND PIPE

WOODS LINE ... EDGE WOODS

ORD. HIGH WATER MARK ORD. HIGH WATER MARK LINE

LM LOG MAT

BRIDGE

TB/P

(LDG)

LIMIT OF CONSTRUCTION AND LIMIT OF DISTURBANCE - 235 AC.

PEM/PSS PFO

(SS12)\*

(SS24)

SS32)\*\*

RCE

(MT)

SBR

RFB BR

PROPERTY LINE
TEMP. CONSTRUCTION
EASEMENT/LIMIT OF
DISTURBANCE

PERMANENT PIPELINE R.O.W.

CONVENTIONAL BORE

OVERHEAD/UTILITY POLE

SOIL TYPE & BOUNDARY

SILTSOXX OR EQUIV. 12" HEIGHT

SILTSOXX OR EQUIV. 24" HEIGHT

SILTSOXX OR EQUIV. 32" HEIGHT

ROCK CONSTRUCTION ENTRANCE

STREAMBANK RESTORATION

ROCK FILTER BERM

WETLAND CROSSING SEDIMENT SILT SOXX PROTECTION AT WATER BAR

ACCESS ROAD

HIGHWAY CUT ACCESS RD. X-ING (PAVED ROAD)


ACCESS RD. w/CULVERT

UTILITY LINE STREAM X-ING WITH DAM AND PUMPING OR WITH PIPE FLUME

TRENCH BREAKER/PLUG

LONGITUDINAL DIVERSION GRADING

EROSION CONTROL MATTING

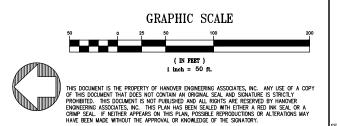

		CARLISLE, EATON & LAGRANGE TOWNSHIPS AVON, AVON LAKE, ELYRIA &	DRAWN BY: AEJ CHECKED BY: SJC DATE: 12.15.14 SCALE: AS NOTED	PROJECT NO.  NRG-1007  SHEET NO.  74 OF 88
AL.		Hanover Engineering Associates Inc	3355 Ro Bartonsvill 570	oute 611, Suite 1 e, PA 18321-7822 0.688.9550 570.688.9768


DATE


731 + 25


**GENERAL NOTES:** SEE DETAIL SHEET 1 FOR SCHEDULE FOR PIPES/BRIDGES.
 STREAM BUFFER IS 25 FEET FROM THE ORDINARY HIGH WATER MARK AND WETLAND BUFFER IS 25 FT. FROM WETLAND BOUNDARY.

PIPELINE R.O.W. MIN. 4 FT. VERTICAL SEPARATION


733+00

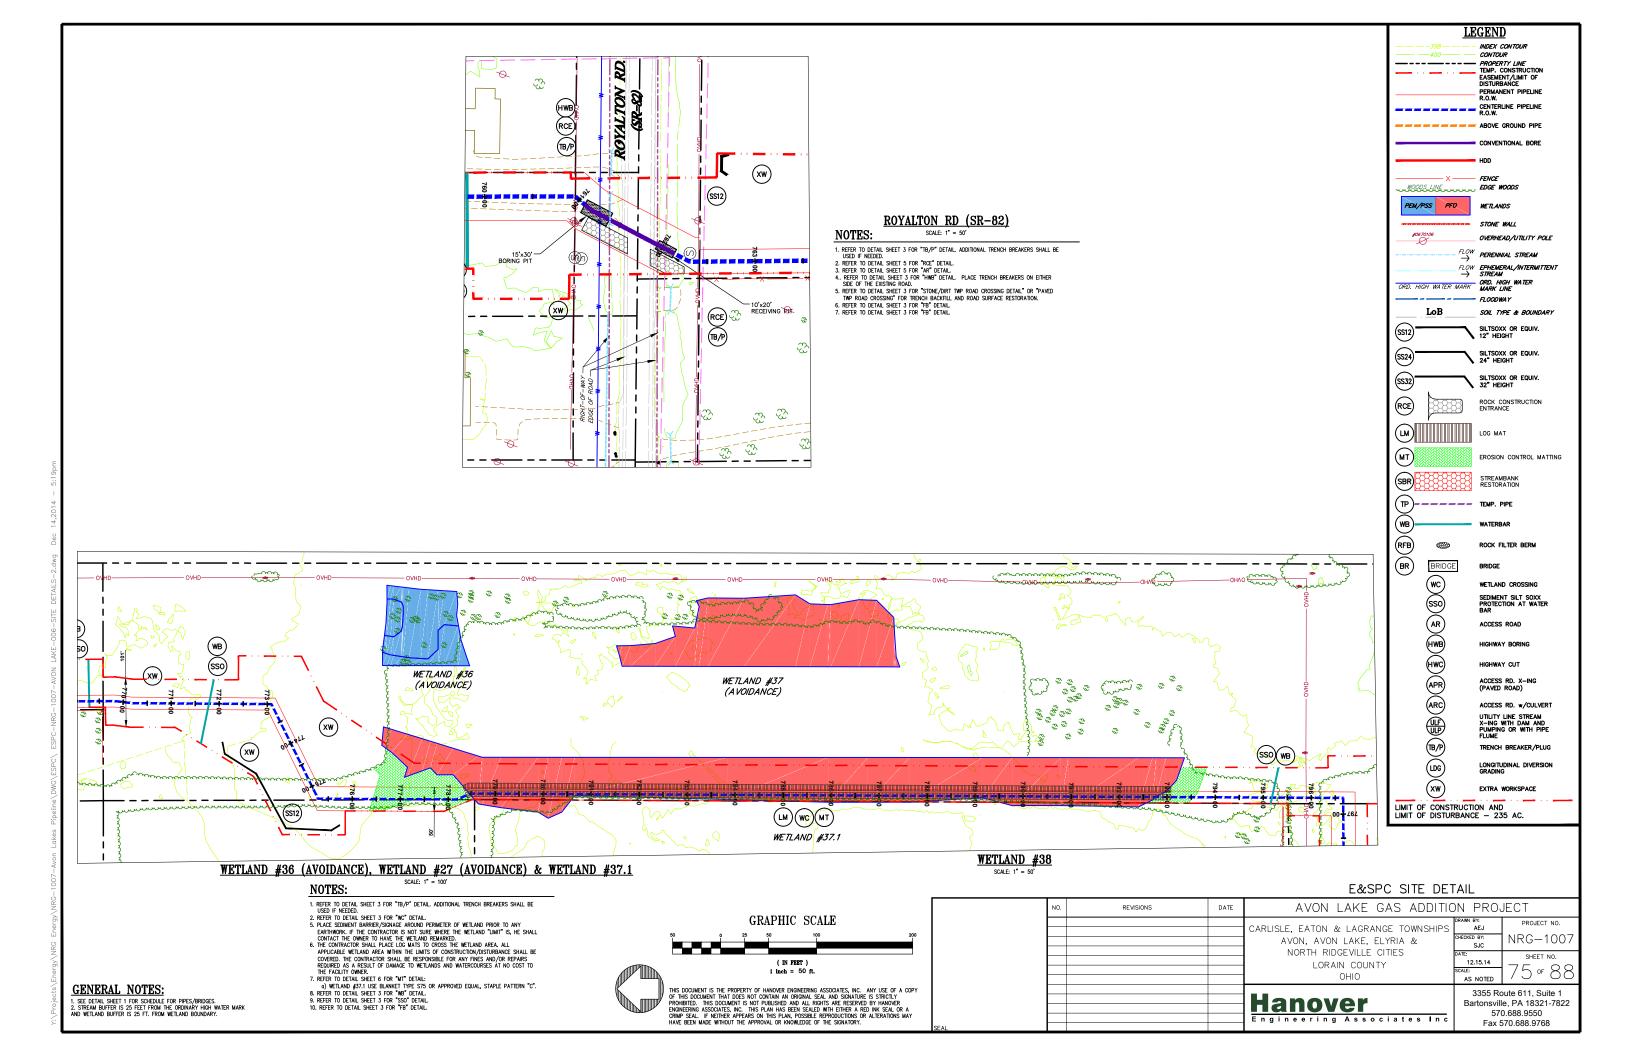

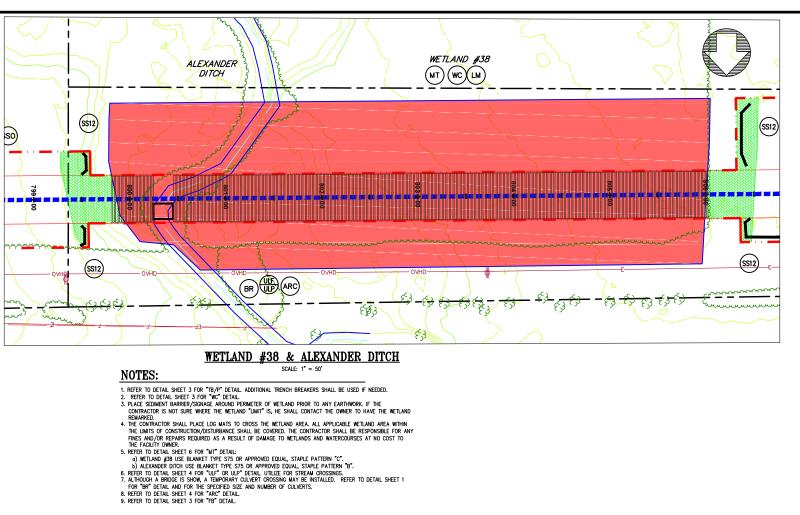

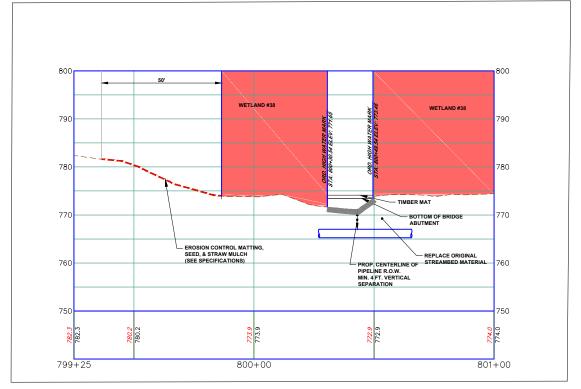

#### ALEXANDER DITCH PROFILE

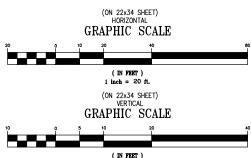

1 inch = 10 ft.

CAPEL RD NOTES:

REFER TO DETAIL SHEET 3 FOR "TB/P" DETAIL ADDITIONAL TRENCH BREAKERS SHALL BE USED IF NEEDED.
 REFER TO DETAIL SHEET 5 FOR "RCE" DETAIL.
 REFER TO DETAIL SHEET 3 FOR "HIMB" DETAIL. PLACE TRENCH BREAKERS ON EITHER SIDE OF THE EXISTING ROAD.
 REFER TO DETAIL SHEET 3 FOR "STONE/DIRT THP ROAD CROSSING DETAIL" OR "PAVED THP ROAD CROSSING" FOR TRENCH BACKFULL AND ROAD SURFACE RESTORATION.
 REFER TO DETAIL SHEET 3 FOR "FB" DETAIL.

RD.

RCE


(TB/P)

(SS12)

xw

15'x30' — BORING PIT

RCE

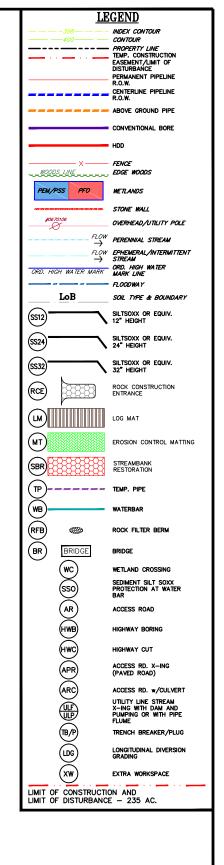

#### E&SPC SITE DETAIL

				Eddi O Sile Dei	/ \\L	
	NO.	REVISIONS	DATE	AVON LAKE GAS ADDITIC	N PROJ	JECT
				CARLISLE, EATON & LAGRANGE TOWNSHIPS AVON, AVON LAKE, ELYRIA & NORTH RIDGEVILLE CITIES LORAIN COUNTY	DRAWN BY: AEJ CHECKED BY: SJC DATE: 12.15.14 SCALE: AS NOTED	PROJECT NO.  NRG-1007  SHEET NO.  76 OF 88
seal.				Hanover Engineering Associates Inc	Bartonsville 570	oute 611, Suite 1 e, PA 18321-7822 0.688.9550 670.688.9768

(xw)

(WB) (SSO)


# GRAPHIC SCALE ( IN FEET )

THIS DOCUMENT IS THE PROPERTY OF HANOVER ENGINEERING ASSOCIATES, INC. ANY USE OF A COPY OF THIS DOCUMENT THAT DOES NOT CONTAIN AN ORIGINAL SEAL AND SIGNATURE IS STRICTLY PROHIBITED. THIS DOCUMENT IS NOT PUBLISHED AND ALL RIGHTS ARE RESERVED BY HANOVER ENGINEERING ASSOCIATES, INC. THIS PLAN HAS BEEN SEALED WITH ETHER A FED INK SEAL OR A CRIMP SEAL. IF NEITHER APPEARS ON THIS PLAN, POSSIBLE REPRODUCTIONS OR ALTERATIONS MAY HAVE BEEN MADE WITHOUT THE APPROVAL OR KNOWLEDGE OF THE SIGNATORY.

#### **GENERAL NOTES:**


BOTTOM OF BRIDG - EROSION CONTROL MATTING SEED, & STRAW MULCH (SEE SPECIFICATIONS) REPLACE ORIGINAL STREAMBED MATERIAL PROP. CENTERLINE OF PIPELINE R.O.W. MIN. 4 FT. VERTICAL SEPARATION 832+75 833+00 833+75

#### UNNAMED STREAM #4 PROFILE

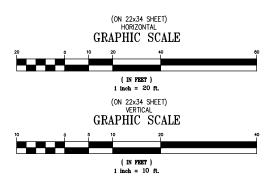

NOTES:

- 1. REFER TO DETAIL SHEET 3 FOR "IB/P" DETAIL ADDITIONAL TRENCH BREAKERS SHALL BE USED IF NEEDED.
  2. REFER TO DETAIL SHEET 6 FOR "M" DETAIL:
  3. OLNNAMED SITECAM #4 USE BLANKET TYPE 575 OR APPROVED EQUAL, STAPLE PATTERN "B".
  3. REFER TO DETAIL SHEET 4 FOR "ULF" OR ULP" DETAIL. UTILIZE FOR SITEAM CROSSINGS.
  4. ALTHOUGH A BRIDGE IS SHOW, A TEMPORARY CULVERT CROSSING MAY BE INSTALLED. REFER TO DETAIL SHEET 1 FOR "BR" DETAIL AND FOR THE SPECIFIED SZE AND NUMBER OF CULVERTS.
  5. REFER TO DETAIL SHEET 3 FOR "FB" DETAIL.

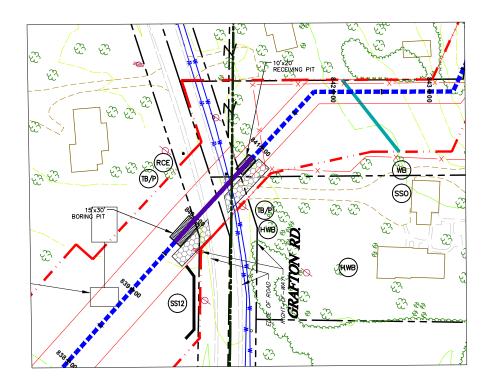

#### NOTES:

GRAFTON RD.

1. REFER TO DETAIL SHEET 3 FOR "TB/P" DETAIL. ADDITIONAL TRENCH BREAKERS SHALL BE USED IF NEEDED.
2. REFER TO DETAIL SHEET 3 FOR "STONE/DIRT TWP ROAD CROSSING DETAIL" OR "PAVED TWP ROAD CROSSING" FOR TRENCH BACKFILL AND ROAD SUFFACE RESTORATION.
4. REFER TO DETAIL SHEET 3 FOR "5"B" DETAIL.

#### F&SPC SITE DETAIL

<u>LEGEND</u> INDEX CONTOUR

CENTERLINE PIPELINE R.O.W.

ABOVE GROUND PIPE

WOODS LINE WOODS

ORD. HIGH WATER MARK ORD. HIGH WATER MARK LINE

LM LOG MAT

PEM/PSS PFO

(SS12)\*

(SS24)

SS32)\*\*

RCE

(MT)

SBR

RFB BR

(B/P)

(LDG)

LIMIT OF CONSTRUCTION AND LIMIT OF DISTURBANCE - 235 AC.

CONTOUR PROPERTY LINE
TEMP. CONSTRUCTION
EASEMENT/LIMIT OF
DISTURBANCE PERMANENT PIPELINE R.O.W.

CONVENTIONAL BORE

OVERHEAD/UTILITY POLE

SOIL TYPE & BOUNDARY

SILTSOXX OR EQUIV.

SILTSOXX OR EQUIV. 24" HEIGHT

SILTSOXX OR EQUIV. 32" HEIGHT

ROCK CONSTRUCTION ENTRANCE

EROSION CONTROL MATTING

STREAMBANK RESTORATION

ROCK FILTER BERM

WETLAND CROSSING SEDIMENT SILT SOXX PROTECTION AT WATER BAR

ACCESS ROAD

HIGHWAY CUT ACCESS RD. X-ING (PAVED ROAD)

ACCESS RD. w/CULVERT UTILITY LINE STREAM X-ING WITH DAM AND PUMPING OR WITH PIPE FLUME

TRENCH BREAKER/PLUG

LONGITUDINAL DIVERSION GRADING

FENCE

WETLANDS

FLOW PERENNIAL STREAM FLOW EPHEMERAL/INTERMITTENT

STREAM




GRAPHIC SCALE ( IN FEET )

THIS DOCUMENT IS THE PROPERTY OF HANOVER ENGINEERING ASSOCIATES, INC. ANY USE OF A COPY OF THIS DOCUMENT THAT DOES NOT CONTAIN AN ORIGINAL SEAL AND SIGNATURE IS STRICTLY PROHIBITED. THIS DOCUMENT IS NOT PUBLISHED AND ALL RIGHTS ARE RESERVED BY HANOVER ENONEERING ASSOCIATES, INC. THIS PLAN HAS BEEN SEALED WITH EITHER A FED INK SEAL OR A CRIMP SEAL. IF NEITHER APPEARS ON THIS PLAN, POSSIBLE REPRODUCTIONS OR ALTERATIONS MAY HAVE BEEN MADE WITHOUT THE APPEROVAL OR KNOWLEDGE OF THE SIGNATORY.


				Lasi C Sill Dei	\_	
	NO.	REVISIONS	DATE	AVON LAKE GAS ADDITIC	N PROJ	JECT
				CARLISLE, EATON & LAGRANGE TOWNSHIPS AVON, AVON LAKE, ELYRIA & NORTH RIDGEVILLE CITIES LORAIN COUNTY	DRAWN BY:  AEJ  CHECKED BY:  SJC  DATE:  12.15.14  SCALE:  AS NOTED	PROJECT NO.  NRG—1007  SHEET NO.  77 OF 88
AL.				Hanover Engineering Associates Inc	Bartonsville 570	ute 611, Suite 1 e, PA 18321-7822 0.688.9550 0.70.688.9768

**GENERAL NOTES:** 

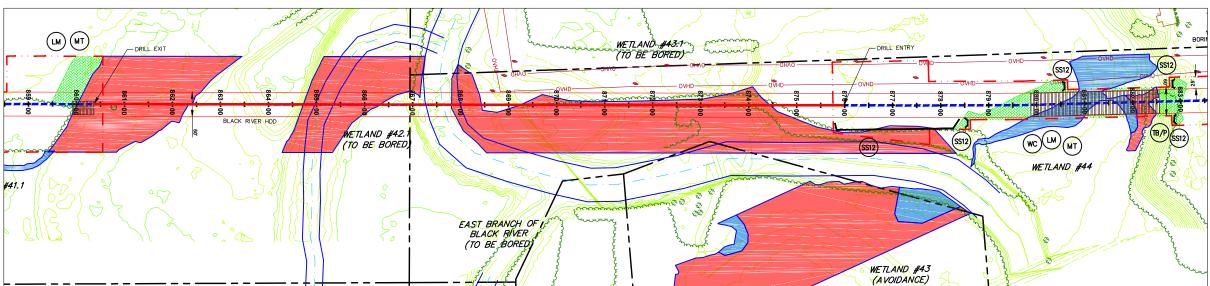

#### WETLAND #42.1, BLACK RIVER, WETLAND #43 (AVOIDANCE), WETLAND #43.1 & WETLAND #44 SCALE: 1" = 100"

BLACK RIVER HDD

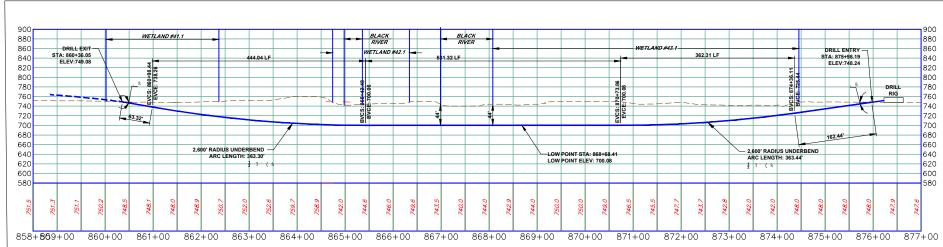

#### NOTES:

- INCITEDS:

  1. REFER TO DETAIL SHEET 3 FOR "TB/P" DETAIL. ADDITIONAL TRENCH BREAKERS SHALL BE USED IF NEEDED.

  2. REFER TO DETAIL SHEET 3 FOR "NC" DETAIL.

  3. PLACE SEDIMENT BARRERY/SIGNAGE AROUND PERMIETER OF WETLAND PRIOR TO ANY EARTHWORK. IF THE CONTRACTOR IS NOT SURE WHERE THE WETLAND "LIMIT" IS, HE SHALL CONTACT THE OWNER TO HAVE THE WELLAND BRAAKE.

  4. THE CONTRACTOR SHALL PLACE LOG MATS TO CROSS THE WETLAND AREA. ALL APPLICABLE WETLAND AREA WITHIN THE LIMITS OF CONSTRUCTION/DISTURBANCE SHALL BE COVERED. THE CONTRACTOR SHALL BE RESPONSIBLE FOR ANY FINES AND/OR REPAIRS REQUIRED AS A RESULT OF DAMAGE TO WETLANDS AND WATERCOURSES AT NO COST TO THE FACULTY OWNER.

  5. REFER TO DETAIL SHEET 3 FOR "IN" DETAIL:

  (a) WETLAND 444 USE BLANKET TYPE S75 OR APPROVED EQUAL, STAPLE PATTERN "C".

E&SPC SITE DETAIL

<u>LEGEND</u> INDEX CONTOUR

CENTERLINE PIPELINE R.O.W. ABOVE GROUND PIPE

FENCE

WETLANDS

 $\stackrel{\mathit{FLOW}}{\rightarrow}$  perennial stream FLOW EPHEMERAL/INTERMITTENT

STREAM

WOODS LINE ..... EDGE WOODS

ORD. HIGH WATER MARK ORD. HIGH WATER MARK LINE

LM LOG MAT

BRIDGE

TB/P

(DE)

LIMIT OF CONSTRUCTION AND LIMIT OF DISTURBANCE - 235 AC.

PEM/PSS PFO

(SS12)

(SS24)

(SS32)<sup>®</sup>

RCE

(MT)

SBR

(TP)

)(RFB)(BR)

CONTOUR PROPERTY LINE
TEMP. CONSTRUCTION
EASEMENT/LIMIT OF
DISTURBANCE

PERMANENT PIPELINE R.O.W.

CONVENTIONAL BORE

OVERHEAD/UTILITY POLE

SOIL TYPE & BOUNDARY

SILTSOXX OR EQUIV. 12" HEIGHT

SILTSOXX OR EQUIV. 24" HEIGHT

SILTSOXX OR EQUIV. 32" HEIGHT

STREAMBANK RESTORATION

ROCK FILTER BERM

WETLAND CROSSING

SEDIMENT SILT SOXX PROTECTION AT WATER BAR

ACCESS ROAD

HIGHWAY CUT

ACCESS RD. X-ING (PAVED ROAD)

ACCESS RD. w/CULVERT

UTILITY LINE STREAM X-ING WITH DAM AND PUMPING OR WITH PIPE FLUME

TRENCH BREAKER/PLUG

LONGITUDINAL DIVERSION GRADING


ROCK CONSTRUCTION ENTRANCE


EROSION CONTROL MATTING

(ON 22x34 SHEET) HORIZONTAL & VERTICAL GRAPHIC SCALE ( IN FEET )

THIS DOCUMENT IS THE PROPERTY OF HANOVER ENGINEERING ASSOCIATES, INC. ANY USE OF A COPY OF THIS DOCUMENT THAT DOES NOT CONTAIN AN ORIGINAL SEAL AND SIGNATURE IS STRICTLY PROHIBITED. THIS DOCUMENT IS NOT PUBLISHED AND ALL RIGHTS ARE RESERVED BY HANOVER ENOINEERING ASSOCIATES, INC. THIS PLAN HAS BEEN SEALED WITH EITHER A FED INK SEAL OR A CRIMP SEAL IF NEITHER APPEARS ON THIS PLAN, POSSIBLE REPRODUCTIONS OR ALTERATIONS MAY HAVE BEEN MADE WITHOUT THE APPEROVAL OR KNOMLEDGE OF THE SIGNATORY.

NO.	REVISIONS	DATE	AVON LAKE GAS ADDITIC	N PROJ	JECT
			CARLISLE, EATON & LAGRANGE TOWNSHIPS AVON, AVON LAKE, ELYRIA & NORTH RIDGEVILLE CITIES	DRAWN BY: AEJ CHECKED BY: SJC DATE: 12.15.14	PROJECT NO.  NRG—100  SHEET NO.
			LORAIN COUNTY OHIO	SCALE: AS NOTED	78 of 88
			Hanover Engineering Associates Inc	Bartonsvill 570	oute 611, Suite 1 e, PA 18321-7822 0.688.9550 670.688.9768

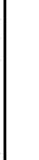


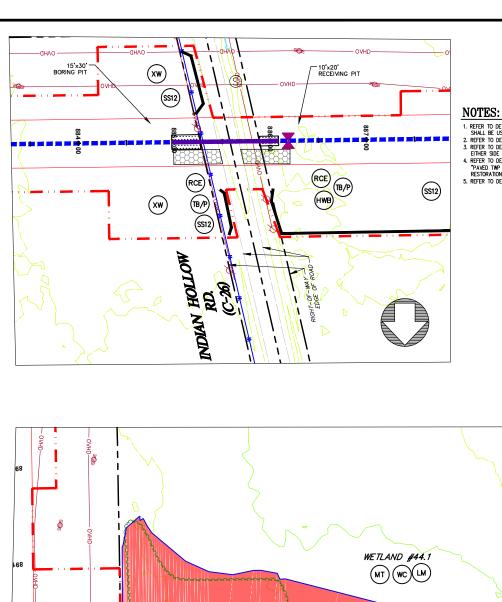

#### INDIAN HOLLOW ROAD

SCALE: 1" = 50"

- 1. REFER TO DETAIL SHEET 3 FOR "TB/P" DETAIL. ADDITIONAL TRENCH BREAKERS SHALL BE USED IF NEEDED.
  2. REFER TO DETAIL SHEET 5 FOR "RCE" OR "BRCE" DETAIL.
  3. REFER TO DETAIL SHEET 3 FOR "HWB" DETAIL. PLACE TRENCH BREAKERS ON EITHER SIDE OF THE EXISTING ROAD.
  4. REFER TO DETAIL SHEET 3 FOR "STONE/DIRT TWP ROAD CROSSING DETAIL" OR "PAVED TWP ROAD CROSSING" FOR TRENCH BACKFILL AND ROAD SURFACE RESTORATION.
  5. REFER TO DETAIL SHEET 3 FOR "FB" DETAIL.

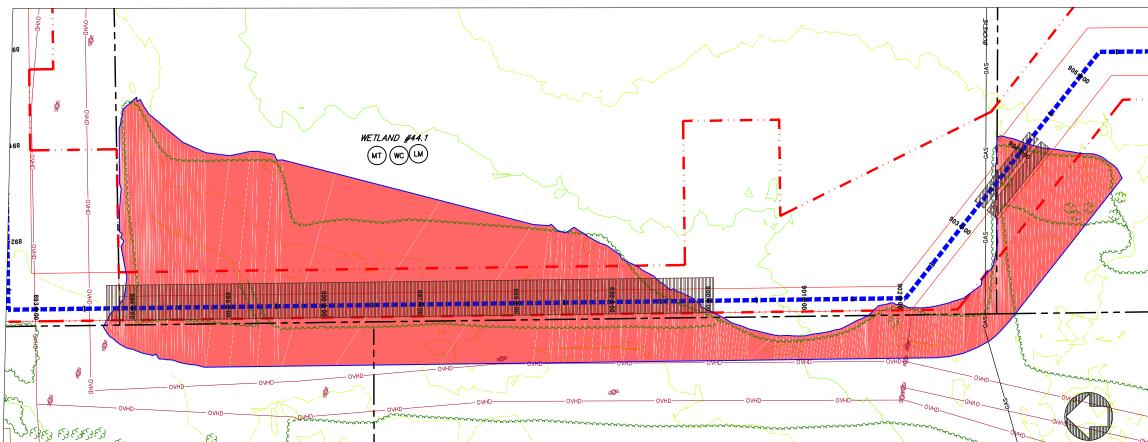

#### <u>WETLAND #44.1</u> SCALE: 1" = 50'

#### NOTES:


- 1. REFER TO DETAIL SHEET 3 FOR "TB/P" DETAIL ADDITIONAL TRENCH BREAKERS SHALL BE USED IF NEEDED.

  2. REFER TO DETAIL SHEET 3 FOR "WC" DETAIL.

  3. PLACE SEDIMENT BARRIER/SIGNAGE AROUND PERMIETER OF WEITLAND FROR TO ANY EARTHWORK. IF THE CONTRACTOR IS NOT SURE WHERE THE WEITLAND LIANT IS, HE SHALL CONTRACT THE OWNER TO HAVE THE WEITLAND REALAND REMARKED.

  4. THE CONTRACTOR SHALL PLACE LOG MATS TO CROSS THE WEITLAND AREA. ALL APPLICABLE WEITLAND AREA. WHIN THE LIMITS OF CONSTRUCTION/DISJUSTBANCE SHALL BE COVERED. THE CONTRACTOR SHALL BE RESPONSIBLE FOR MAY THIS AMO/OR REPARS REQUIRED AS A RESULT OF DAMAGE TO WEITLANDS ON WATERCOURSES AT NO COST TO THE FACILITY OF THE PRICE OF
- OWNER.

  5. REFER TO DETAIL SHEET 3 FOR "FB" DETAIL.

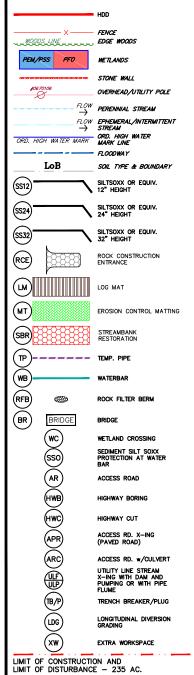

<u>LEGEND</u> INDEX CONTOUR CONTOUR PROPERTY LINE
TEMP. CONSTRUCTION
EASEMENT/LIMIT OF
DISTURBANCE

CENTERLINE PIPELINE R.O.W.

ABOVE GROUND PIPE

PERMANENT PIPELINE R.O.W.

CONVENTIONAL BORE

#### E&SPC SITE DETAIL

# GRAPHIC SCALE ( IN FEET )

THIS DOCUMENT IS THE PROPERTY OF HANOVER ENGINEERING ASSOCIATES, INC. ANY USE OF A COPY OF THIS DOCUMENT THAT DOES NOT CONTAIN AN ORIGINAL SEAL AND SIGNATURE IS STRICTLY PROHIBITED. THIS DOCUMENT IS NOT PUBLISHED AND ALL RICHARD ARE RESERVED BY HANOVER ENGINEERING ASSOCIATES, INC. THIS PLAN HAS BEEN SEALED WITH EITHER A PEED INK SEAL OR A CRIMP SEAL. IF NEITHER APPEARS ON THIS PLAN, POSSIBLE REPRODUCTIONS OR ALTERATIONS MAY HAVE BEEN MADE WITHOUT THE APPROVAL OR NONDIEDGE OF THE SIGNATORY.

NO.	REVISIONS	DATE	AVON LAKE GAS ADDITION PROJECT				
			CARLISLE, EATON & LAGRANGE TOWNSHIPS AVON, AVON LAKE, ELYRIA & NORTH RIDGEVILLE CITIES LORAIN COUNTY	DRAWN BY: AEJ CHECKED BY: SJC DATE: 12.15.14 SCALE:	PROJECT NO.  NRG-1007  SHEET NO.  7 9 of 8 8		
			Hanover Engineering Associates Inc	Bartonsvill 57	oute 611, Suite 1 le, PA 18321-7822 0.688.9550 570.688.9768		



## WETLAND #45 & WETLAND #45.1

SCALE: 1" = 50'

#### NOTES:


- NOTES:

  1. REFER TO DETAIL SHEET 3 FOR "TB/P" DETAIL ADDITIONAL TRENCH BREAKERS SHALL BE USED IF NEEDED.

  2. REFER TO DETAIL SHEET 3 FOR "NC" DETAIL.

  3. PLACE SEMBINET BARRIERS/SIGNAGE AROUND PERMETER OF WETLAND PRIOR TO ANY EARTHWORK. IF THE CONTRACTOR SNOT SURE WHERE THE WETLAND TLANT IS, HE SHALL CONTACT THE OWNER TO HAVE THE WETLAND BRAMPRICD.

  3. THE CONTRACTOR SHALL PLACE LOS MATS TO CROSS THE WETLAND AREA, ALL APPLICABLE WETLAND AREA WITHIN THE LIMITS OF CONSTRUCTION, DISTURBANCE SHALL BE COVERED. THE CONTRACTOR SHALL BE RESPONSIBLE FOR ANY FINES AND/OR REPARK FOOGURED AS A RESULT OF DAMAGE TO WETLANDS AND WATERCOURSES AT NO COST TO MET ADOLL TO MAKE A WITHIN SHALL OF DAMAGE OF WETLAND AND AS MASS AND TO SHALL OF DAMAGE OF WETLANDS AND WATERCOURSES AT NO COST TO MET ADOLL TO METLAND AND AS MASS AND TO DETAIL SHEET OF TOWN TO PETAIL OF DETAIL SHEET 3 FOR "TB" DETAIL.

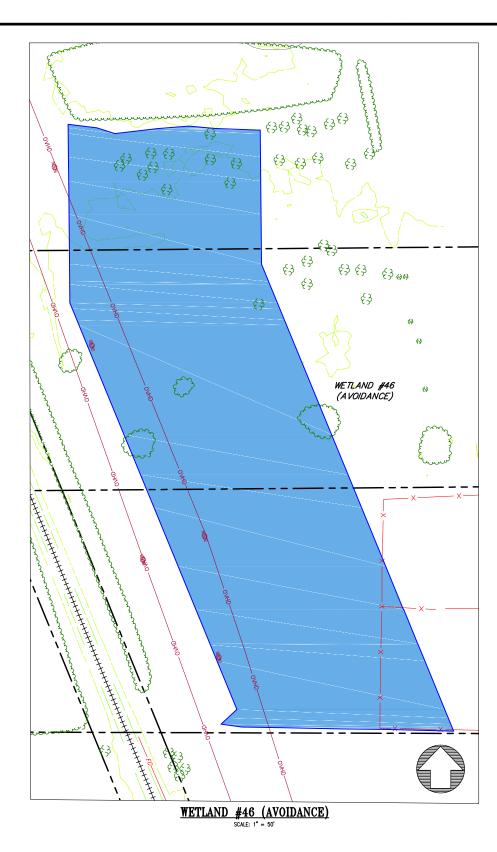



<u>LEGEND</u> INDEX CONTOUR CONTOUR PROPERTY LINE
TEMP. CONSTRUCTION
EASEMENT/LIMIT OF
DISTURBANCE PERMANENT PIPELINE R.O.W.

CENTERLINE PIPELINE R.O.W.

ABOVE GROUND PIPE

WOODS LINE WOODS

ORD. HIGH WATER MARK ORD. HIGH WATER MARK LINE

LM LOG MAT

PEM/PSS PFO

(SS12)\*

(SS24)

SS32)\*\*

RCE

(MT)

SBR

RFB BR

LIMIT OF CONSTRUCTION AND LIMIT OF DISTURBANCE - 235 AC.

FENCE

WETLANDS

CONVENTIONAL BORE

OVERHEAD/UTILITY POLE FLOW PERENNIAL STREAM

SOIL TYPE & BOUNDARY

FLOW EPHEMERAL/INTERMITTENT

STREAM

SILTSOXX OR EQUIV.

SILTSOXX OR EQUIV. 24" HEIGHT

SILTSOXX OR EQUIV. 32" HEIGHT

STREAMBANK RESTORATION

ROCK FILTER BERM

WETLAND CROSSING SEDIMENT SILT SOXX PROTECTION AT WATER BAR ACCESS ROAD


HIGHWAY CUT

ACCESS RD. X-ING (PAVED ROAD)

ACCESS RD. w/CULVERT UTILITY LINE STREAM X-ING WITH DAM AND PUMPING OR WITH PIPE FLUME TRENCH BREAKER/PLUG LONGITUDINAL DIVERSION GRADING

ROCK CONSTRUCTION ENTRANCE

EROSION CONTROL MATTING

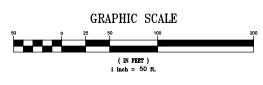

THIS DOCUMENT IS THE PROPERTY OF HANOVER ENGINEERING ASSOCIATES, INC. ANY USE OF A COPY OF THIS DOCUMENT THAT DOES NOT CONTAIN AN ORIGINAL SEAL AND SIGNATURE IS STRICTLY PROHIBITED. THIS DOCUMENT IS NOT PUBLISHED AND ALL RICHARD ARE RESERVED BY HANOVER ENGINEERING ASSOCIATES, INC. THIS PLAN HAS BEEN SEALED WITH EITHER A PEED INK SEAL OR A CRIMP SEAL. IF NEITHER APPEARS ON THIS PLAN, POSSIBLE REPRODUCTIONS OR ALTERATIONS MAY HAVE BEEN MADE WITHOUT THE APPROVAL OR NONDIEDGE OF THE SIGNATORY.

				Easi o sile dei	/ \IL		
	NO.	REVISIONS	DATE	AVON LAKE GAS ADDITION PROJECT			
				CARLISLE, EATON & LAGRANGE TOWNSHIPS AVON, AVON LAKE, ELYRIA & NORTH RIDGEVILLE CITIES I ORAIN COUNTY	DRAWN BY: AEJ CHECKED BY: SJC DATE: 12.15.14 SCALE: AS NOTED	PROJECT NO.  NRG—1007  SHEET NO.  8 0 of 88	
SEAL				Hanover Engineering Associates Inc	Bartonsville 570	oute 611, Suite 1 le, PA 18321-7822 0.688.9550 570.688.9768	

#### **GENERAL NOTES:**

SCALE: 1" = 50'


#### NOTES:

- REFER TO DETAIL SHEET 3 FOR "TB/P" DETAIL. ADDITIONAL TRENCH BREAKERS SHALL BE USED IF NEEDED.
- USED IN NEUDED.

  2. REFER TO DETAIL SHEET 5 FOR "RCE" OR "BRCE" DETAIL.

  3. REFER TO DETAIL SHEET 3 FOR "HWB" DETAIL. PLACE TRENCH BREAKERS ON EITHER SIDE OF THE EXISTING ROAD.

  4. REFER TO DETAIL SHEET 3 FOR "FB" DETAIL.

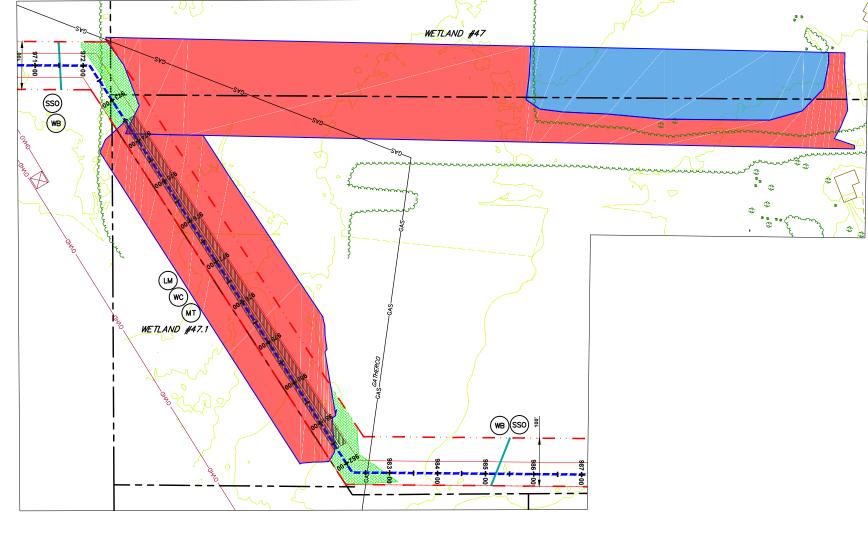

#### WETLAND #47 & WETLAND #47.1

NOTES:

- 1. REFER TO DETAIL SHEET 3 FOR "IB/P" DETAIL ADDITIONAL TRENCH BREAKERS SHALL BE USED IF NEEDED.

  2. REFER TO DETAIL SHEET 3 FOR "WB" DETAIL.

  3. REFER TO DETAIL SHEET 3 FOR "WB" DETAIL.

  4. REFER TO DETAIL SHEET 3 FOR "WB" DETAIL.

  5. PLACE SEDIMENT BARRIER/SIGNAGE AROUND PERMETER OF WETLAND PRIOR TO ANY EARTHWORK. IF THE CONTRACTOR IS NOT SURE WHERE THE WETLAND "LIMIT" IS, HE SHALL CONTACT THE OWNER TO HAVE THE WETLAND REMARKED.

  6. THE CONTRACTOR SHALL PLACE LOG MAIS TO CROSS THE WETLAND AREA. ALL APPLICABLE WETLAND AREA WITHIN THE LIMITS OF CONSTRUCTION/DISTURBANCE SHALL BE COVERD. THE CONTRACTOR SHALL BE RESONISBLE FOR ANY PIRES AND/OR REPAIRS REQUIRED AS A RESULT OF DAMAGE TO WETLANDS AND WATERCOURSES AT NO COST TO THE FACULTY OWNER.

  7. REFER TO DETAIL SHEET 6 FOR "M1" DETAIL:

  9. WETLAND 472 & 47.1 USE BLANKET TYPE 575 OR APPROVED EQUAL, STAPLE PATTERN "C".

  8. REFER TO DETAIL SHEET 3 FOR "B" DETAIL.

## E&SPC SITE DETAIL

<u>LEGEND</u> INDEX CONTOUR CONTOUR PROPERTY LINE
TEMP. CONSTRUCTION
EASEMENT/LIMIT OF
DISTURBANCE PERMANENT PIPELINE R.O.W.

CENTERLINE PIPELINE R.O.W.

FENCE

WETLANDS STONE WALL

CONVENTIONAL BORE

OVERHEAD/UTILITY POLE FLOW PERENNIAL STREAM FLOW EPHEMERAL/INTERMITTENT

STREAM

SOIL TYPE & BOUNDARY

SILTSOXX OR EQUIV. 12" HEIGHT

SILTSOXX OR EQUIV. 24" HEIGHT

SILTSOXX OR EQUIV. 32" HEIGHT

STREAMBANK RESTORATION

ROCK FILTER BERM

WETLAND CROSSING SEDIMENT SILT SOXX PROTECTION AT WATER BAR

ACCESS ROAD

HIGHWAY BORING

TRENCH BREAKER/PLUG

LONGITUDINAL DIVERSION GRADING

HIGHWAY CUT ACCESS RD. X-ING (PAVED ROAD) ACCESS RD. w/CULVERT UTILITY LINE STREAM X-ING WITH DAM AND PUMPING OR WITH PIPE FLUME

BRIDGE

ROCK CONSTRUCTION ENTRANCE

EROSION CONTROL MATTING

ABOVE GROUND PIPE

WOODS LINE WOODS

ORD. HIGH WATER MARK ORD. HIGH WATER MARK LINE

LOG MAT

BRIDGE

\(\text{\text{\$\beta\$}}\) \(\text{\text{\$\be

(B/P)

(DE)

LIMIT OF CONSTRUCTION AND LIMIT OF DISTURBANCE - 235 AC.

PEM/PSS PFO

(SS12)\*

SS24)


SS32

RCE

(MT)


SBR

)(RFB)(BR)

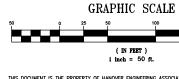

THIS DOCUMENT IS THE PROPERTY OF HANOVER ENGINEERING ASSOCIATES, INC. ANY USE OF A COPY OF THIS DOCUMENT THAT DOES NOT CONTAIN AN ORIGINAL SEAL AND SIGNATURE IS STRICTLY PROHIBITED. THIS DOCUMENT IS NOT PUBLISHED AND ALL RICHARD ARE RESERVED BY HANOVER ENGINEERING ASSOCIATES, INC. THIS PLAN HAS BEEN SEALED WITH EITHER A PEED INK SEAL OR A CRIMP SEAL. IF NEITHER APPEARS ON THIS PLAN, POSSIBLE REPRODUCTIONS OR ALTERATIONS MAY HAVE BEEN MADE WITHOUT THE APPROVAL OR NONDIEDGE OF THE SIGNATORY.

	NO.	REVISIONS	DATE	AVON LAKE GAS ADDITION PROJECT			
				CARLISLE, EATON & LAGRANGE TOWNSHIPS  AVON, AVON LAKE, ELYRIA &  NORTH RIDGEVILLE CITIES  I ORAIN COUNTY	DRAWN BY: AEJ CHECKED BY: SJC	PROJECT NO. NRG-1007	
					DATE: 12.15.14 SCALE: AS NOTED	SHEET NO. 81 of 88	
SEAL				Hanover Engineering Associates Inc	3355 Route 611, Suite 1 Bartonsville, PA 18321-7822 570.688.9550 Fax 570.688.9768		

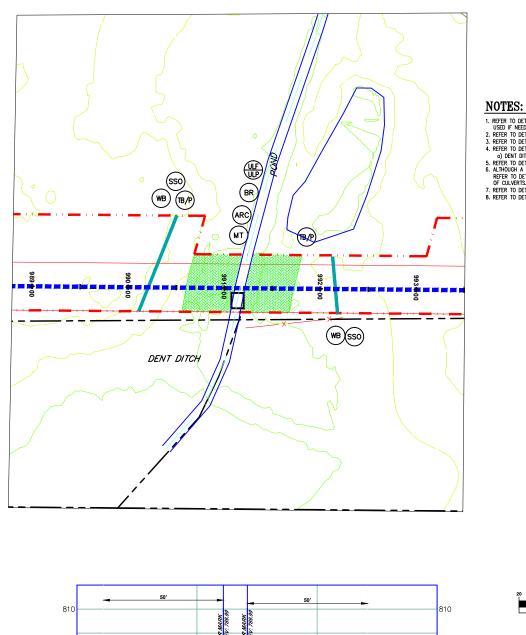

#### **DENT DITCH**

#### SCALE: 1" = 50'

- 1. REFER TO DETAIL SHEET 3 FOR "18/P" DETAIL ADDITIONAL TRENCH BREAKERS SHALL BE USED IF NEEDED.

  2. REFER TO DETAIL SHEET 3 FOR "M9" DETAIL.

  3. REFER TO DETAIL SHEET 3 FOR "SSO" DETAIL.

  4. REFER TO DETAIL SHEET 6 FOR "M" DETAIL.

  4. DEFER TO DETAIL SHEET 6 FOR "M" DETAIL.

  5. DEFER TO DETAIL SHEET 4 FOR "LUF" OR LUF" DETAIL, UTILIZE FOR STREAM CROSSINGS.

  6. ALTHOUGH A BRIDGE IS SHOW, A TEMPORARY CULVENT CROSSING MAY BE INSTALLED.

  REFER TO DETAIL SHEET 1 FOR "BR" DETAIL AND FOR THE SPECIFIED SIZE AND NUMBER OF COLVERTS.


  7. REFER TO DETAIL SHEET 3 FOR "ARC" DETAIL.

  8. REFER TO DETAIL SHEET 3 FOR "FB" DETAIL.

  8. REFER TO DETAIL SHEET 3 FOR "FB" DETAIL.

# - BOTTOM OF BRIDGE ABUTMENT PIPELINE R.O.W. MIN. 4 FT. VERTICAL SEPARATION

# DENT DITCH PROFILE (ON 22x34 SHEET) HORIZONTAL GRAPHIC SCALE ( IN FEET ) 1 inch = 20 ft. (ON 22x34 SHEET) GRAPHIC SCALE ( IN FEET )

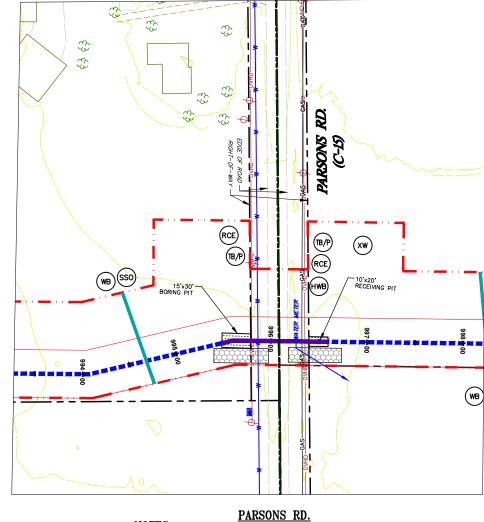

#### NOTES: SCALE: 1" = 50"

- 1. REFER TO DETAIL SHEET 3 FOR "TB/P" DETAIL. ADDITIONAL TRENCH BREAKERS SHALL BE USED IF NEEDED.
  2. REFER TO DETAIL SHEET 5 FOR "RCE" DETAIL.
  3. REFER TO DETAIL SHEET 3 FOR "THRE" DETAIL. PLACE TRENCH BREAKERS ON EITHER SIDE OF THE EXISTING ROAD.
  4. REFER TO DETAIL SHEET 3 FOR "STONE/DIRT THP ROAD CROSSING DETAIL" OR "PAVED TWP ROAD CROSSING" FOR TRENCH BACKFILL AND ROAD SURFACE RESTORATION.
  5. REFER TO DETAIL SHEET 3 FOR "FB" DETAIL.

<u>LEGEND</u> INDEX CONTOUR CONTOUR PROPERTY LINE
TEMP. CONSTRUCTION
EASEMENT/LIMIT OF
DISTURBANCE PERMANENT PIPELINE R.O.W.

CENTERLINE PIPELINE R.O.W.

FENCE

WETLANDS

CONVENTIONAL BORE

OVERHEAD/UTILITY POLE  $\stackrel{\mathit{FLOW}}{\rightarrow} \ \textit{PERENNIAL STREAM}$ FLOW EPHEMERAL/INTERMITTENT

STREAM

SOIL TYPE & BOUNDARY

SILTSOXX OR EQUIV. 12" HEIGHT

SILTSOXX OR EQUIV. 24" HEIGHT

SILTSOXX OR EQUIV. 32" HEIGHT

STREAMBANK RESTORATION

ROCK FILTER BERM

WETLAND CROSSING

SEDIMENT SILT SOXX PROTECTION AT WATER BAR ACCESS ROAD

HIGHWAY CUT

ACCESS RD. X-ING (PAVED ROAD)

ACCESS RD. w/CULVERT UTILITY LINE STREAM X-ING WITH DAM AND PUMPING OR WITH PIPE FLUME

TRENCH BREAKER/PLUG LONGITUDINAL DIVERSION GRADING

ROCK CONSTRUCTION ENTRANCE

EROSION CONTROL MATTING

ABOVE GROUND PIPE

WOODS LINE ... EDGE WOODS

ORD. HIGH WATER MARK ORD. HIGH WATER MARK LINE

LM LOG MAT

PEM/PSS PFO

(SS12)

(SS24)

SS32

RCE


(MT)

SBR

RFB BR

\(\text{\texi}\text{\text{\text{\text{\text{\texi}\text{\text{\text{\text{\texi}\text{\texi}\text{\text{\text{\text{\text{\text{\texi}\tex


LIMIT OF CONSTRUCTION AND LIMIT OF DISTURBANCE - 235 AC.

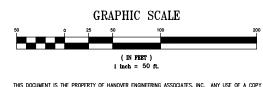

THIS DOCUMENT IS THE PROPERTY OF HANOVER ENGINEERING ASSOCIATES, INC. ANY USE OF A COPY OF THIS DOCUMENT THAT DOES NOT CONTAIN AN ORIGINAL SEAL AND SIGNATURE IS STRICTLY PROHIBITED. THIS DOCUMENT IS NOT PUBLISHED AND ALL RIGHTS ARE RESERVED BY HANOVER ENONEERING ASSOCIATES, INC. THIS PLAN HAS BEEN SEALED WITH EITHER A FED INK SEAL OR A CRIMP SEAL. IF NEITHER APPEARS ON THIS PLAN, POSSIBLE REPRODUCTIONS OR ALTERATIONS MAY HAVE BEEN MADE WITHOUT THE APPEROVAL OR KNOWLEDGE OF THE SIGNATORY.

E&SPC SITE DETAIL AVON LAKE GAS ADDITION PROJECT REVISIONS DATE PROJECT NO. CARLISLE, EATON & LAGRANGE TOWNSHIPS AEJ NRG-1007 AVON, AVON LAKE, ELYRIA & SJC NORTH RIDGEVILLE CITIES SHEET NO. 12.15.14 LORAIN COUNTY 82 of 88 OHIO 3355 Route 611, Suite 1 Hanover Bartonsville, PA 18321-7822 570.688.9550 Engineering Associates Inc Fax 570.688.9768

# **GENERAL NOTES:**

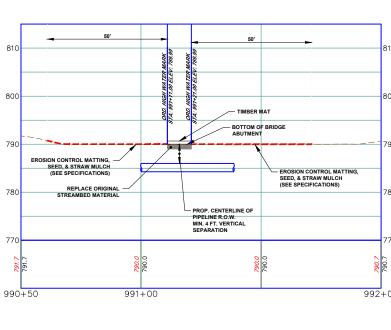

CONSTRUCTION MUST BE IN ACCORDANCE WITH THE FOLLOWING SCHEDULE. THIS SCHEDULE IS DESIGNED TO MINIMIZE SOIL EROSION AND SEDIMENTATION. THE CONTRACTOR MAY DEVATE IS ISJOHILY FROM THE STAGING OF PERMANENT SITE IMPROVEMENTS, BUT NO DEVATION SERVIN THE BRILDING PROPER OF EROSION AND SENDIFFACTION CONTROL MEASURES WILL BE ALLOWED.

NOTE: THE STAGING OF EARTHMONING ACTIVITIES FOR THIS PROJECT IS A GENERAL DESCRIPTION OF THE WORK REQUIRED. ALL WORK SHALL BE COMPLETED IN ACCORDANCE WITH JOURNAYY STANDARDS, THE OHIO DEPARMENT OF ENVIRONMENTAL PROTECTION REGULATIONS, AND ALL OTHER PROPLICABLE FEDERING, STATE OR LOCAL REQUIRELENTS.

ALL EARTH DISTURBANCE ACTIVITIES SHALL PROCEED IN ACCORDANCE WITH THE FOLLOWING SEQUENCE. CONSTRUCTION MAY START AT MULTIPLE POINTS. THE CONTRACTOR SHALL PLACE ALL BMPS FOR THAT SECTION OR AREA PRIOR TO THE START OF CONSTRUCTION.

BEFORE IMPLEMENTING ANY REVISIONS TO THE APPROVED EROSION AND SEDIMENTATION CONTROL PLAN OR REVISIONS TO OTHER PLANS WHICH MAY AFFECT THE EFFECTIVENESS OF THE APPROVED E&S PLAN, THE OPERATOR MUST RECEIVE APPROVAL OF THE REVISIONS FROM THE APPROPARIATE CONSERVATION DISTRICT.

THE CONTRACTOR SHALL REMOVE FROM THE SITE, RECYCLE, OR DISPOSE OF ALL BUILDING MATERIALS AND WASTES IN ACCORDANCE WITH OHO PAYS SOLD WASTE MANAGEMENT REQULATIONS AT OAC CHAPTER 3745. THE CONTRACTOR SHALL NOT LLEGALLY DWIN, OR DISPAGRE MAY PULLIDING MATERIAL OR WASTES AT THE SITE. BEFORE DISPOSING OF SOLL OR RECEIVED BERROW FOR SITE AND SHALL PROPERLY SHALL PROPERL

THE APPROVED EROSION AND SEDIMENTATION CONTROL PLAN INCLUDING THE SOIL EROSION CONTROL DRAWINGS AND NARRATIVE SHALL BE AVAILABLE ON SITE AT ALL TIMES DURING EARTH DISTURBANCE.

#### SEQUENCE OF BMP INSTALLATION AND REMOVAL DURING PIPELINE CONSTRUCTION

- STAKE/FLAG DISTURBED RIGHT-OF-WAY EXTENTS, CLEARLY IDENTIFYING WETLAND AND STREAM EDGES AND BUFFERS. INSTALL
  SIGNS OR OTHER MEANS TO IDENTIFY IMPORTANT PROJECT ATTRIBUTES SUCH AS APPROVED ACCESS ROADS, NO REFUELING ZONES,
- SCHOOLTHUS LY. DISTRIBED RIGHTO—FUN ZUTINIST, CARAY USENTING WE FLAND, AND STREME DEES AND BUFFERS. NOTALL SIGNS OR OTHER MEANS TO DENTIFY IMPORTANT PROJECT ATTRIBUTES SUCH AS APPROVED ACCESS ROADS, NO REFUELING ZONES, WELLAND, STEAM BOUNGS.

  2. SOFEDIALE A PRECONSTRUCTION CONFERENCE AS DESCRIBED ABOVE AND PROVIDE AT LEAST THREE (2) WORKING DAYS, SEVENTY-TWO (72 HOURS) NOTICE TO THE HOUR DAY PROPE TO COMMENCEMENT OF SITE GRADING WORK. NOT. IN THE WORK OF THE

#### PERMANENT STABILIZATION - ALTERNATE FINAL RESTORATION NOTE

A. <u>Limiting exposed areas</u> — "Earth disturbance activities shall be planned and conducted to minimize the extent and duration of the disturbance."

THE LENGTH OF TIME FOR CONSTRUCTING ACCESS ROADS, UTILITY LINE TRENCHING, TRENCH BACK-FILLING, FINAL GRADING, AND CLEANUP SHOULD BE KEPT TO A MINIMUM. GOOD PLANNING AND SCHEDULING OF THE VARIOUS UTILITY CONSTRUCTION ITEMS, TOCKTHEW MITH TIMELY AVAILABILITY OF MATERIALS, ADEQUATE EQUIPMENT, AND ADEQUATE MANPOWER, WILL HELP REDUCE THE TIME OF EXPOSURE OF DISTURBED LAND.

REDUCE THE TIME OF EXPOSITE OF DISTURBED LAND.

LARGE DAMERTS STEEL PPELLINES WITH WEIDED JOINTS WERER THE PIPE, SONTS ARE WEIDED WHILE THE PIPE IS OUT OF THE TRENCH USUALLY REQUIRE A FARRY LONG LIBRIGH OF OPEN PREJIENT TRENCH. THE OTAL TIME FROM TENCH EXCAVATION TO PLACEMENT OF BASKFILL FOR IS THE OTHER THAT FOR SAFELY AND THE PELLINES TO SHOW THE PELLINES THAT FOR EXAMPLE, THAT FROM THE THAT FROM PARE PLACEMENT EXCAVATION AUTHORS COMMINGE AT STATION 14-00, NO MORE THAN THAT YOU OLD THE PELLINES THAT FOR THE PELLINES THAT


NO SOIL IS TO BE HAULED OFF SITE WITHOUT A SEPARATE EROSION AND SEDIMENTATION CONTROL PLAN REVIEWED FOR ADEQUACY BY THE OHIO EPA OR THE LOCAL COUNTY CONSERVATION DISTRICT AS APPROPRIATE.

INSPECTION — ALL BMPS SHOULD BE INSPECTED AFTER EACH MEASURABLE RAINFALL RUNOFF EVENT AND ON A WEEKLY BASIS.
ANY NECESSARY REPAIRS MUST BE MADE
MEMBILATELY TO RUNDE EFFECTIVE AND EFFICIENT OPERATION.

#### **General Notes:**

- BMPS SHOWN MAY NEED TO BE FIELD ADJUSTED TO FIT ACTUAL CONDITIONS. IN SOME CASES, THE NEXT LARGER BMP MAY BE NEEDED DUE TO UNFORESEN CONDITIONS. ADDITIONAL BMPS MAY BE REQUIRED DHEN THAN THOSE SHOWN. THE CONTRACTOR SHALL TAKE WHATEVER MESSINES NECESSARY TO PREVENT SLIT FROM LEAVING THE STEE.
- ALL PIPES/BRIDGES ARE FOR CONSTRUCTION ONLY AND THE SITE OF SAID PIPES/BRIDGES SHALL BE RESTORED TO ORIGINAL TOPOGRAPHY AND STABLUZED WITHIN FIVE (5) DAYS AFTER TERMINATION OF ITS INTENDED USE OR AT THE END OF THE ONE (1) YEAR PERIOR, WINHEVER DOCUMES FIRST.

#### **Temporary Stream Crossing** With Multiple Pipes Detail

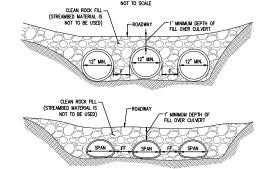

#### CROSS-SECTIONS

- NOTES:

  MILTIPLE PPES AND MILTIPLE SPAN BRIDGES AND CULVERTS WHICH MAY TEND TO COLLECT DEBRIS, CONTRIBUTE TO THE
  FORMATION OF ICE JAMES AND INCREAS: FEAD LOSSES SHALL BE AVOIDED TO THE MAXIMUM EXTENT PRACTICABLE CROSSINGS OF
  LESS THAN TO FEET SHALL BE BY ONE SPAN, EXCEPT MERE CONDITIONS WARE IT MEPRICALL TO AFFECT THE CROSSING
  WITHOUT MULTIPLE SPANS.
- # INITIAL INCLUREE SPANS.


  PROVIDE SO' STRUCKOCKS TO CROSSING ON BOTH SIDES OF STREAM CHANNEL PIPES SHALL EXTEND BEYOND THE TOE OF THE ROJONAN',

  ROUNGY FROM THE ROJONAY SHALL BE DIVERTED OFF THE ROJONAY AND INTO A SEDIMENT REMOVAL BMP BEFORE IT REACHES THE ROJO APPROACH TO THE CROSSING.

- MAINTENANCE

  1. TEMPORARY STREAM CROSSINGS SHALL BE INSPECTED ON A DALY BASIS.
  2. DAMAGED CROSSINGS SHALL BE REPARED WITHIN 24 HOURS OF THE INSPECTION AND BEFORE ANY SUBSEQUENT USE.
  3. SEDMENT DEPOSITS ON THE CROSSING OR ITS APPROACHES SHALL BE REJOYED WITHIN 24 HOURS OF THE INSPECTION.
  4. AS SOON AS THE TEMPORAY COSSING IS NO LOWER NEEDED, IT SHALL BE REJOYED. ALL MATERIALS SHALL BE DISPOSED OF PROPERLY AND DISTURBED AREAS STABILIZED.

#### **Temporary Stream Crossing** With Single Pipe Detail

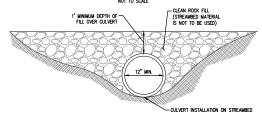

#### CROSS-SECTION VIEW

- NOTES:

  1. PROVES OF STABILIZED ACCESS TO CROSSING ON BOTH SIDES OF STREAM CHANNEL.

  2. PIPES SHALL EXTEND BEYOND THE TOE OF THE ROADWAY.

  3. RUNGET FROM THE ROADWAY SHALL BE DIVERTED OFF THE ROADWAY AND INTO A SEMIMENT REMOVAL BMP BEFORE IT REAGHES THE ROAD APPROACH TO THE CROSSING.

- MAINTENANCE:


  1. TEMPORARY SIREAM CROSSINGS SHALL BE INSPECTED ON A DALY BASIS.

  2. DAMAGED COSSINGS SHALL BE REPAIRED WITHIN 24 HOURS OF THE INSPECTION AND BEFORE ANY SUBSEQUENT USE.


  3. SEDIMENT DEPOSITS ON THE CROSSING OR ITS APPROACHES SHALL BE REMOVED WITHIN 24 HOURS OF THE INSPECTION.

  4. AS SOON AS THE TEMPORARY CROSSING IS NO LONGER NEEDED, IT SHALL BE REMOVED, ALL MATERIALS SHALL BE UISPOSED OF PROPERLY AND DISTURBED AREAS STRAILEZD.

# luuuuuu

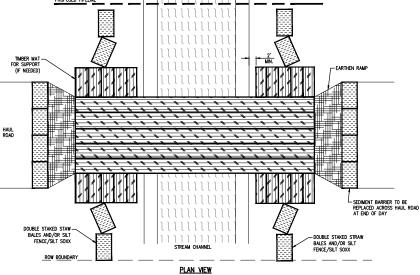

**Timber Mat Bridge Detail** 

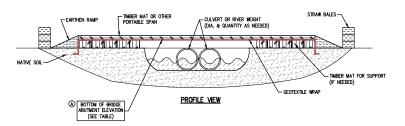

NOTES:

1. STRAM BALES TO BE PLACED ACROSS BRIDGE ENTRANCE EVERY NICHT.

2. THE CONTRACTOR HAS THE O'PTION TO INSTALL PIPES OR BRIDGE TO CROSS STREAM. IF USING BRIDGE, CULVERTS MAY BE USED TO STABILIZE BRIDGE. THE CULARITY AND DIAMETER OF CULVERTS SHALL BE AS NEEDED TO STABILIZE THE BRIDGE AND TO MEET THE MINIMAL BRIDGE LEVANION SHOWN IN TABLE BLOW. IF USING PIPES, THE DIAMETER AND QUANTITY OF PIPES SHALL BE AS SHOWN IN TABLE BELOW.

3. CONTRACTOR HAS THE O'PTION TO CHOOSE BETWEEN PUMPING OR FLUMING STREAM FLOW FOR TRENCH CROSSING.

#### E&SPC TYPICAL DETAIL SHEET 1

Fax 570 688 9768

#### REVISIONS DATE AVON LAKE GAS ADDITION PROJECT PROJECT NO. CARLISLE, EATON & LAGRANGE TOWNSHIPS AEJ NRG-1007 AVON, AVON LAKE, ELYRIA & SJC NORTH RIDGEVILLE CITIES SHEET NO. 12.15.14 LORAIN COUNTY 83 of 88 OHIO AS NOTED 3355 Route 611, Suite 1 Hanover Bartonsville, PA 18321-7822 570 688 9550 Engineering Associates Inc

- GENERAL NOTES:

  1. ALL BUP'S SHALL BE INSPECIED AFTER EACH PRINGE EVENT AND ON A MEDILY BASIS. ANY
  NECESSARY PERAPS MIST BE MADE MANDENTELY TO BRISIDE EFFICITIVE AND EFFICIENT OPERATION.

  2. BUP'S SHOWN MAY NEED TO BE FIELD ADJUSTED TO FIT ACTUAL CONDITIONS.

  3. IN SIGNE CASS, THE MEST LARGER BUP MAY BE REEDED LUE TO UNFORESEEN CONDITIONS.

  4. AUDITIONAL BUP'S MAY BE REQUIRED OTHER THAN THOSE SHOWN.

  5. THE CONTRACTOR SHALL TAKE WHATEVER MEASURES NECESSARY TO PREVENT SEDIMENT FROM
  LEAWING THE SITE.

This foregoing document was electronically filed with the Public Utilities

**Commission of Ohio Docketing Information System on** 

12/19/2014 12:56:19 PM

in

Case No(s). 14-1717-GA-BLN

Summary: Application of NRG Ohio Pipeline Company LLC continued - Attachment K (Part 6) electronically filed by Teresa Orahood on behalf of Sally Bloomfield