



ACCESS ROAD (AR-1) TO LAKE ROAD (SR-6), ACCESS ROAD (AR-2) TO LAKE ROAD (SR-6), & LAKE ROAD (SR-6)

NOTES:

- 1.. REPER TO DETAIL SHEET 5 FOR "RCE" DETAIL.
 2. REFER TO DETAIL SHEET 5 FOR "AR" DETAIL.
 3. REFER TO DETAIL SHEET 3 FOR "HWC" OR "HWB" DETAIL. PLACE TRENCH BREAKERS ON EITHER SDE OF THE EXISTING ROAD.
 4. SEE DOOT PERMITS FOR STATE REQUIREMENTS.
- 5. REFER TO DETAIL SHEET 3 FOR "FB" DETAIL.
 6. REFER TO DETAIL SHEET 6 FOR INLET PROTECTION DETAIL.

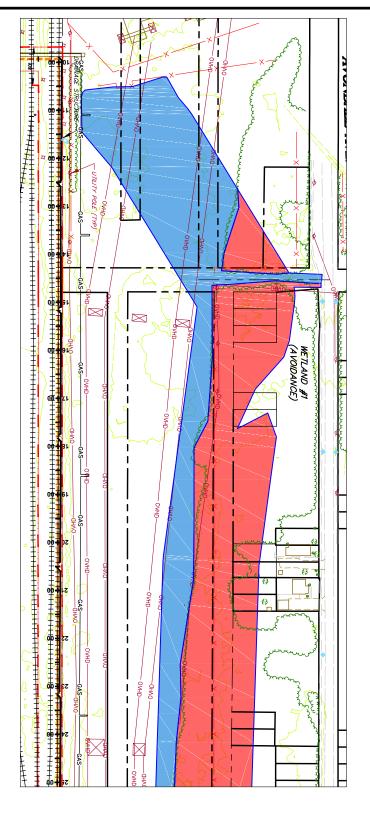

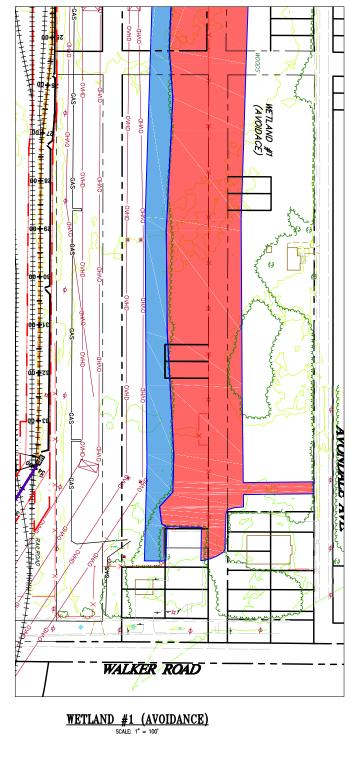


PERMANENT PIPELINE R.O.W. CENTERLINE PIPELINE R.O.W. ABOVE GROUND PIPE CONVENTIONAL BORE FENCE WOODS LINE WOODS PEM/PSS PFO WETLANDS OVERHEAD/UTILITY POLE FLOW PERENNIAL STREAM FLOW EPHEMERAL/INTERMITTENT

STREAM ORD. HIGH WATER MARK ORD. HIGH WATER MARK LINE SOIL TYPE & BOUNDARY (SS12)* SILTSOXX OR EQUIV. (SS24) SILTSOXX OR EQUIV. 24" HEIGHT SS32 SILTSOXX OR EQUIV. 32" HEIGHT RCE ROCK CONSTRUCTION ENTRANCE LM LOG MAT (MT) EROSION CONTROL MATTING SBR STREAMBANK RESTORATION RFB BR ROCK FILTER BERM WETLAND CROSSING SEDIMENT SILT SOXX PROTECTION AT WATER BAR ACCESS ROAD HIGHWAY CUT ACCESS RD. X-ING (PAVED ROAD) ACCESS RD. w/CULVERT UTILITY LINE STREAM X-ING WITH DAM AND PUMPING OR WITH PIPE FLUME (B/P) TRENCH BREAKER/PLUG LONGITUDINAL DIVERSION GRADING LIMIT OF CONSTRUCTION AND LIMIT OF DISTURBANCE - 235 AC.

LEGEND INDEX CONTOUR CONTOUR

E&SPC SITE DETAIL

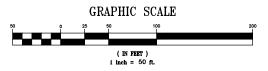


THIS DOCUMENT IS THE PROPERTY OF HANOVER ENGINEERING ASSOCIATES, INC. ANY USE OF A COPY OF THIS DOCUMENT THAT DOES NOT CONTAIN AN ORIGINAL SEAL AND SIGNATURE IS STRICTLY PROHIBITED. THIS DOCUMENT IS NOT PUBLISHED AND ALL RIGHTS ARE RESERVED BY HANOVER ENOINEERING ASSOCIATES, INC. THIS PLAN HAS BEEN SEALED WITH EITHER A FED INK SEAL OR A CRIMP SEAL IF NEITHER APPEARS ON THIS PLAN, POSSIBLE REPRODUCTIONS OR ALTERATIONS MAY HAVE BEEN MADE WITHOUT THE APPEROVAL OR KNOWLEDGE OF THE SIGNATORY.

				L&SI O SITE DET	· /\IL	
	NO.	REVISIONS	DATE	AVON LAKE GAS ADDITIO)N PRO	JECT
				CARLISLE, EATON & LAGRANGE TOWNSHIPS AVON, AVON LAKE, ELYRIA & NORTH RIDGEVILLE CITIES LORAIN COUNTY	DRAWN BY: AEJ CHECKED BY: SJC DATE: 12.15.14 SCALE: AS NOTED	PROJECT NO. NRG-1007 SHEET NO. 45 of 88
SEAL				Hanover Engineering Associates Inc	Bartonsvill 570	oute 611, Suite 1 le, PA 18321-7822 0.688.9550 570.688.9768

SEE DETAIL SHEET 1 FOR SCHEDULE FOR PIPES/BRIDGES.
 STREAM BUFFER IS 25 FEET FROM THE ORDINARY HIGH WATER MARK AND WETLAND BUFFER IS 25 FT. FROM WETLAND BOUNDARY.

GENERAL NOTES:

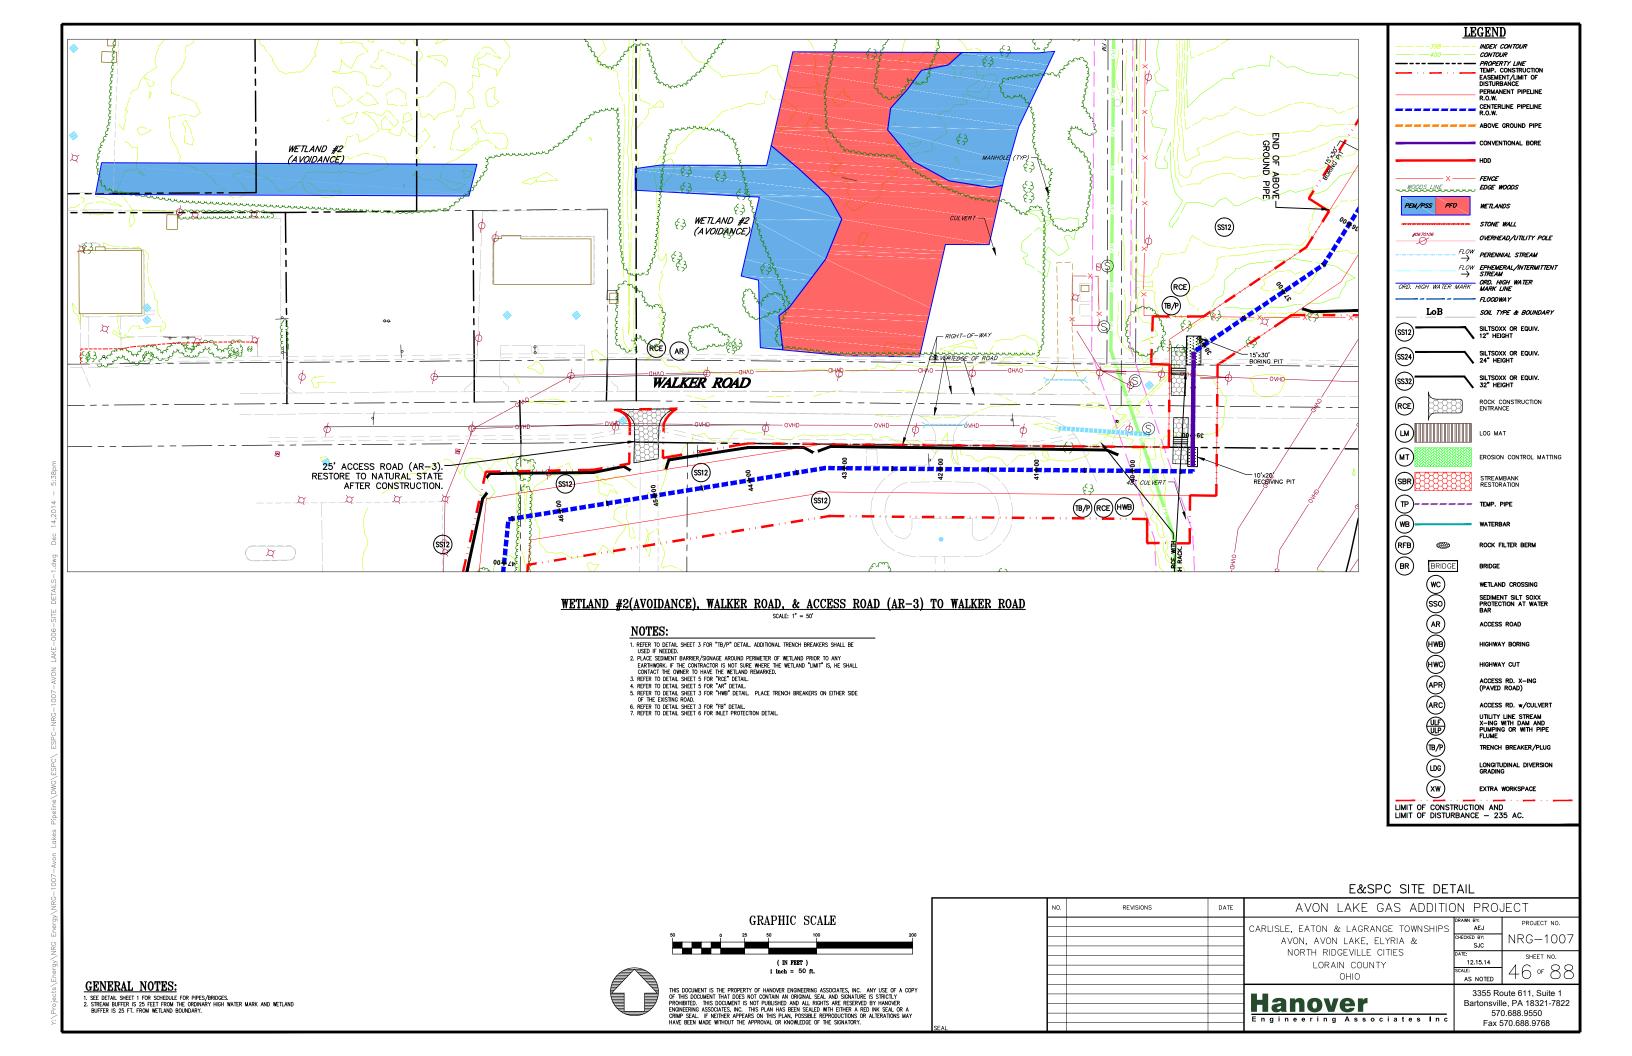



NOTES:

- 1. REFER TO DETAIL SHEET 3 FOR "TB/P" DETAIL. ADDITIONAL TRENCH BREAKERS SHALL BE USED IF NEEDED.


 2. REFER TO DETAIL SHEET 3 FOR "WC" DETAIL.

 3. PLACE SEDIMENT BARRIER/SIGNAGE AROUND PERMETER OF WETLAND PRIOR TO ANY EARTHWORK. IF THE CONTRACTOR IS NOT SURE WHERE THE WETLAND "LIMIT" IS, HE SHALL CONTACT THE OWNER TO HAVE THE WETLAND REMARKED.

 4. THE CONTRACTOR SHALL PLACE LOG MATS TO CROSS THE WETLAND AREA ALL APPLICABLE WETLAND BARD WINNIN THE LUMITS OF CONSTRUCTION/DISTURBANCE SHALL BE COVERED. THE CONTRACTOR SHALL BE RESPONSIBLE FOR ANY FINES AND/OR REPAIRS REQUIRED AS A RESULT O PAMAGE TO WETLANDS AND WATERCOURSES AT NO COST TO THE FACILITY OWNER.

 5. REFER TO DETAIL SHEET 3 FOR "MI" DETAIL:

 a) WETLAND AS USE BLANKET TYPE S75 OR APPROVED EQUAL, STAPLE PATTERN "C".

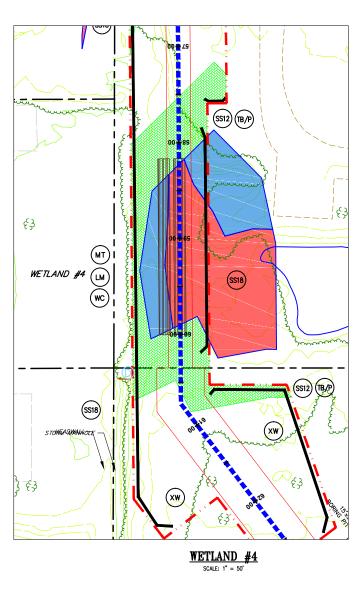

- NOTES:

 1. REFER TO DETAIL SHEET 3 FOR "TB/P" DETAIL. ADDITIONAL TRENCH BREAKERS SHALL BE USED IF NEEDED.


 2. REFER TO DETAIL SHEET 3 FOR "WC" DETAIL.

 3. PLACE SEDMENT BARRERY/SIGNAGE AROUND PERIMETER OF WETLAND PRIOR TO ANY EARTHWORK. IF THE CONTRACTOR IS NOT SUBE WHERE THE WETLAND "LIMIT" IS, HE SHALL CONTACT THE OWNER TO HAVE THE WETLAND REMARKED.


 4. THE CONTRACTOR SHALL PLACE LOG MATS TO CROSS THE WETLAND AREA. ALL APPULABLE WETLAND AREA WITHIN THE LIMITS OF CONSTRUCTION/DISTURBANCS SHALL BE COVERED. THE CONTRACTOR SHALL BE RESPONSIBLE FOR MY FINES AND/OR REPAIRS REQUIRED AS A RESULT OF DAMAGE TO WETLANDS AND WATERCOURSES AT NO COST TO THE FACULTY OWNER.

 5. REFER TO DETAIL SHEET 3 FOR "MT" DETAIL:

 a) WETLAND #4 USE BLANKET TYPE S75 OR APPROVED EQUAL, STAPLE PATTERN "C".

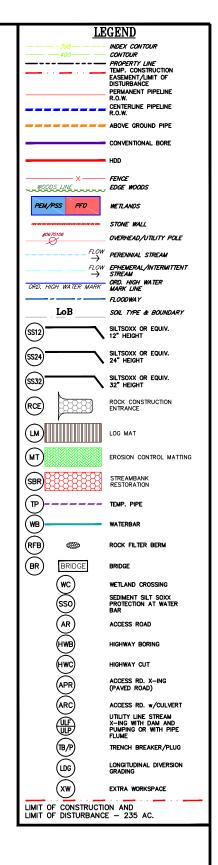


E&SPC SITE DETAIL

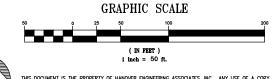

THIS DOCUMENT IS THE PROPERTY OF HANOVER ENGINEERING ASSOCIATES, INC. ANY USE OF A COPY OF THIS DOCUMENT THAT DOES NOT CONTAIN AN ORIGINAL SEAL AND SIGNATURE IS STRICTLY PROHIBITED. THIS DOCUMENT IS NOT PUBLISHED AND ALL RICHARD ARE RESERVED BY HANOVER ENGINEERING ASSOCIATES, INC. THIS PLAN HAS BEEN SEALED WITH EITHER A PEED INK SEAL OR A CRIMP SEAL. IF NEITHER APPEARS ON THIS PLAN, POSSIBLE REPRODUCTIONS OR ALTERATIONS MAY HAVE BEEN MADE WITHOUT THE APPROVAL OR NONDIEDGE OF THE SIGNATORY.

NO.	REVISIONS	DATE	AVON LAKE GAS ADDITIC	N PRO	JECT
			CARLISLE, EATON & LAGRANGE TOWNSHIPS AVON, AVON LAKE, ELYRIA & NORTH RIDGEVILLE CITIES LORAIN COUNTY	DRAWN BY: AEJ CHECKED BY: SJC DATE: 12.15.14 SCALE: AS NOTED	PROJECT NO. NRG-1007 SHEET NO. 47 OF 88
			Hanover Engineering Associates Inc	Bartonsvill 570	oute 611, Suite 1 e, PA 18321-7822 0.688.9550 570.688.9768

GENERAL NOTES:

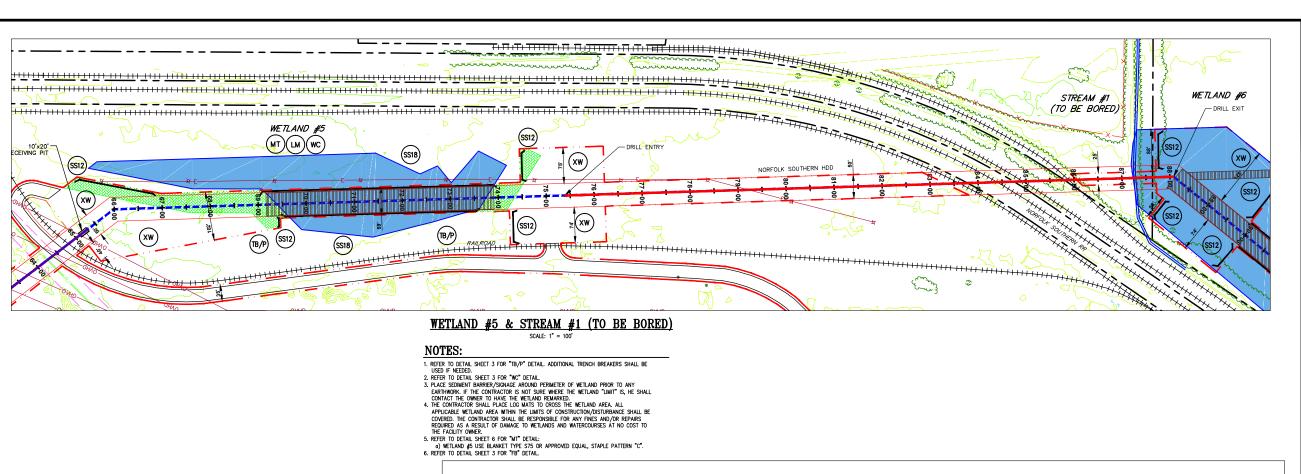

780 780 516.07 LF 740 720 720 680 660 660 640 620 580 580 560 560 540 2,600' RADIUS UNDERBEND ARC LENGTH: 545.4' 520 500 500 480 480 468 468 78+00 79+00 80+00 81+00 82+00 83+00 84+00 85+00 86+00 87+00 88+00 89+069+50

NORFOLK SOUTHERN HDD

GRAPHIC SCALE 1 inch = 100ft.

THIS DOCUMENT IS THE PROPERTY OF HANOVER ENGINEERING ASSOCIATES, INC. ANY USE OF A COPY OF THIS DOCUMENT THAT DOES NOT CONTAIN AN ORIGINAL SEAL AND SIGNATURE IS STRICTLY PROHIBITED. THIS DOCUMENT IS NOT PUBLISHED AND ALL RIGHTS ARE RESERVED BY HANOVER ENGINEERING ASSOCIATES, INC. THIS PLAN HAS BEEN SEALED WITH ETHER A FED INK SEAL OR A CRIMP SEAL. IF NEITHER APPEARS ON THIS PLAN, POSSIBLE REPRODUCTIONS OR ALTERATIONS MAY HAVE BEEN MADE WITHOUT THE APPROVAL OR KNOWLEDGE OF THE SIGNATORY.

				E&SPC SITE DET	AIL		
	NO.	REVISIONS	DATE	AVON LAKE GAS ADDITION PROJECT			
				CARLISLE, EATON & LAGRANGE TOWNSHIPS AVON, AVON LAKE, ELYRIA & NORTH RIDGEVILLE CITIES LORAIN COUNTY	DRAWN BY: AEJ CHECKED BY: SJC DATE: 12.15.14 SCALE: AS NOTED	PROJECT NO. NRG—1007 SHEET NO. 48 OF 88	
AL.				Hanover Engineering Associates Inc	3355 Route 611, Suite Bartonsville, PA 18321-78 570.688.9550 Fax 570.688.9768		

LEGEND

CENTERLINE PIPELINE R.O.W.

FENCE

WETLANDS

STONE WALL

OVERHEAD/UTILITY POLE FLOW PERENNIAL STREAM FLOW EPHEMERAL/INTERMITTENT

STREAM

SOIL TYPE & BOUNDARY

SILTSOXX OR EQUIV. 12" HEIGHT

SILTSOXX OR EQUIV. 24" HEIGHT

SILTSOXX OR EQUIV. 32" HEIGHT

STREAMBANK RESTORATION

ROCK FILTER BERM

WETLAND CROSSING

SEDIMENT SILT SOXX PROTECTION AT WATER BAR

ACCESS ROAD

HIGHWAY CUT

ACCESS RD. X-ING (PAVED ROAD)

ACCESS RD. w/CULVERT UTILITY LINE STREAM X-ING WITH DAM AND PUMPING OR WITH PIPE FLUME

TRENCH BREAKER/PLUG LONGITUDINAL DIVERSION GRADING

ROCK CONSTRUCTION ENTRANCE

EROSION CONTROL MATTING

CONVENTIONAL BORE

ABOVE GROUND PIPE

WOODS LINE ... EDGE WOODS

ORD. HIGH WATER MARK ORD. HIGH WATER MARK LINE

PEM/PSS PFO

(SS12)*

(SS24)

SS32)

RCE

(MT)

SBR

(TP)

RFB BR

LM

SSO


A B A A B B B B


(xw)

LIMIT OF CONSTRUCTION AND LIMIT OF DISTURBANCE - 235 AC.

INDEX CONTOUR CONTOUR PROPERTY LINE
TEMP. CONSTRUCTION
EASEMENT/LIMIT OF
DISTURBANCE PERMANENT PIPELINE R.O.W.

GENERAL NOTES:

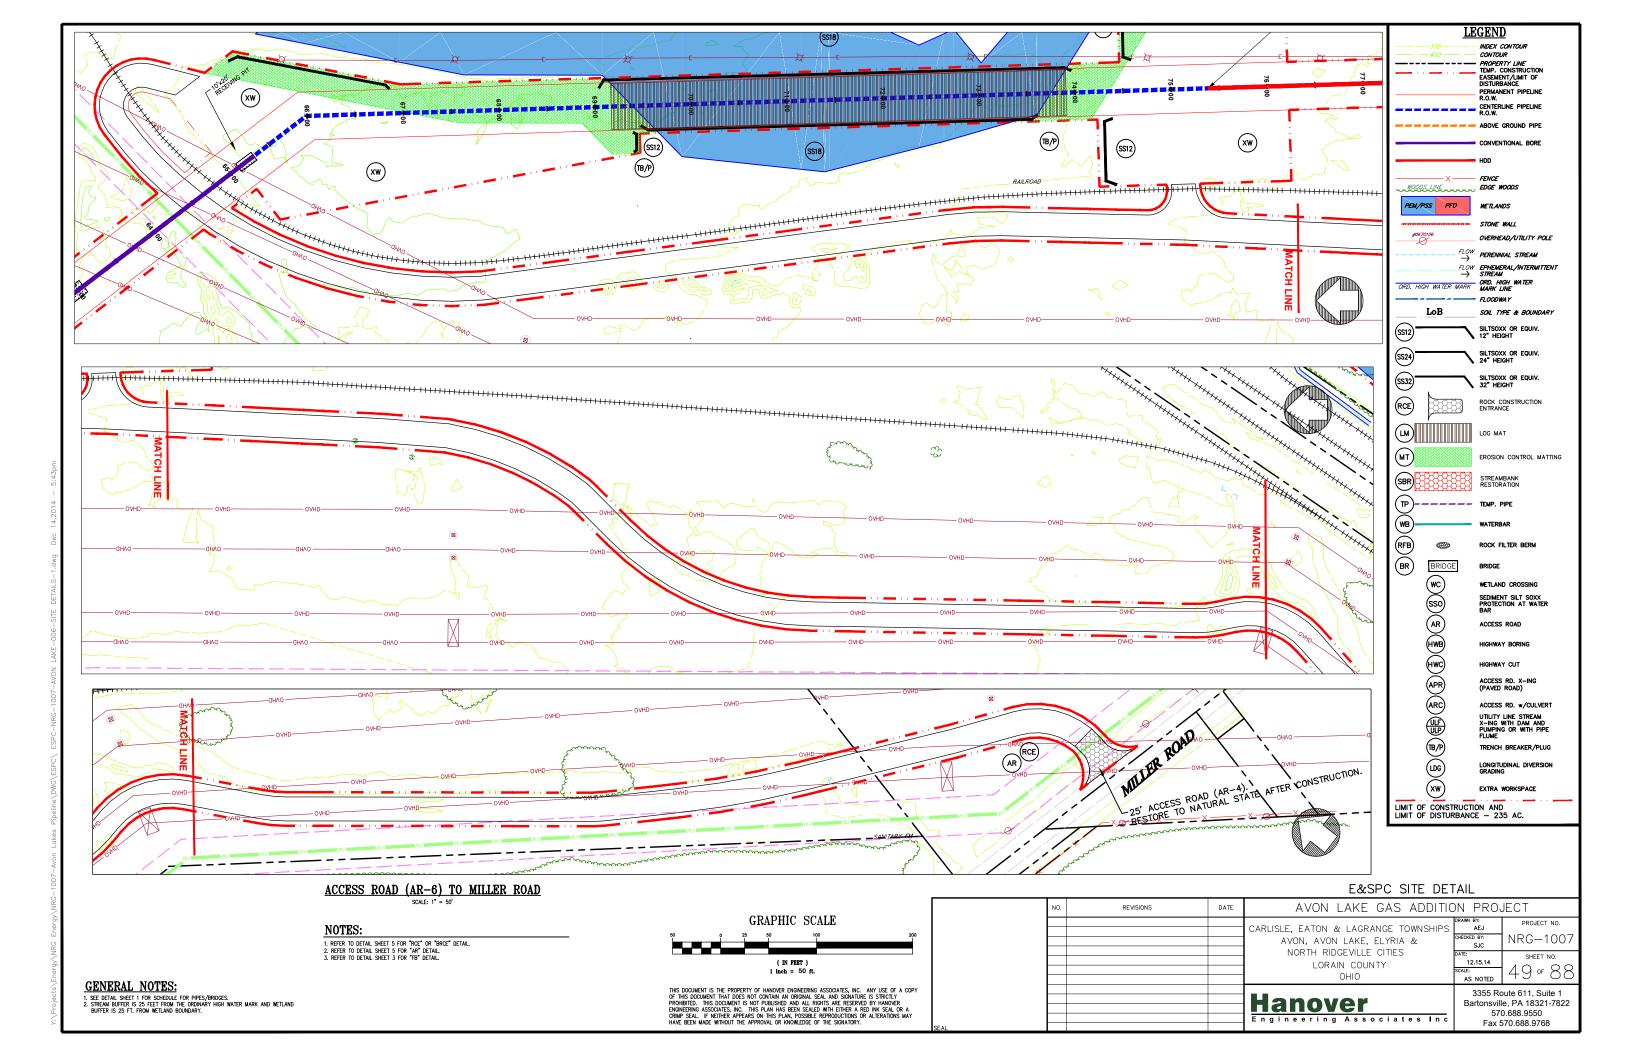


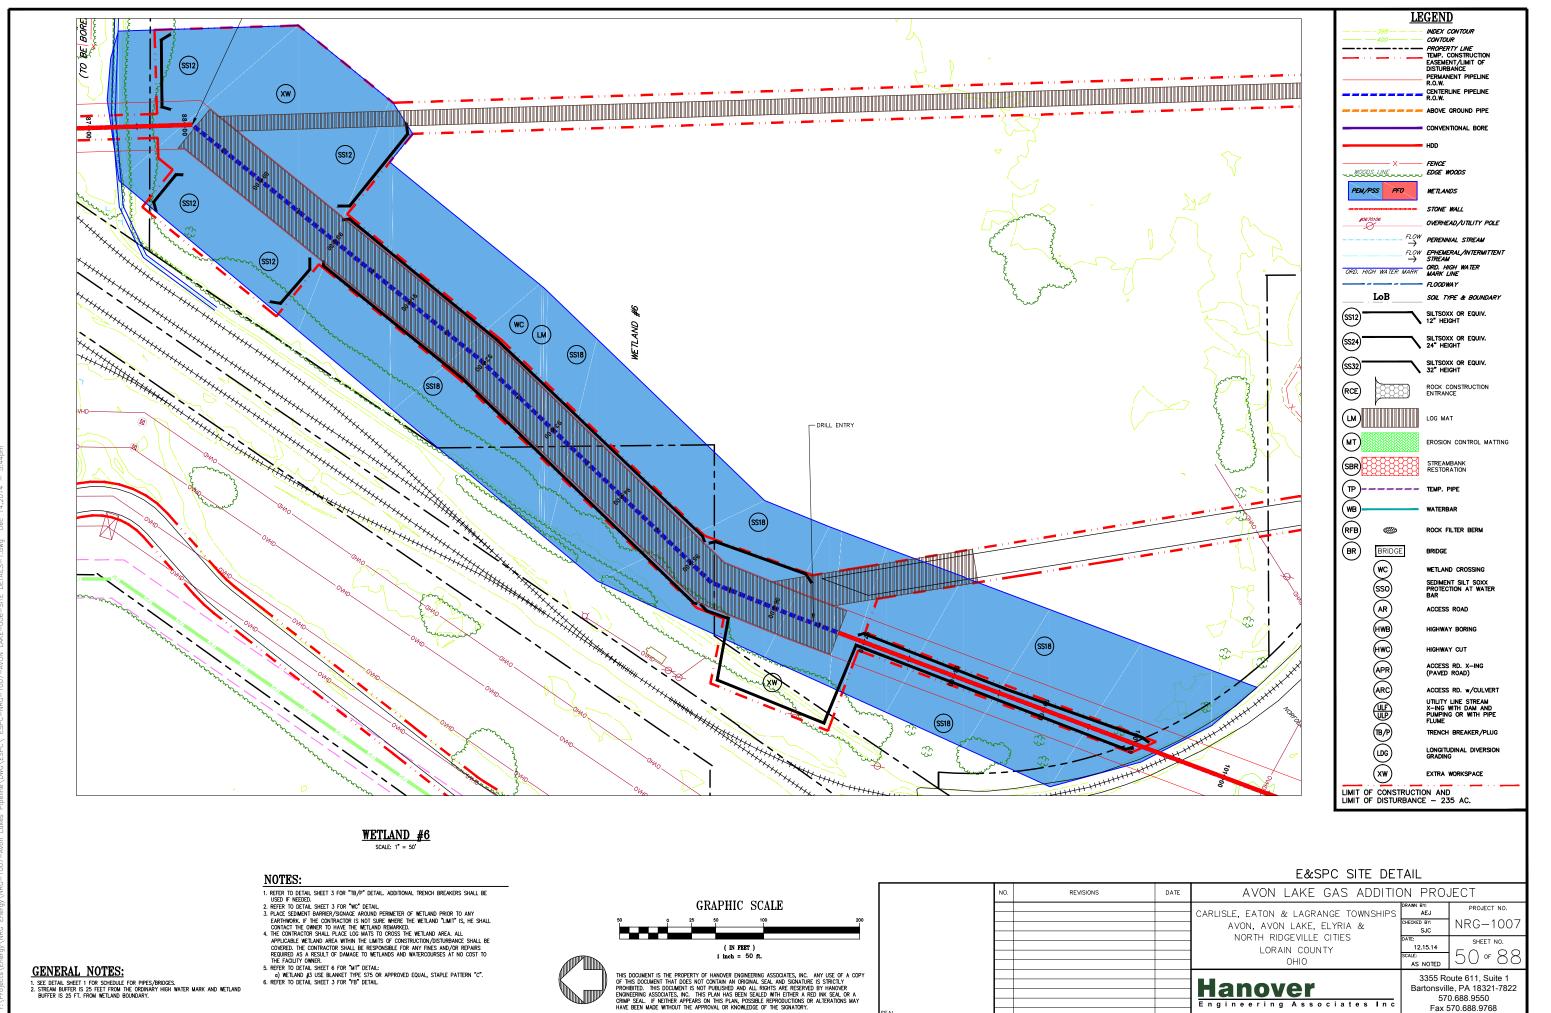

570.688.9550


Fax 570.688.9768

Engineering Associates Inc

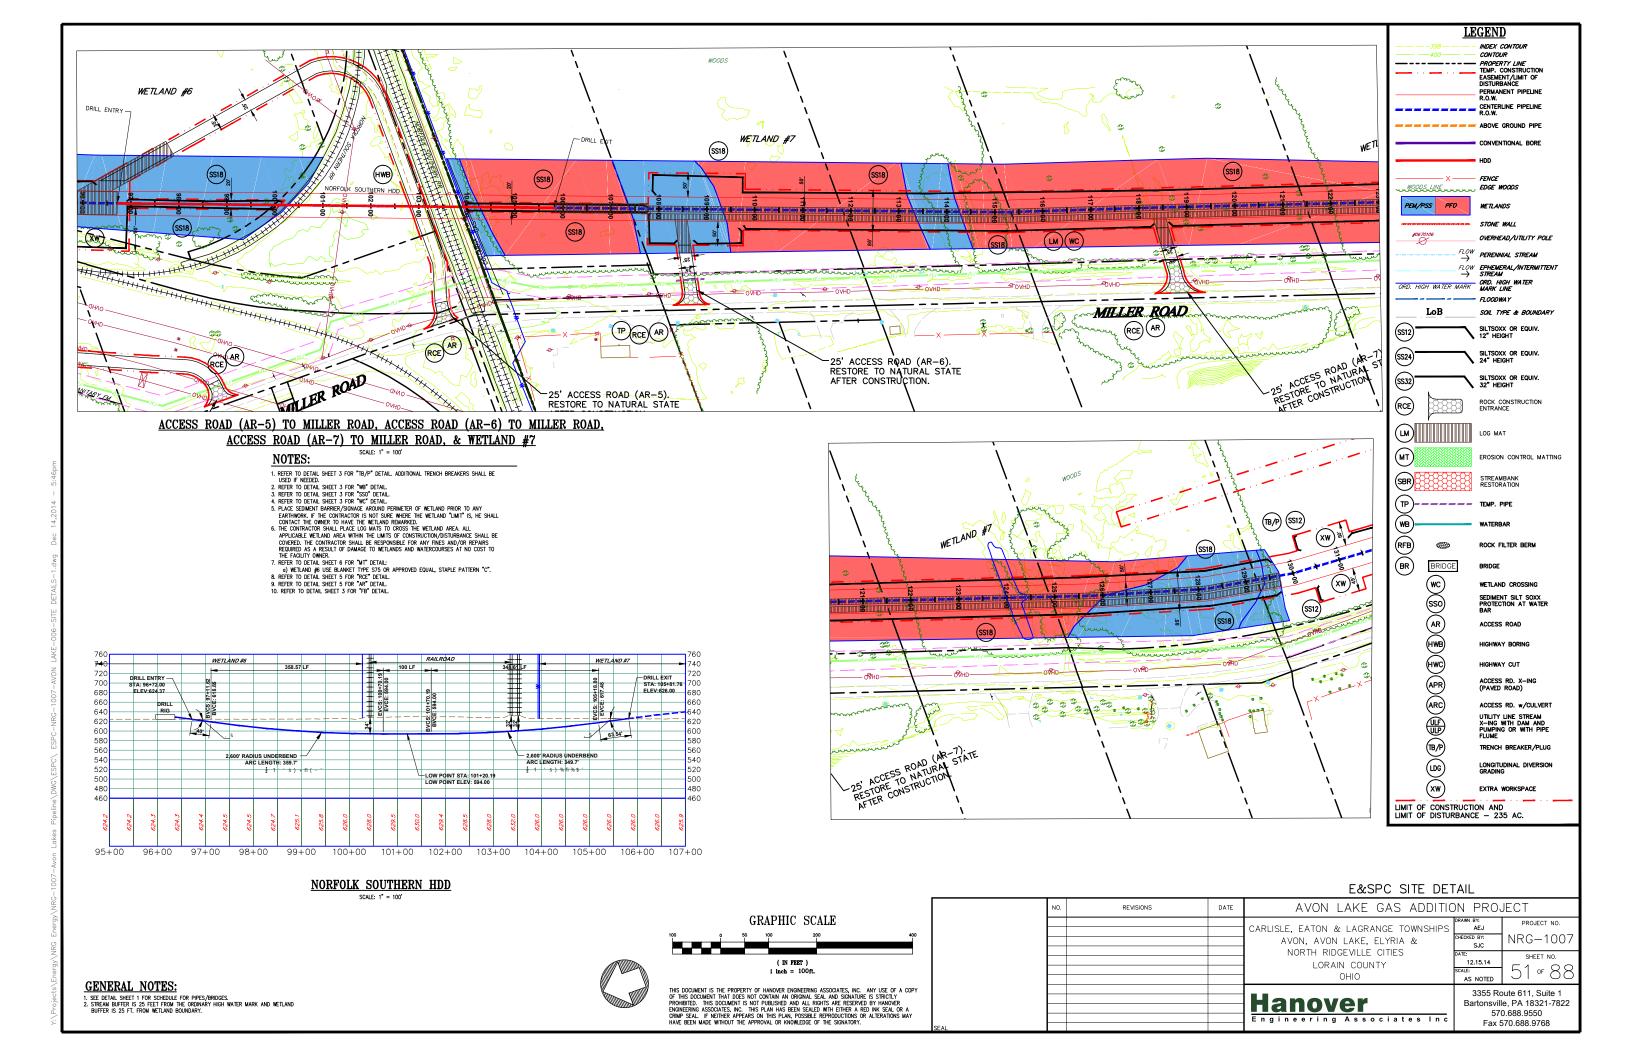


COLORADO AVE. (SR-611) & FRENCH CREEK (TO BE BORED)

- SCALE: 1" = 100"
- 1. REFER TO DETAIL SHEET 5 FOR "RCE" DETAIL.
- 2. REFER TO DETAIL SHEET 5 FOR "AR" DETAIL.
- 6. REFER TO DETAIL SHEET 3 FOR "FB" DETAIL.

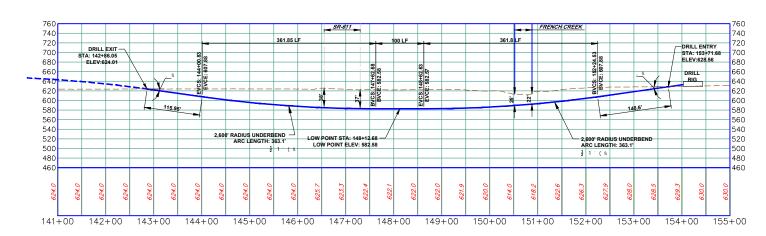

FRENCH CREEK HDD

(ON 22x34 SHEET) HORIZONTAL & VERTICAL

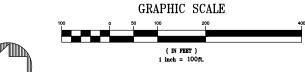

THIS DOCUMENT IS THE PROPERTY OF HANOVER ENGINEERING ASSOCIATES, INC. ANY USE OF A COPY OF THIS DOCUMENT THAT DOES NOT CONTAIN AN ORIGINAL SEAL AND SIGNATURE IS STRICTLY PROHIBITED. THIS DOCUMENT IS NOT PUBLISHED AND ALL RIGHTS ARE RESERVED BY HANOVER ENGINEERING ASSOCIATES, INC. THIS PLAN HAS BEEN SEALED WITH ETHER A FED INK SEAL OR A CRIMP SEAL. IF NEITHER APPEARS ON THIS PLAN, POSSIBLE REPRODUCTIONS OR ALTERATIONS MAY HAVE BEEN MADE WITHOUT THE APPROVAL OR KNOWLEDGE OF THE SIGNATORY.

NO.	REVISIONS	DATE	AVON LAKE GAS ADDITION PROJECT					
			CARLISLE, EATON & LAGRANGE TOWNSHIPS AVON, AVON LAKE, ELYRIA &	DRAWN BY: AEJ CHECKED BY: SJC	PROJECT NO. NRG—1007			
			LORAIN COUNTY	12.15.14 SCALE: AS NOTED	SHEET NO. 52 of 88			
			Hanover Engineering Associates Inc	Bartonsvill 570	oute 611, Suite 1 le, PA 18321-7822 0.688.9550 570.688.9768			

<u>LEGEND</u> INDEX CONTOUR CONTOUR PROPERTY LINE
TEMP. CONSTRUCTION
EASEMENT/LIMIT OF
DISTURBANCE PERMANENT PIPELINE R.O.W.

CENTERLINE PIPELINE R.O.W.

--- ABOVE GROUND PIPE CONVENTIONAL BORE

FENCE

WETLANDS

OVERHEAD/UTILITY POLE $\stackrel{\mathit{FLOW}}{\rightarrow} \ \textit{PERENNIAL STREAM}$

SOIL TYPE & BOUNDARY

FLOW EPHEMERAL/INTERMITTENT

STREAM

SILTSOXX OR EQUIV.

SILTSOXX OR EQUIV. 24" HEIGHT

SILTSOXX OR EQUIV. 32" HEIGHT

ROCK CONSTRUCTION ENTRANCE

STREAMBANK RESTORATION

ROCK FILTER BERM

WETLAND CROSSING SEDIMENT SILT SOXX PROTECTION AT WATER BAR ACCESS ROAD

HIGHWAY CUT ACCESS RD. X-ING (PAVED ROAD)

ACCESS RD. w/CULVERT

UTILITY LINE STREAM X-ING WITH DAM AND PUMPING OR WITH PIPE FLUME

TRENCH BREAKER/PLUG

LONGITUDINAL DIVERSION GRADING

EROSION CONTROL MATTING

WOODS LINE EDGE WOODS

ORD. HIGH WATER MARK ORD. HIGH WATER MARK LINE

LOG MAT

PEM/PSS PFO

SS12)*

(SS24)

SS32

RCE

(MT)

SBR


)(RFB)(BR)

\(\text{\texi}\text{\text{\text{\text{\texi}\text{\text{\text{\text{\texi}\text{\text{\text{\texi}\text{\texi}\text{\texi}\text{\text{\text{\texit{\texi}\text{\text{\te

LIMIT OF CONSTRUCTION AND LIMIT OF DISTURBANCE - 235 AC.

E&SPC SITE DETAIL


GENERAL NOTES:

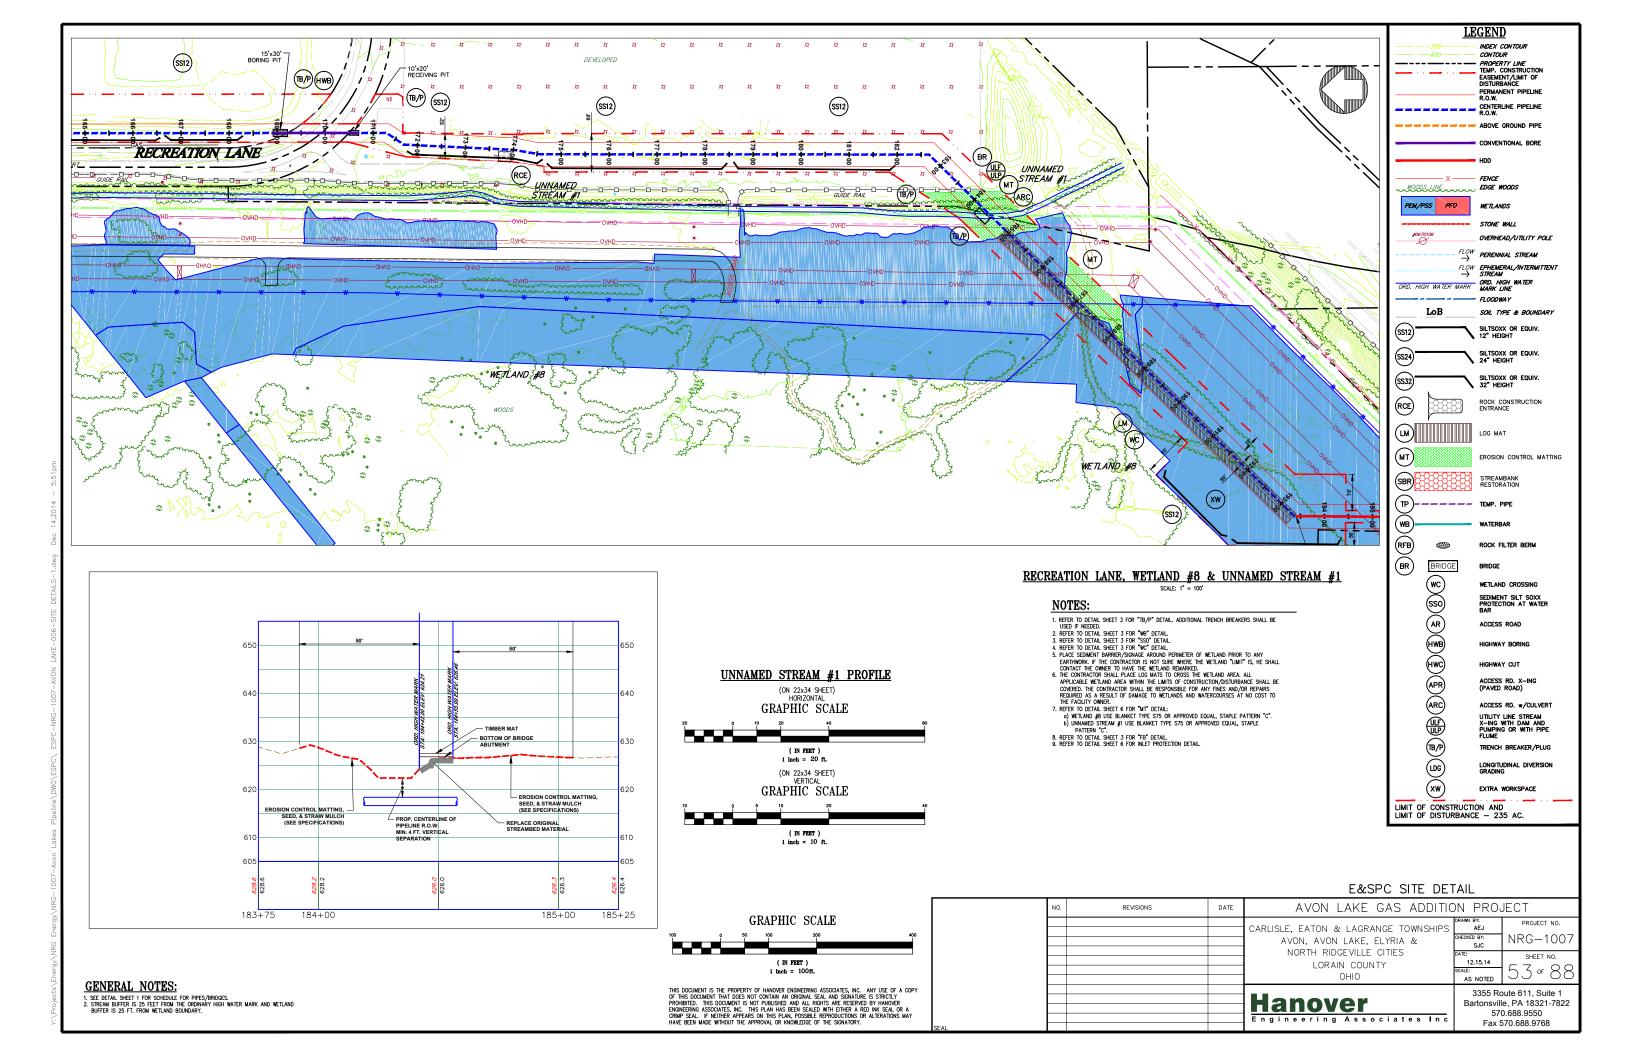

SCALE: 1" = 100"

NOTES:

- PLACE SEDIMENT BARRIER/SIGNAGE AROUND PERIMETER OF WETLAND PRIOR TO ANY EARTHWORK. IF THE CONTRACTOR IS NOT SURE WHERE THE WETLAND "LIMIT" IS, HE SHALL CONTACT THE OWNER TO HAVE THE WETLAND REMARKED.
 REFER TO DETAIL SHEET 3 FOR "FB" DETAIL.

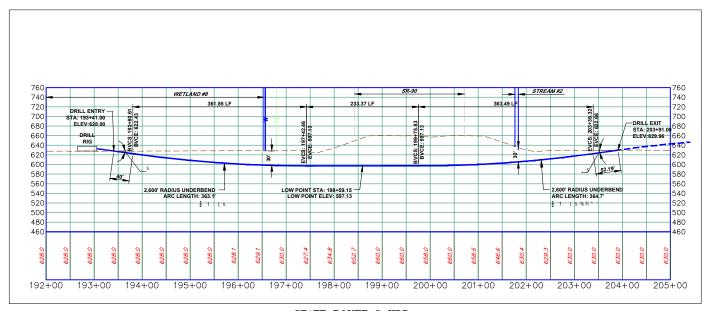

STATE ROUTE 2 HDD



<u>LEGEND</u> INDEX CONTOUR CONTOUR PROPERTY LINE
TEMP. CONSTRUCTION
EASEMENT/LIMIT OF
DISTURBANCE PERMANENT PIPELINE R.O.W.

CENTERLINE PIPELINE R.O.W. ABOVE GROUND PIPE

FENCE

WETLANDS

WOODS LINE WOODS

ORD. HIGH WATER MARK ORD. HIGH WATER MARK LINE

LM LOG MAT

PEM/PSS PFO

(SS12)*

(SS24)

SS32

RCE

(MT)

SBR

(TP)

RFB BR

LIMIT OF CONSTRUCTION AND LIMIT OF DISTURBANCE - 235 AC.

CONVENTIONAL BORE

OVERHEAD/UTILITY POLE FLOW PERENNIAL STREAM FLOW EPHEMERAL/INTERMITTENT

STREAM

SOIL TYPE & BOUNDARY

SILTSOXX OR EQUIV.

SILTSOXX OR EQUIV. 24" HEIGHT

SILTSOXX OR EQUIV. 32" HEIGHT

STREAMBANK RESTORATION

ROCK FILTER BERM

WETLAND CROSSING SEDIMENT SILT SOXX PROTECTION AT WATER BAR

ACCESS ROAD

HIGHWAY CUT

ACCESS RD. X-ING (PAVED ROAD)

ACCESS RD. w/CULVERT

UTILITY LINE STREAM X-ING WITH DAM AND PUMPING OR WITH PIPE FLUME


TRENCH BREAKER/PLUG

LONGITUDINAL DIVERSION GRADING

ROCK CONSTRUCTION ENTRANCE

EROSION CONTROL MATTING




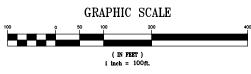


THIS DOCUMENT IS THE PROPERTY OF HANOVER ENGINEERING ASSOCIATES, INC. ANY USE OF A COPY OF THIS DOCUMENT THAT DOES NOT CONTAIN AN ORIGINAL SEAL AND SIGNATURE IS STRICTLY PROHIBITED. THIS DOCUMENT IS NOT PUBLISHED AND ALL RICHARD ARE RESERVED BY HANOVER ENGINEERING ASSOCIATES, INC. THIS PLAN HAS BEEN SEALED WITH EITHER A PEED INK SEAL OR A CRIMP SEAL. IF NEITHER APPEARS ON THIS PLAN, POSSIBLE REPRODUCTIONS OR ALTERATIONS MAY HAVE BEEN MADE WITHOUT THE APPROVAL OR NONDIEDGE OF THE SIGNATORY.

NO.	REVISIONS	DATE	AVON LAKE GAS ADDITION PROJECT				
			CARLISLE, EATON & LAGRANGE TOWNSHIPS AVON, AVON LAKE, ELYRIA & NORTH RIDGEVILLE CITIES I ORAIN COUNTY	DRAWN BY: AEJ CHECKED BY: SJC	PROJECT NO. NRG-1007		
				12.15.14 SCALE: AS NOTED	SHEET NO. 54 OF 88		
			Hanover Engineering Associates Inc	Bartonsvill 570	oute 611, Suite 1 le, PA 18321-7822 0.688.9550 570.688.9768		

GENERAL NOTES:

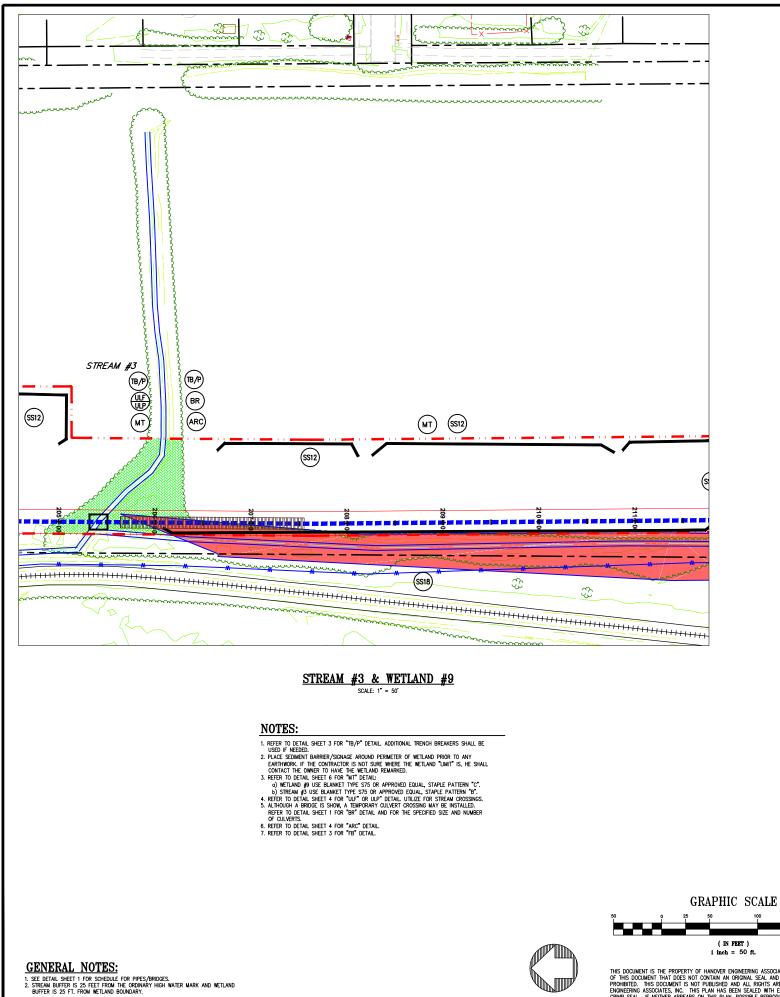

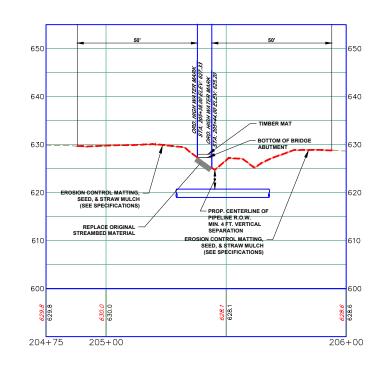

<u>LEGEND</u> INDEX CONTOUR CONTOUR PROPERTY LINE
TEMP. CONSTRUCTION
EASEMENT/LIMIT OF
DISTURBANCE PERMANENT PIPELINE R.O.W. CENTERLINE PIPELINE R.O.W. ABOVE GROUND PIPE

CONVENTIONAL BORE

OVERHEAD/UTILITY POLE FLOW PERENNIAL STREAM

SOIL TYPE & BOUNDARY

FLOW EPHEMERAL/INTERMITTENT

STREAM

SILTSOXX OR EQUIV. 12" HEIGHT

SILTSOXX OR EQUIV. 24" HEIGHT

SILTSOXX OR EQUIV. 32" HEIGHT

STREAMBANK RESTORATION

ROCK FILTER BERM

WETLAND CROSSING SEDIMENT SILT SOXX PROTECTION AT WATER BAR

ACCESS ROAD

HIGHWAY CUT ACCESS RD. X-ING (PAVED ROAD)

ACCESS RD. w/CULVERT

UTILITY LINE STREAM X-ING WITH DAM AND PUMPING OR WITH PIPE FLUME TRENCH BREAKER/PLUG

LONGITUDINAL DIVERSION GRADING

ROCK CONSTRUCTION ENTRANCE

EROSION CONTROL MATTING

FENCE

WETLANDS

WOODS LINE EDGE WOODS

ORD. HIGH WATER MARK ORD. HIGH WATER MARK LINE

LOG MAT

BRIDGE

(\$\\(\mathbb{G}\)\(\mathbb{E}\

LIMIT OF CONSTRUCTION AND LIMIT OF DISTURBANCE - 235 AC.

PEM/PSS PFO

(SS12)*

(SS24)

SS32

RCE

(MT)

SBR

)(RFB)(BR)

STREAM #3 PROFILE


(ON 22x34 SHEET) HORIZONTAL GRAPHIC SCALE (IN PRRT) 1 inch = 20 ft. (ON 22x34 SHEET)
VERTICAL
GRAPHIC SCALE


1 inch = 10 ft.

				E&SPC SITE DET	AIL	
	NO.	REVISIONS	DATE	AVON LAKE GAS ADDITIC	N PROJ	JECT
				CARLISLE, EATON & LAGRANGE TOWNSHIPS AVON, AVON LAKE, ELYRIA & NORTH RIDGEVILLE CITIES LORAIN COUNTY	DRAWN BY: AEJ CHECKED BY: SJC DATE: 12.15.14 SCALE: AS NOTED	PROJECT NO. NRG-1007 SHEET NO. 55 of 88
SFAI				Hanover Engineering Associates Inc	Bartonsvill 570	oute 611, Suite 1 e, PA 18321-7822 0.688.9550 670.688.9768

(IN FERT)

THIS DOCUMENT IS THE PROPERTY OF HANOVER ENGINEERING ASSOCIATES, INC. ANY USE OF A COPY OF THIS DOCUMENT THAT DOES NOT CONTAIN AN ORIGINAL SEAL AND SIGNATURE IS STRICTLY PROHIBITED. THIS DOCUMENT IS NOT PUBLISHED AND ALL RIGHTS ARE RESERVED BY HANOVER ENOINEERING ASSOCIATES, INC. THIS PLAN HAS BEEN SEALED WITH EITHER A FED INK SEAL OR A CRIMP SEAL. IF NEITHER APPEARS ON THIS PLAN, POSSIBLE REPRODUCTIONS OR ALTERATIONS MAY HAVE BEEN MADE WITHOUT THE APPEROVAL OR KNOWLEDGE OF THE SIGNATORY.

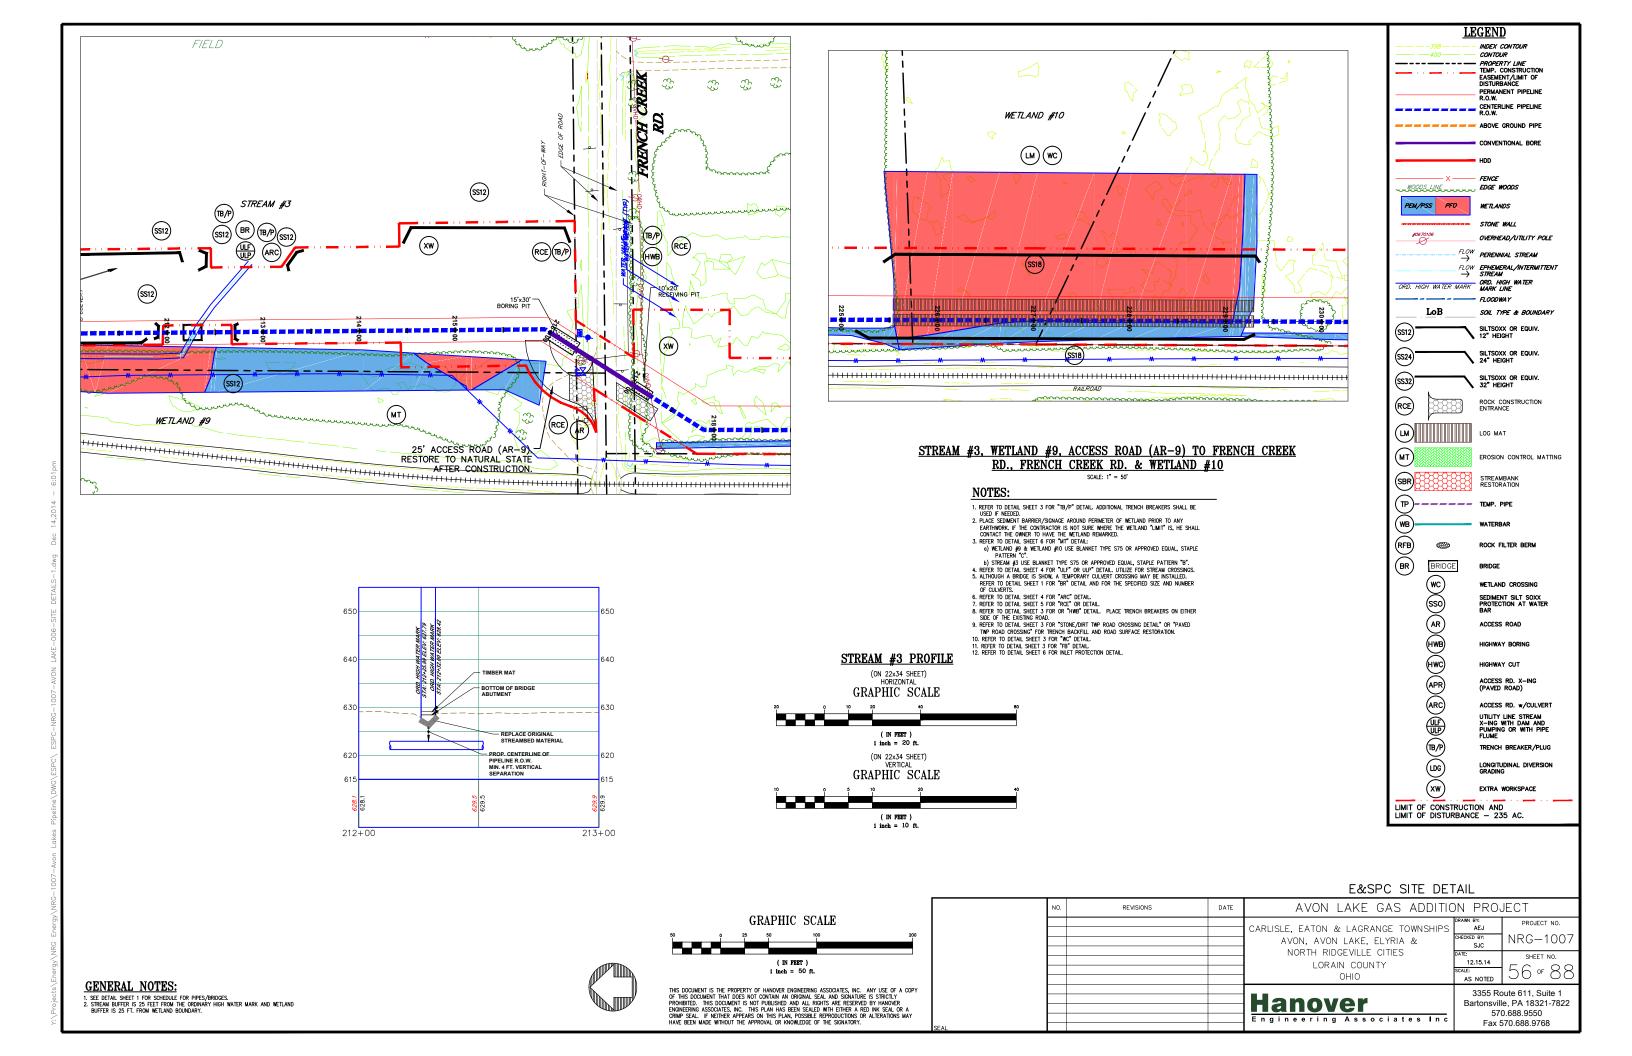

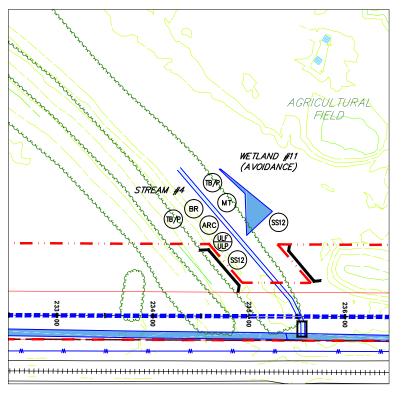

STREAM #4, WETLAND #11 (AVOIDANCE), <u>& WETLAND #12</u>

NOTES:

- 1. REFER TO DETAIL SHEET 3 FOR "TB/P" DETAIL ADDITIONAL TRENCH BREAKERS SHALL BE USED IF NEEDED.

 2. PLACE SEDIMENT BARRIER/SIGNAGE AROUND PERIMETER OF WETLAND PRIOR TO ANY EARTHWORK. IF THE CONTRACTOR IS NOT SURE WHERE THE WETLAND "LIMIT" IS, HE SHALL CONTACT THE OWNER TO HAVE THE WETLAND REMARKED.

 3. REFER TO DETAIL SHEET 6 FOR "INT" DETAIL:

 a) WETLAND \$12 USE BLANKET TYPE 575 OR APPROVED EQUAL, STAPLE PATTERN "C".


 b) STREAM \$4 USE BLANKET TYPE 575 OR APPROVED EQUAL, STAPLE PATTERN "O".


 4. REFER TO DETAIL SHEET 4 FOR "UL" FOR UL" DETAIL LITILEZ FOR STREAM CROSSINGS.


 5. ALTHOUGH A BRODE IS SHOW, A TEMPORARY CULVERT CROSSING MAY BE INSTALLED.

 REFER TO DETAIL SHEET 1 FOR "BY" CETAL, AND FOR THE SPECIFIED SIZE AND NUMBER OF CULVERTS.

 6. REFER TO DETAIL SHEET 1 FOR "BY" CETAL, AND FOR THE SPECIFIED SIZE AND NUMBER
- of culverts. 6. Refer to detail sheet 4 for "Arc" detail. 7. Refer to detail sheet 5 for "RCE" or detail. 8. Refer to detail sheet 3 for "FB" detail.

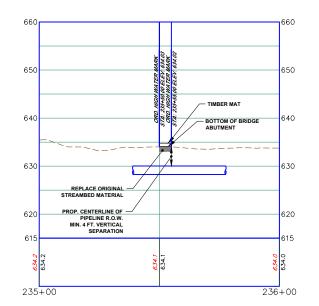

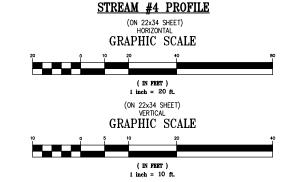

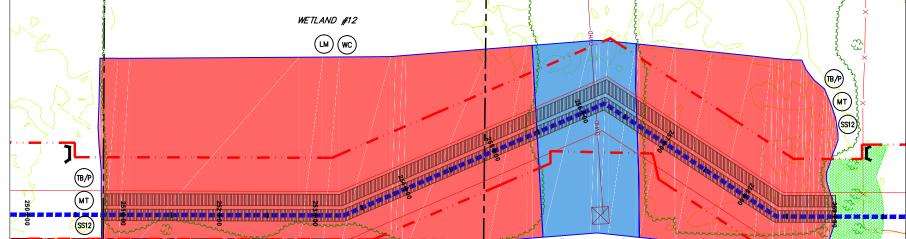

F&SPC SITE DETAIL

<u>LEGEND</u> INDEX CONTOUR CONTOUR

CENTERLINE PIPELINE R.O.W. ABOVE GROUND PIPE

FENCE

WETLANDS STONE WALL OVERHEAD/UTILITY POLE FLOW PERENNIAL STREAM FLOW EPHEMERAL/INTERMITTENT

STREAM

WOODS LINE ... EDGE WOODS

ORD. HIGH WATER MARK ORD. HIGH WATER MARK LINE

LOG MAT

BRIDGE

\(\mathbb{G}\)\(\mathbb{G}\)\(\mathbb{R}\)\(\mathbb{E}\)\(

LIMIT OF CONSTRUCTION AND LIMIT OF DISTURBANCE - 235 AC.

PEM/PSS PFO

(SS12)*

(SS24)

SS32)**

RCE

(MT)

SBR

)(RFB)(BR)

PERMANENT PIPELINE R.O.W.

CONVENTIONAL BORE

SOIL TYPE & BOUNDARY

SILTSOXX OR EQUIV.

SILTSOXX OR EQUIV. 24" HEIGHT

SILTSOXX OR EQUIV. 32" HEIGHT

STREAMBANK RESTORATION

ROCK FILTER BERM

WETLAND CROSSING

ACCESS ROAD

HIGHWAY CUT ACCESS RD. X-ING (PAVED ROAD) ACCESS RD. w/CULVERT UTILITY LINE STREAM X-ING WITH DAM AND PUMPING OR WITH PIPE FLUME

SEDIMENT SILT SOXX PROTECTION AT WATER BAR

TRENCH BREAKER/PLUG

LONGITUDINAL DIVERSION GRADING

ROCK CONSTRUCTION ENTRANCE


EROSION CONTROL MATTING

	C SCALE	RAPHI	G	
2	100	50	25	50
	FERT)	(IN		

THIS DOCUMENT IS THE PROPERTY OF HANOVER ENGINEERING ASSOCIATES, INC. ANY USE OF A COPY OF THIS DOCUMENT THAT DOES NOT CONTAIN AN ORIGINAL SEAL AND SIGNATURE IS STRICTLY PROHIBITED. THIS DOCUMENT IS NOT PUBLISHED AND ALL RICHARD ARE RESERVED BY HANOVER ENGINEERING ASSOCIATES, INC. THIS PLAN HAS BEEN SEALED WITH EITHER A RED HIN SEAL OR A CRIMP SEAL. IF NEITHER APPEARS ON THIS PLAN, POSSIBLE REPRODUCTIONS OR ALTERATIONS MAY HAVE BEEN MADE WITHOUT THE APPROVAL OR KNOMLEDGE OF THE SIGNATORY.

				EXSPC SHE DET	AIL	
	NO.	REVISIONS	DATE	AVON LAKE GAS ADDITIC	N PRO	JECT
				CARLISLE, EATON & LAGRANGE TOWNSHIPS AVON, AVON LAKE, ELYRIA & NORTH RIDGEVILLE CITIES I ORAIN COUNTY	DRAWN BY: AEJ CHECKED BY: SJC DATE: 12.15.14 SCALE: AS NOTED	PROJECT NO. NRG-100 SHEET NO. 5 7 OF 8 8
AL				Hanover Engineering Associates Inc	Bartonsvill 570	oute 611, Suite 1 e, PA 18321-7822 0.688.9550 670.688.9768

GENERAL NOTES:

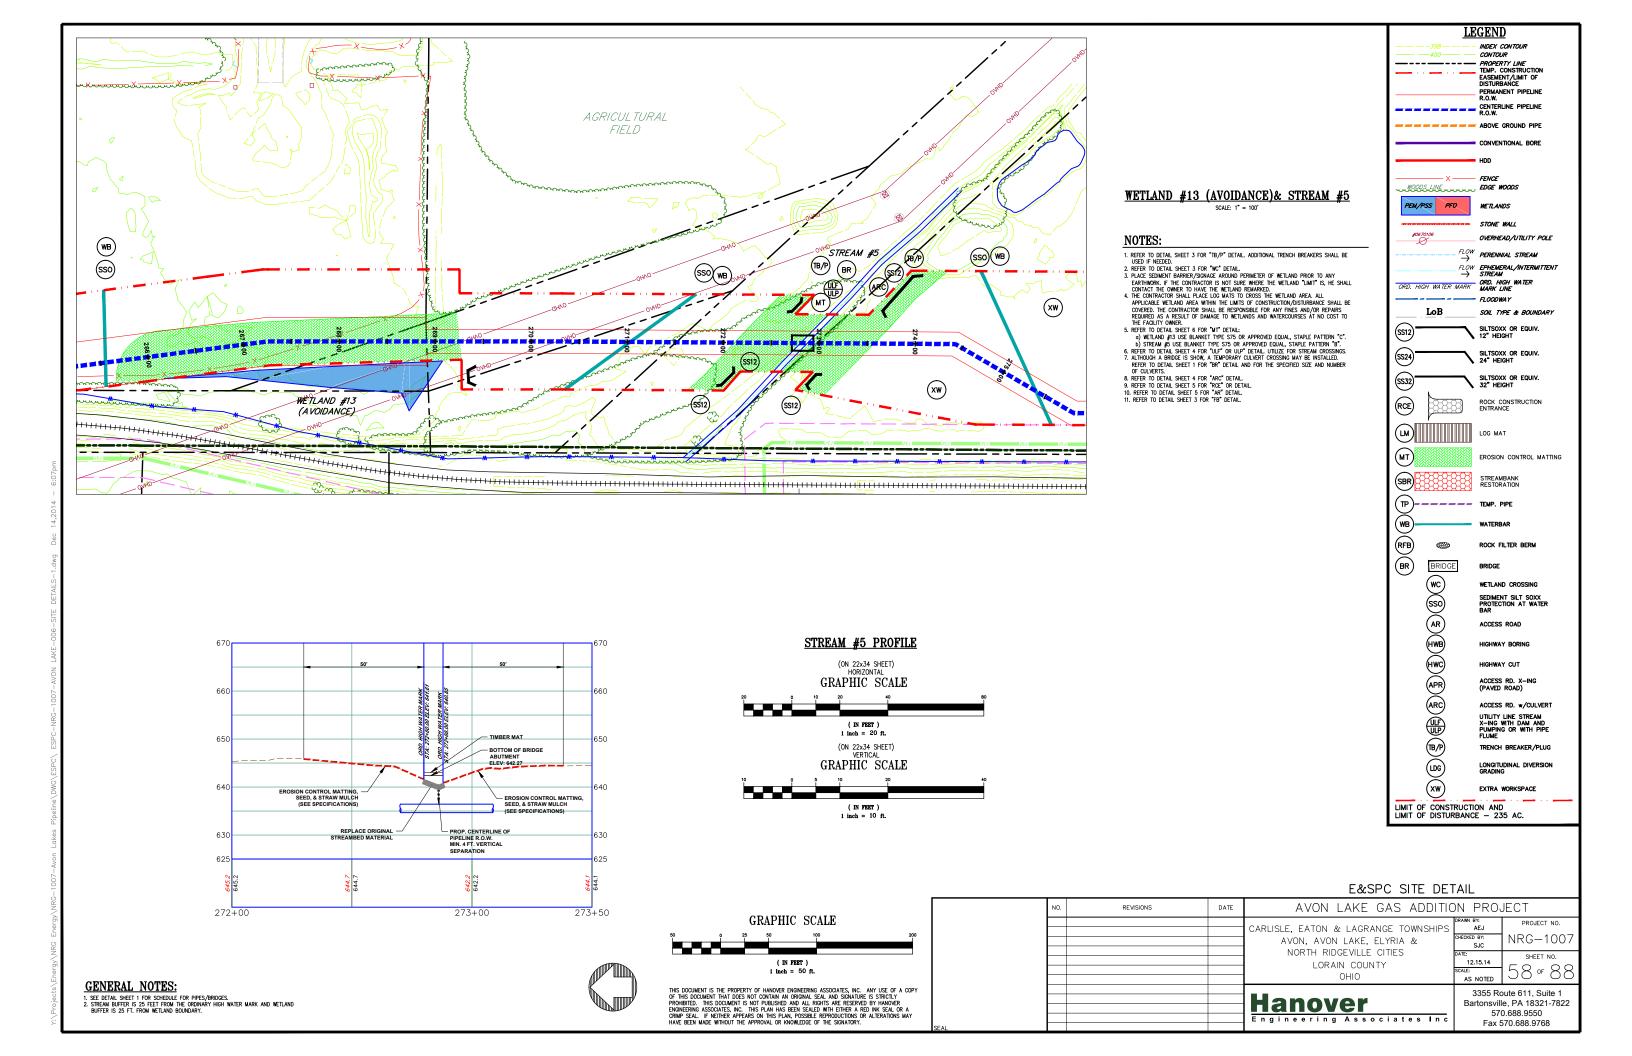

NOTES:

- 1. REFER TO DETAL SHEET 3 FOR "TB/P" DETAIL. ADDITIONAL TRENCH BREAKERS SHALL BE USED IF NEEDED.

 2. REFER TO DETAL SHEET 3 FOR "WB" DETAIL.

 3. REFER TO DETAL SHEET 3 FOR "SSO" DETAIL.

 4. REFER TO DETAL SHEET 5 FOR "SSO" DETAIL.

 5. REFER TO DETAL SHEET 5 FOR "STOR" DETAIL.


 6. REFER TO DETAL SHEET 5 FOR "RO" OF "BOT DETAIL.

 6. REFER TO DETAIL SHEET 5 FOR "STONE/DIRT TWP ROAD CROSSING DETAIL" OR "PAVED TWP ROAD CROSSING" FOR TRENCH BACKFILL AND ROAD SURFACE RESTORATION.

 7. REFER TO DETAIL SHEET 5 FOR "STONE/DIRT TWP ROAD CROSSING DETAIL" OR "PAVED TWP ROAD CROSSING" FOR TRENCH BACKFILL AND ROAD SURFACE RESTORATION.

 8. REFER TO DETAIL SHEET 5 FOR "STONE/DIRT DETAIL.

 8. REFER TO DETAIL SHEET 6 FOR "NILET PROTECTION DETAIL.

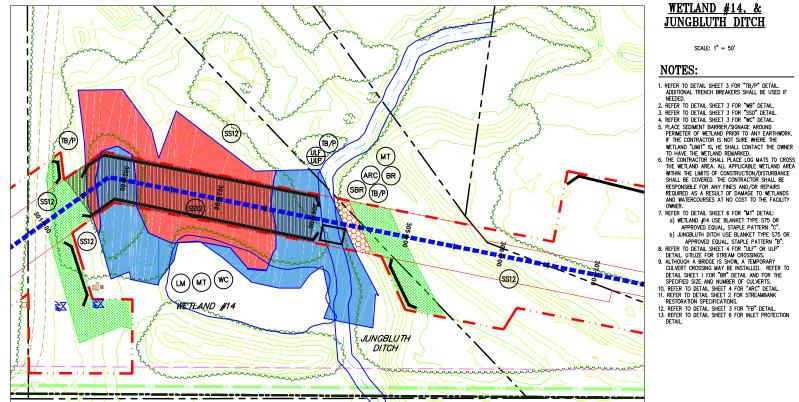

JUNGBLUTH DITCH PROFILE

WETLAND #14, &

JUNGBLUTH DITCH SCALE: 1" = 50'

(ON 22x34 SHEET) HORIZONTAL GRAPHIC SCALE (IN FEET) 1 inch = 20 ft. (ON 22x34 SHEET)
VERTICAL
GRAPHIC SCALE (IN FEET)

RFB BR 1 inch = 10 ft.

ENCOC SITE DETAIL

<u>LEGEND</u> INDEX CONTOUR

ABOVE GROUND PIPE

WOODS LINE ... EDGE WOODS

ORD. HIGH WATER MARK ORD. HIGH WATER MARK LINE

LM LOG MAT

BRIDGE

wc sso

A B A A B B

(B/P)

(LDG)

LIMIT OF CONSTRUCTION AND LIMIT OF DISTURBANCE - 235 AC.

PEM/PSS PFO

SS12)

SS24)

SS32)

RCE

(MT)

SBR

(TP)=

FENCE

WETLANDS

STONE WALL

FLOW PERENNIAL STREAM FLOW EPHEMERAL/INTERMITTENT

STREAM

OVERHEAD/UTILITY POLE

SOIL TYPE & BOUNDARY

SILTSOXX OR EQUIV. 12" HEIGHT

SILTSOXX OR EQUIV. 24" HEIGHT

SILTSOXX OR EQUIV. 32" HEIGHT

STREAMBANK RESTORATION

ROCK FILTER BERM

WETLAND CROSSING SEDIMENT SILT SOXX PROTECTION AT WATER BAR

ACCESS ROAD

HIGHWAY BORING

HIGHWAY CUT

ACCESS RD. X-ING (PAVED ROAD)

ACCESS RD. w/CULVERT UTILITY LINE STREAM X-ING WITH DAM AND PUMPING OR WITH PIPE FLUME

TRENCH BREAKER/PLUG

LONGITUDINAL DIVERSION GRADING

BRIDGE


ROCK CONSTRUCTION ENTRANCE

EROSION CONTROL MATTING

CONTOUR PROPERTY LINE
TEMP. CONSTRUCTION
EASEMENT/LIMIT OF
DISTURBANCE

PERMANENT PIPELINE R.O.W. CENTERLINE PIPELINE R.O.W.

CONVENTIONAL BORE

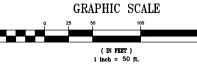

303+50

THIS DOCUMENT IS THE PROPERTY OF HANOVER ENGINEERING ASSOCIATES, INC. ANY USE OF A COPY OF THIS DOCUMENT THAT DOES NOT CONTAIN AN ORIGINAL SEAL AND SIGNATURE IS STRICTLY PROHIBITED. THIS DOCUMENT IS NOT PUBLISHED AND ALL RIGHTS ARE RESERVED BY HANOVER ENOINEERING ASSOCIATES, INC. THIS PLAN HAS BEEN SEALED WITH EITHER A FED INK SEAL OR A CRIMP SEAL. IF NEITHER APPEARS ON THIS PLAN, POSSIBLE REPRODUCTIONS OR ALTERATIONS MAY HAVE BEEN MADE WITHOUT THE APPEROVAL OR KNOWLEDGE OF THE SIGNATORY.

			E&SPC SHE DET	AIL	
NO.	REVISIONS	DATE	AVON LAKE GAS ADDITIC	N PRO	JECT
			CARLISLE, EATON & LAGRANGE TOWNSHIPS AVON, AVON LAKE, ELYRIA & NORTH RIDGEVILLE CITIES I ORAIN COUNTY	DRAWN BY: AEJ CHECKED BY: SJC DATE: 12.15.14 SCALE: AS NOTED	PROJECT NO. NRG-1007 SHEET NO. 5 9 of 88
			Hanover Engineering Associates Inc	Bartonsvill 570	oute 611, Suite 1 e, PA 18321-7822 0.688.9550 670.688.9768

305+00

690 ___ 15' ___ LIVE STAKES /SHRUB PLANTINGS (SEE SPECIFICATIONS WETLAND #14 680 TIMBER MAT -EROSION CONTROL MATTING SEED, & STRAW MULCH (SEE SPECIFICATIONS) PROP. CENTERLINE OF PIPELINE R.O.W. MIN. 4 FT. VERTICAL SEPARATION

304+00



GENERAL NOTES:




NOTES:

- ADDITIONAL THENCH BREAKERS SHALL BE USED IF NEEDED.

 2. REFER TO DETAIL SHEET 3 FOR "NO" DETAIL ADDITIONAL TRENCH BREAKERS SHALL BE USED IF NEEDED.

 2. REFER TO DETAIL SHEET 3 FOR "NO" DETAIL SHEET 3 FOR "NO" DETAIL SHEET 3 FOR "NO" DETAIL SHEET 3 FOR THE SHEET SH
- 5. REFER TO DETAIL SHEET 6 FOR "MT" DETAIL: a) WETLAND #15 USE BLANKET TYPE S75 OR
 APPROVED EQUAL, STAPLE PATTERN "C".
 REFER TO DETAIL SHEET 3 FOR "FB" DETAIL.

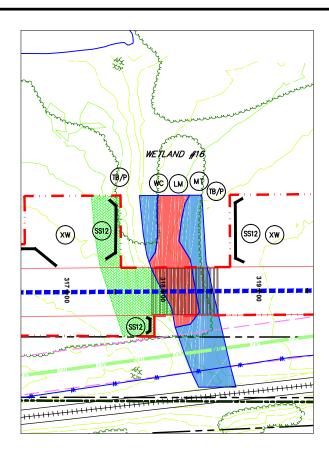

WETLAND #16,

NOTES:


- 1. REFER TO DETAIL SHEET 3 FOR "TB/P" DETAIL ADDITIONAL TRENCH BREAKERS SHALL BE USED IF NEEDED.

 2. REFER TO DETAIL SHEET 3 FOR "NC" DETAIL.

 5. PLACE SEDIMENT BARRIER/SIGNAGE AROUND PERMIETER OF WELTAND FROM TO ANY EARTHWORK. IF THE CONTRACTOR IS NOT SURE WHERE THE WETLAND KIMIT" IS, HE SHALL CONTACT THE OWNER TO HAVE THE WETLAND REMARKED.

 6. THE CONTRACTOR SHALL PLACE LOG MATS TO CROSS THE WETLAND AREA. ALL APPLICABLE WETLAND AREA ANTHIN THE LUMITS OF CONSTRUCTION SURFEMENTION OF SHALL PROPULABLE.
- WITHIN THE LIMITS OF CONSTRUCTION/DISTURBANCE
 SHALL BE COVERED. THE CONTRACTOR SHALL BE
 RESPONSIBLE FOR ANY FINES AND/OR REPAIRS
 REQUIRED AS A RESULT OF DAMAGE TO WETLANDS
 AND WATERCOURSES AT NO COST TO THE FACILITY
- 7. REFER TO DETAIL SHEET 6 FOR "MT" DETAIL: WETLAND #16 USE BLANKET TYPE 575 OR
 APPROVED EQUAL, STAPLE PATTERN "C".


 REFER TO DETAIL SHEET 3 FOR "FB" DETAIL.

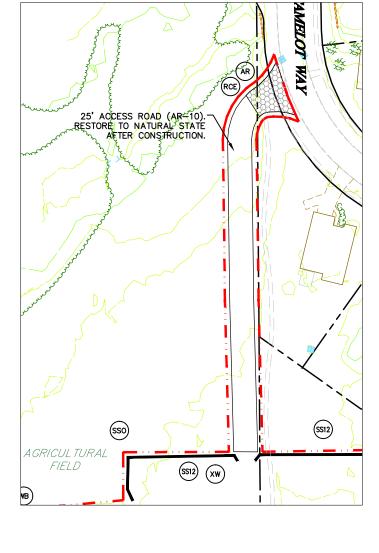


ACCESS ROAD (AR-10) TO CAMELOT WAY SCALE: 1" = 50'


NOTES:

- REFER TO DETAIL SHEET 5 FOR "RCE" OR DETAIL.
 REFER TO DETAIL SHEET 5 FOR "AR" DETAIL.
 REFER TO DETAIL SHEET 3 FOR "FB" DETAIL.

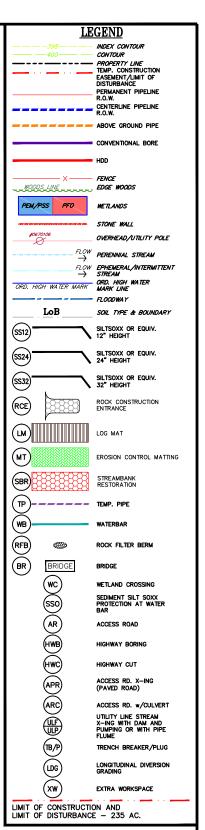

E&SPC SITE DETAIL

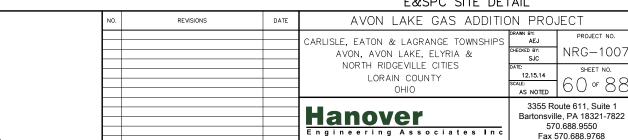

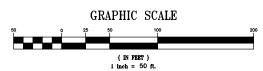

THIS DOCUMENT IS THE PROPERTY OF HANOVER ENGINEERING ASSOCIATES, INC. ANY USE OF A COPY OF THIS DOCUMENT THAT DOES NOT CONTAIN AN ORIGINAL SEAL AND SIGNATURE IS STRICTLY PROHIBITED. THIS DOCUMENT IS NOT PUBLISHED AND ALL RIGHTS ARE RESERVED BY HANOVER ENOINEERING ASSOCIATES, INC. THIS PLAN HAS BEEN SEALED WITH EITHER A FED INK SEAL OR A CRIMP SEAL. IF NEITHER APPEARS ON THIS PLAN, POSSIBLE REPRODUCTIONS OR ALTERATIONS MAY HAVE BEEN MADE WITHOUT THE APPEROVAL OR KNOWLEDGE OF THE SIGNATORY.

GENERAL NOTES:

This foregoing document was electronically filed with the Public Utilities

Commission of Ohio Docketing Information System on

12/19/2014 12:54:51 PM

in

Case No(s). 14-1717-GA-BLN

Summary: Application of NRG Ohio Pipeline Company LLC continued - Attachment K (Part 5) electronically filed by Teresa Orahood on behalf of Sally Bloomfield